PROJECT DESCRIPTION


THIS PROJECT ENTAILS THE RENOVATION AND EXPANSION OF THE CITY OF TAYLOR ANIMAL SHELTER. THE CURRENT SHELTER OCCUPIES 5.200 SF OF THE EXISTING BUILDING. THIS EXISTING 5,200 SF WILL BE RENOVATED AND A NEW 9,020 SF BUILDING ADDITION WILL BE CONSTRUCTED TO EXAPND THE ANIMAL SHELTER TO 14,220 SF.

SITE IMPROVEMENTS/ALTERATIONS WILL INCLUDE NEW WALKWAYS, DOG RUNS, AND LANDSCAPING.

ZONING INFORMATION

CURRENT ZONING:	I-1 LIGHT INDUSTRIAL DISTRICT
PROPOSED ZONING:	I-1 LIGHT INDUSTRIAL DISTRICT
SETBACKS:	50' FRONT YARD SETBACK (EXISTING TO REMAIN AS-IS) 10' SIDE YARD (EXISTING TO REMAIN AS-IS) 10' REAR YARD (EXISTING TO REMAIN AS-IS)
EXISTING PARKING:	117 PARKING SPACES
REQUIRED PARKING:	TOTAL = 75 SPACES (SEE BREAKDOWN BELOW)
ANIMAL SHELTER :	1 PER 400SF USEABLE PLUS 2 PER EMPLOYEE 14,220SF X 80% = 11,376 / 400SF = 28 SPACES 12 EMPLOYEES 2 = 24
FIRING RANGE:	1.2 SPACES PER 300SF USEABLE 5,000SF X 80% = 4,000 / 300 = 13.3 X 1.2 = 16 SPACES (PREVIOUSLY APPROVED IN 1994)
MAINTENANCE AREA:	1 PER 1500SF GROSS 10,260SF / 1500 = 7 SPACES (PREVIOUSLY APPROVED IN 1994)
LANDSCAPING:	WILL COMPLY REFER TO LANDSCAPING PLAN L-100

PROJECT LOCATION: 25555 NORTHLINE ROAD

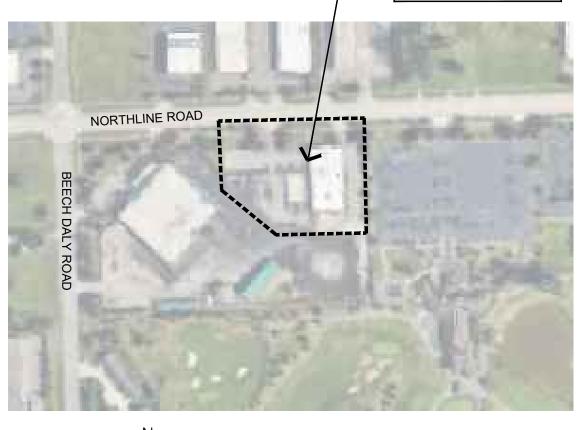

LOCATION MAP SCALE: NONE

PROJECT DATA

PROPERTY ADDRESS:
PROPERTY OWNER:
PROPERTY USER/TENANT:
CURRENT BUILDING SIZE:
PROPOSED BUILDING SIZE
CURRENT USE:
PROPOSED USE:

25555 NORTHLINE RD CITY OF TAYLOR CITY OF TAYLOR 20,460 SF (ANIMAL SHELTER PORTION 5,200 SF)

E: 29,480 SF (ANIMAL SHELTER PORTION 14,220 SF) ANIMAL SHELTER, FIRING RANGE, MAINTENANCE ANIMAL SHELTER, FIRING RANGE, MAINTENANCE

	CODE SUMMARY
CODE:	2015 MICHIGAN BUILDING CODE 2015 MICHIGAN PLUMBING CODE 2015 MICHIGAN MECHANICAL CODE 2015 MICHIGAN ELECTRICAL CODE BARRIER FREE ICC/ANSI 117.1 (2009)
USE GROUP (MIXED):	S-1 (STORAGE WAREHOUSE) B (ANIMAL SHELTER AND FIRING RANGE)
CONSTRUCTION TYPE:	2В
ALLOWABLE AREA:	S-1 = 70,000 SF / B = 92,000 SF
ALLOWABLE HEIGHT:	S-1 = 3 STORIES / B = 4 STORIES
OCCUPANT LOAD:	WAREHOUSES = 1 PER 500 SF 9,665 SF / 500 = 19 OCCUPANTS
	BUSINESS = 1 PER 100 SF 665 SF (FIRING RANGE, FIRING AREA) / 100
	BUSINESS = 1 PER 100 SF 5,200 SF (ANIMAL SHELTER, HUMAN AREA
OCCUPANCY SEPARATION:	NO SEPARATION REQUIRED BETWEEN 'B' (MBC TABLE 508.4)
FIRE SUPPRESSION:	FULLY SUPPRESSED
EGRESS TRAVEL:	USE S-1: 250 FT USE B: 300 FT COMPLY: SEE LIFE SAFETY DRAWING LS-7
PLUMBING FIXTURES:	S-1 (MAINTENANCE AREA): EXISTING FIXT B (FIRING RANGE): EXISTING FIXTURES TO
	B (ANIMAL SHELTER): BASED ON THE SF SPACES OF 4800 S
	TOILETS1 per 1005 REQUIREDLAVATORIES1 per 1005 REQUIREDSERVICE SINK11 REQUIREDDRINKING FTN.11 REQUIRED

CONSTRUCTION PHASING

THE GENERAL CONTRACTOR SHALL CONSTRUCT THIS PROJECT IN TWO PRIMARY PHASES. PHASE 1 SHALL INCLUDE THE CONSTRUCTION OF THE BUILDING ADDTION. PHASE 2 SHALL INCLUDE THE RENOVATION OF THE EXISTING ANIMAL SHELTER FOOTPRINT. SITE WORK CAN BE PERFORMED WITHIN EITHER OR BOTH PHASES AS DESIRED BY THE GENERAL CONTRACTOR. THE GENERAL CONTRACTOR SHALL ACCOUNT FOR THIS 2 PHASED CONSTRUCTION APPROACH WITHIN THEIR BID.

BID ALTERNATES

BID ALTERNATE 1

SKYLIGHTS: GC SHALL PROVIDE A DEDUCTIVE COST ALTERNATE FOR THE ELIMINATION OF THE SKYLIGHTS WITHIN THE GUN RANGE CORRIDOR #158 AND HALLWAY #120. THIS COST SHALL INCLUDE THE SKYLIGHTS, ROOF CURBS, SUPPORT AND SUPPORT STEEL.

CITY OF TAYLOR ANIMAL SHELTER

25555 NORTHLINE ROAD

TAYLOR, MI 48180

- REMODEL & EXPANSION -100% Complete - City Plan Review

GENERAL NOTES ALL WORK SHALL BE DONE IN ACCORDANCE WITH ALL LOCAL, STATE, AND COUNTY CODES / ORDINANCES AND BUILDING REGULATIONS OF THE CITY OF FERNDALE / OSHA / AND THE INSTRUCTIONS OF INSPECTING AUTHORITIES. THE GENERAL CONTRACTOR (GC) SHALL VISIT THE PREMISES AND SHALL BECOME THOROUGHLY FAMILIAR WITH THE CONDITIONS PRIOR TO COMMENCEMENT OF WORK. 3. THE OWNER SHALL CONFIRM THE GENERAL CONTRACTORS (GC) SCOPE OF WORK. 4. THE GC SHALL PROMPTLY NOTIFY THE OWNER AND ARCHITECT OF ANY AMBIGUITY, INCONSISTENCY OR ERROR WHICH HE MAY DISCOVER UPON EXAMINATION OF THE DOCUMENTS OR OF THE SITE. 5. GC SHALL INCLUDE COSTS OF ALL PERMITS AND RELATED FEES. 6. ALL PRODUCT/MATERIAL SUBSTITUTIONS SHALL BE APPROVED BY ARCHITECT/OWNER 7. DO NOT SCALE DRAWINGS, USE ONLY THE DIMENSIONS PROVIDED. . FIELD VERIFY ALL DIMENSIONS. ACTUAL FIELD CONDITIONS MAY REQUIRE MODIFICATIONS TO THE CONSTRUCTION DETAILS, MATERIAL QUANTITIES AND EXTENT OF THE CONSTRUCTION WORK SHOWN ON THE DRAWINGS. THE CONTRACTOR SHALL PERFORM THE WORK TO MEET FIELD CONDITIONS ENCOUNTERED. 9. GC SHALL BE RESPONSIBLE FOR SAFETY ON THIS PROJECT, INCLUDING ALL NECESSARY SIGNS, BARRIERS AND SUPERVISION. 10. GC SHALL PROVIDE ALL LABOR, MATERIALS, INSURANCE, EQUIPMENT, INSTALLATION, TOOLS, TRANSPORTATION, ETC. FOR A COMPLETE & PROPER COMPLETION OF THE PROJECT AS INDICATED ON THE DRAWINGS & AS SPECIFIED HEREIN. 11. DURING CONSTRUCTION, GC SHALL MAINTAIN EXISTING MEANS OF EGRESS AND PASSAGEWAYS CLEAR OF OBSTRUCTIONS. TAKE ALL PRECAUTIONS NECESSARY TO INSURE THE SAFETY OF THE GENERAL PUBLIC AND WORKERS. 12. GC SHALL BE RESPONSIBLE TO PROTECT ADJACENT PRIVATE AND PUBLIC PROPERTY FROM DAMAGE DURING CONSTRUCTION. 13. COORDINATION AND SEQUENCE OF CONSTRUCTION IS THE RESPONSIBILITY OF THE GC. 00 = 7 OCCUPANTS 14. THE LOCATION OF ALL UTILITIES INDICATED HEREIN ARE APPROXIMATE ONLY AND WERE LOCATED FROM SOURCES BELIEVED TO BE RELIABLE, BUT NO GUARANTEE IS EXPRESSED OR IMPLIED AS TO LOCATION. THE CONTRACTOR SHALL MAKE HIS OWN INVESTIGATION AS A) / 100 = 52 OCCUPANTS TO THE EXTENT OF THESE OR OTHER UTILITIES, AND SHALL BE RESPONSIBLE FOR PROTECTION AND RESTORATION OF SAME IF DAMAGED AS A RESULT OF HIS OPERATIONS. 3' AND 'S-1' 15. OWNER SHALL HAVE FIRST CLAIM TO ALL SALVAGEABLE ITEMS. 16. GC SHALL CONSULT WITH OWNER REGARDING STORAGE OF ON SITE MATERIALS AND ACCESS TO SITE. 17. ALL MATERIALS AND EQUIPMENT SHALL BE NEW AND IN PERFECT CONDITION WHEN INSTALLED AND SHALL BE OF THE BEST GRADE AND OF THE SAME MANUFACTURER -100 THROUGHOUT FOR EACH CLASS OR GROUP OF EQUIPMENT. TURES TO REMAIN AS-IS. 18. ALL EXISTING CONSTRUCTION, EQUIPMENT AND FINISHES TO REMAIN SHALL BE O REMAIN AS-IS. PROTECTED DURING CONSTRUCTION. F OF HUMAN OCCUPIED 19. GC SHALL PERFORM ALL DEMOLITION REQUIRED FOR INSTALLATION OF NEW ITEMS. FIELD VERIFY ITEMS TO BE DEMOLISHED. ANY DISCREPANCIES OR QUESTIONABLE ITEMS SHOULD BE BROUGHT TO THE OWNER/ARCHITECT'S ATTENTION. GC SHALL REMOVE ALL 8 PROVIDED DEBRIS FROM SITE AND LEGALLY DISPOSE OF. 8 PROVIDED 5 PROVIDED 20. GC SHALL PROVIDE A WRITTEN GUARANTEE THAT WILL BE MADE GOOD AT GC'S OWN D NONE PROVIDED EXPENSE FOR ANY IMPERFECTIONS IN MATERIAL AND/OR WORKMANSHIP WHICH MY DEVELOP WITHIN (1) ONE YEAR FROM FINAL ACCEPTANCE. FURTHER, THIS GC SHALL OBTAIN WRITTEN GUARANTEES FROM ALL MANUFACTURERS STATING ON WHAT OPERATING CONDITIONS & PERFORMANCE CAPACITIES EACH EQUIPMENT PIECE GUARANTEE IS BASED. **BID ALLOWNACES BID ALLOWANCE 1** CARPORT: GC SHALL INCLUDE AN ADD ALLOWANCE OF \$25,000 FOR A OPEN CARPORT WITHIN THE EAST PARKING LOT. BID ALLOWANCE 2 DOG RUN STORAGE BINS: GC SHALL INCLUDE AN ADD ALLOWANCE OF \$1,600 FOR 2 STORAGE BINS WITHIN THE OUTDOOR DOG RUN AREA. **BID ALLOWANCE 3** EXTERIOR STORAGE SHED: GC SHALL INCLUDE AN ADD ALLOWANCE OF \$12,000 FOR STORAGE SHED WITHIN THE EAST PARKING LOT. **BID ALLOWANCE 4** EXTERIOR SIGNS: GC SHALL INCLUDE AN ADD ALLOWANCE OF \$14,000 FOR EXTERIOR SIGNS. BID ALLOWANCE 5 APPLIANCES: GC SHALL INCLUDE AN ADD ALLOWANCE OF \$12,000 FOR APPLIANCES. BID ALLOWANCE 5 ARTIFICIAL PLANTS: GC SHALL INCLUDE AN ADD ALLOWANCE OF \$2,500 FOR INTERIOR ARTIFICIAL PLANTS. BID ALLOWANCE 6 HAZARDOUS MATERIALS TESTING: GC SHALL INCLUDE AN ADD ALLOWANCE OF \$4,000 FOR TESTING OF SUSPECT MATERIALS SUCH AS ASBESTOS. **BID ALLOWANCE 7** ACOUSTIC WALL PANELS: GC SHALL INCLUDE AN ADD ALLOWANCE OF \$7,500 FOR WALL MOUNTED ACOUSTIC PANELS WITHIN THE CANINE KENNEL AREAS.

NO.	SHEET TITLE
	GENERAL
CS-001	COVER SHEET / DRAWING INDEX / CODE SUMMARY
CS-003	ABBREVIATIONS / SYMBOLS / MOUNTING HEIGHTS
LS-100	LIFE SAFETY PLAN
0.400	
C-100	EXISTING TOPOGRAPHICAL SURVEY DEMOLITION SITE PLAN
C-110 C-120	PROPOSED SITE PLAN
C-120	ENLARGED SITE PLAN
C-130	PROPOSED GRADING PLAN
C-140	PROPOSED UTILITY PLAN
C-150	GENERAL NOTES & DETAILS
L-100	LANDSCAPE PLAN
	CITY OF TAYLOR STANDARDS
MD-1	STANDARD MISC. DETAILS
SE-1	STANDARD SESC DETAILS
SS-1	STANDARD SANITARY SEWER DETAILS
SS-2	STANDARD SANITARY SEWER DETAILS
ST-1	STANDARD STORM SEWER DETAILS
WM-1	STANDARD WATER MAIN DETAILS
WM-2	STANDARD WATER MAIN DETAILS
15.440	ARCHITECTURE
AD-110	DEMOLITION FLOOR PLANS
AD-120	DEMOLITION ROOF PLAN
AD-130 A-111	DEMOLITION ELEVATIONS
A-111 A-112	FLOOR PLAN ENLARGED FLOOR PLAN
A-112 A-113	ENLARGED FLOOR PLAN
A-114	ENLARGED FLOOR PLAN
A-120	ROOF PLAN
A-200	ELEVATIONS
A-300	PLAN DETAILS
A-301	PLAN DETAILS
A-400	INTERIOR ELEVATIONS
A-401	INTERIOR ELEVATIONS
A-510	REFLECTED CEILING PLAN
A-600	BUILDING SECTIONS
A-701	WALL SECTIONS
A-702	WALL SECTIONS
A-703	WALL SECTIONS
A-704	WALL SECTIONS
A-705	WALL SECTIONS
A-800	
A-801	
A-900 A-901	DOOR SCHEDULE DOOR, FRAME, & WINDOW TYPES
A-901 A-902	ROOM FINISH SCHEDULE
A-902	FLOOR PATTERN PLAN
	STRUCTURAL
S-000	STRUCTURAL GENERAL NOTES
S-001	STRUCTURAL GENERAL NOTES
S-100	FOUNDATION PLAN
S-200	STRUCTURAL FRAMING PLAN
S-201	STRUCTURAL LINTEL PLAN
S-801	STRUCTURAL DETAILS
S-802	STRUCTURAL DETAILS



CITY

REVIEW

1/17/24

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SHEET INDEX



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Client:

City of Taylor 23555 Goddard Rd. Taylor, MI 48180


Project:

City of Taylor Animal Shelter Remodel & Expansion

25555 Northline Rd.

Taylor, MI 48180


Seal:

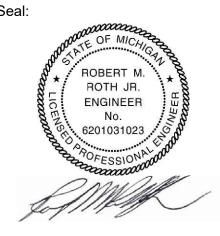

Date	Issued For
9-13-2023	25% Complete Review
0-18-2023	50% Complete Review
2-21-2023	Owner Review
1-17-2024	Permit Review


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Approved:	MR
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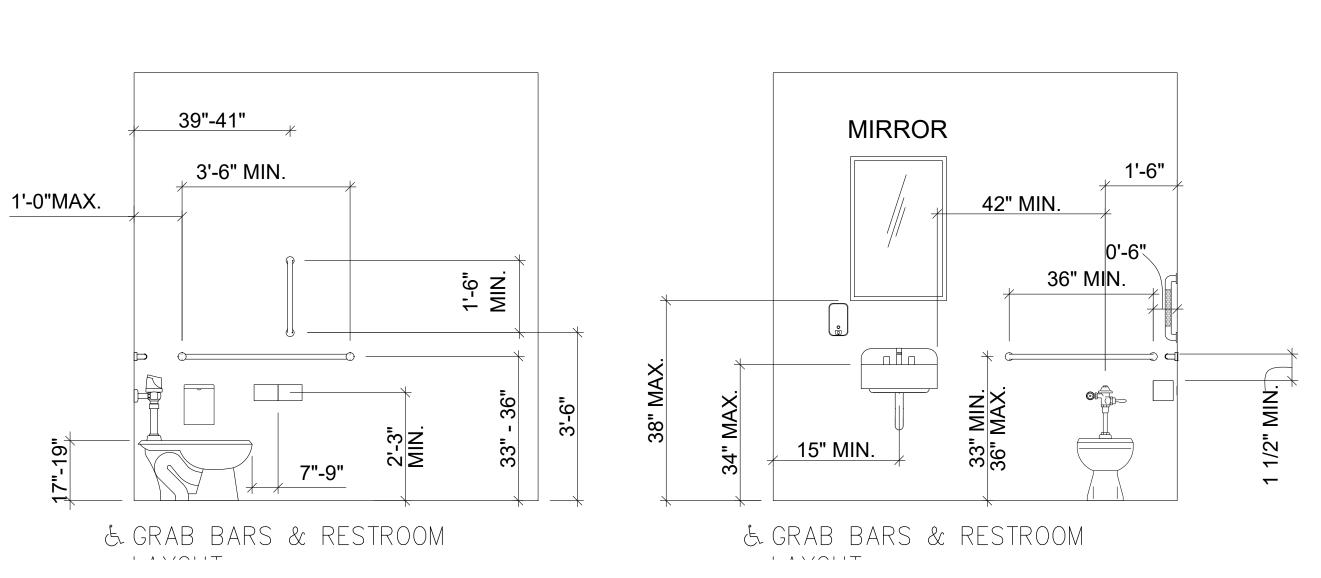
Sheet Title: **COVER SHEET &** DRAWING INDEX

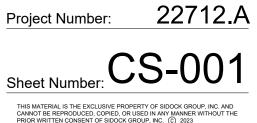

NO.	SHEET TITLE	CITY REVIEV 1/17/24
	MECHANICAL	
M-110	MECHANICAL DEMOLITION FLOOR PLANS	•
M-111	OVERALL HVAC FLOOR PLAN	•
M-112	HVAC FLOOR PLAN - WEST	•
M-113	HVAC FLOOR PLAN - EAST	•
M-114	HVAC FLOOR PLAN - SOUTH	•
M-900	HVAC SCHEDULES	•
	PLUMBING	
PD-110	PLUMBING & PIPING DEMOLITION FLOOR PLANS	•
PD-111	OVERALL PLUMBING & PIPING FLOOR PLANS	•
PD-112	PLUMBING & PIPING FLOOR PLAN - WEST	•
PD-113	PLUMBING & PIPING FLOOR PLAN - EAST	•
PD-114	PLUMBING & PIPING FLOOR PLAN - SOUTH	•
PD-900	PLUMBING & PIPING SCHEDULES & DIAGRAMS	•
	ELECTRICAL	
ES-100	ELECTRICAL SITE PLAN	•
ED-110	ELECTRICAL DEMOLITION FLOOR PLAN	•
ED-120	ELECTRICAL DEMOLITION ROOF PLAN	•
ED-600	ELECTRICAL DEMOLITION RISER DIAGRAM	•
EL-111	OVERALL ELECTRICAL LIGHTING FLOOR PLAN	•
EL-112	ENLARGED ELECTRICAL LIGHTING PLAN	•
EL-113	ENLARGED ELECTRICAL LIGHTING PLAN	•
EL-114	ENLARGED ELECTRICAL LIGHTING PLAN	•
EL-600	ELECTRICAL LIGHTING FIXTURE SCHEDULE	•
EP-111	OVERALL ELECTRICAL POWER FLOOR PLAN	•
EP-112	ENLARGED ELECTRICAL POWER PLAN	•
EP-113	ENLARGED ELECTRICAL POWER PLAN	•
EP-114	ENLARGED ELECTRICAL POWER PLAN	•
EP-212	ENLARGED ELECTRICAL MECH POWER PLAN	•
EP-213	ENLARGED ELECTRICAL MECH POWER PLAN	•
EP-220	ELECTRICAL POWER ROOF PLAN	•
EP-600	ELECTRICAL ONE LINE DIAGRAM	•
EP-601	ELECTRICAL GROUNDING DETAILS	•
EP-602	ELECTRICAL PANEL SCHEDULES	•

M-110	MECHANICAL DEMOLITION FLOOR PLANS	•
M-111	OVERALL HVAC FLOOR PLAN	•
M-112	HVAC FLOOR PLAN - WEST	•
M-113	HVAC FLOOR PLAN - EAST	•
M-114	HVAC FLOOR PLAN - SOUTH	•
M-900	HVAC SCHEDULES	•
	PLUMBING	
PD-110	PLUMBING & PIPING DEMOLITION FLOOR PLANS	•
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PD-113	PLUMBING & PIPING FLOOR PLAN - EAST	•
PD-114	PLUMBING & PIPING FLOOR PLAN - SOUTH	•
PD-900	PLUMBING & PIPING SCHEDULES & DIAGRAMS	•
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EP-113	ENLARGED ELECTRICAL POWER PLAN	•
EP-114	ENLARGED ELECTRICAL POWER PLAN	•
EP-212	ENLARGED ELECTRICAL MECH POWER PLAN	•
EP-213	ENLARGED ELECTRICAL MECH POWER PLAN	•
EP-220	ELECTRICAL POWER ROOF PLAN	•
EP-600	ELECTRICAL ONE LINE DIAGRAM	•
EP-601	ELECTRICAL GROUNDING DETAILS	•
EP-602	ELECTRICAL PANEL SCHEDULES	•
	M-111 M-112 M-113 M-114 M-900 PD-110 PD-110 PD-111 PD-112 PD-113 PD-114 PD-900 ED-110 ED-110 ED-120 ED-110 ED-120 ED-110 ED-120 ED-600 EL-111 EL-112 EL-113 EL-114 EL-112 EL-113 EL-114 EL-112 EP-111 EP-112 EP-113 EP-114 EP-212 EP-213 EP-213	M-111OVERALL HVAC FLOOR PLANM-112HVAC FLOOR PLAN - WESTM-113HVAC FLOOR PLAN - EASTM-114HVAC FLOOR PLAN - SOUTHM-900HVAC SCHEDULESPLUMBINGPD-110PLUMBING & PIPING DEMOLITION FLOOR PLANSPD-111OVERALL PLUMBING & PIPING FLOOR PLANPD-112PLUMBING & PIPING FLOOR PLAN - WESTPD-113PLUMBING & PIPING FLOOR PLAN - EASTPD-114PLUMBING & PIPING FLOOR PLAN - SOUTHPD-900PLUMBING & PIPING SCHEDULES & DIAGRAMSELECTRICALES-100ELECTRICAL SITE PLANED-110ELECTRICAL DEMOLITION FLOOR PLANED-110ELECTRICAL DEMOLITION ROOF PLANED-110ELECTRICAL DEMOLITION ROOF PLANED-111OVERALL ELECTRICAL LIGHTING FLOOR PLANEL-112ENLARGED ELECTRICAL LIGHTING FLOOR PLANEL-113ENLARGED ELECTRICAL LIGHTING PLANEL-114ENLARGED ELECTRICAL LIGHTING PLANEP-111OVERALL ELECTRICAL LIGHTING PLANEP-112ENLARGED ELECTRICAL POWER FLOOR PLANEP-113ENLARGED ELECTRICAL POWER PLANEP-114ENLARGED ELECTRICAL POWER PLANEP-212ENLARGED ELECTRICAL MECH POWER PLANEP-213ENLARGED ELECTRICAL MECH POWER PLANEP-200ELECTRICAL ONE LINE DIAGRAMEP-600ELECTRICAL ONE LINE DIAGRAMEP-601ELECTRICAL ONE LINE DIAGRAMEP-601ELECTRICAL GROUNDING DETAILS



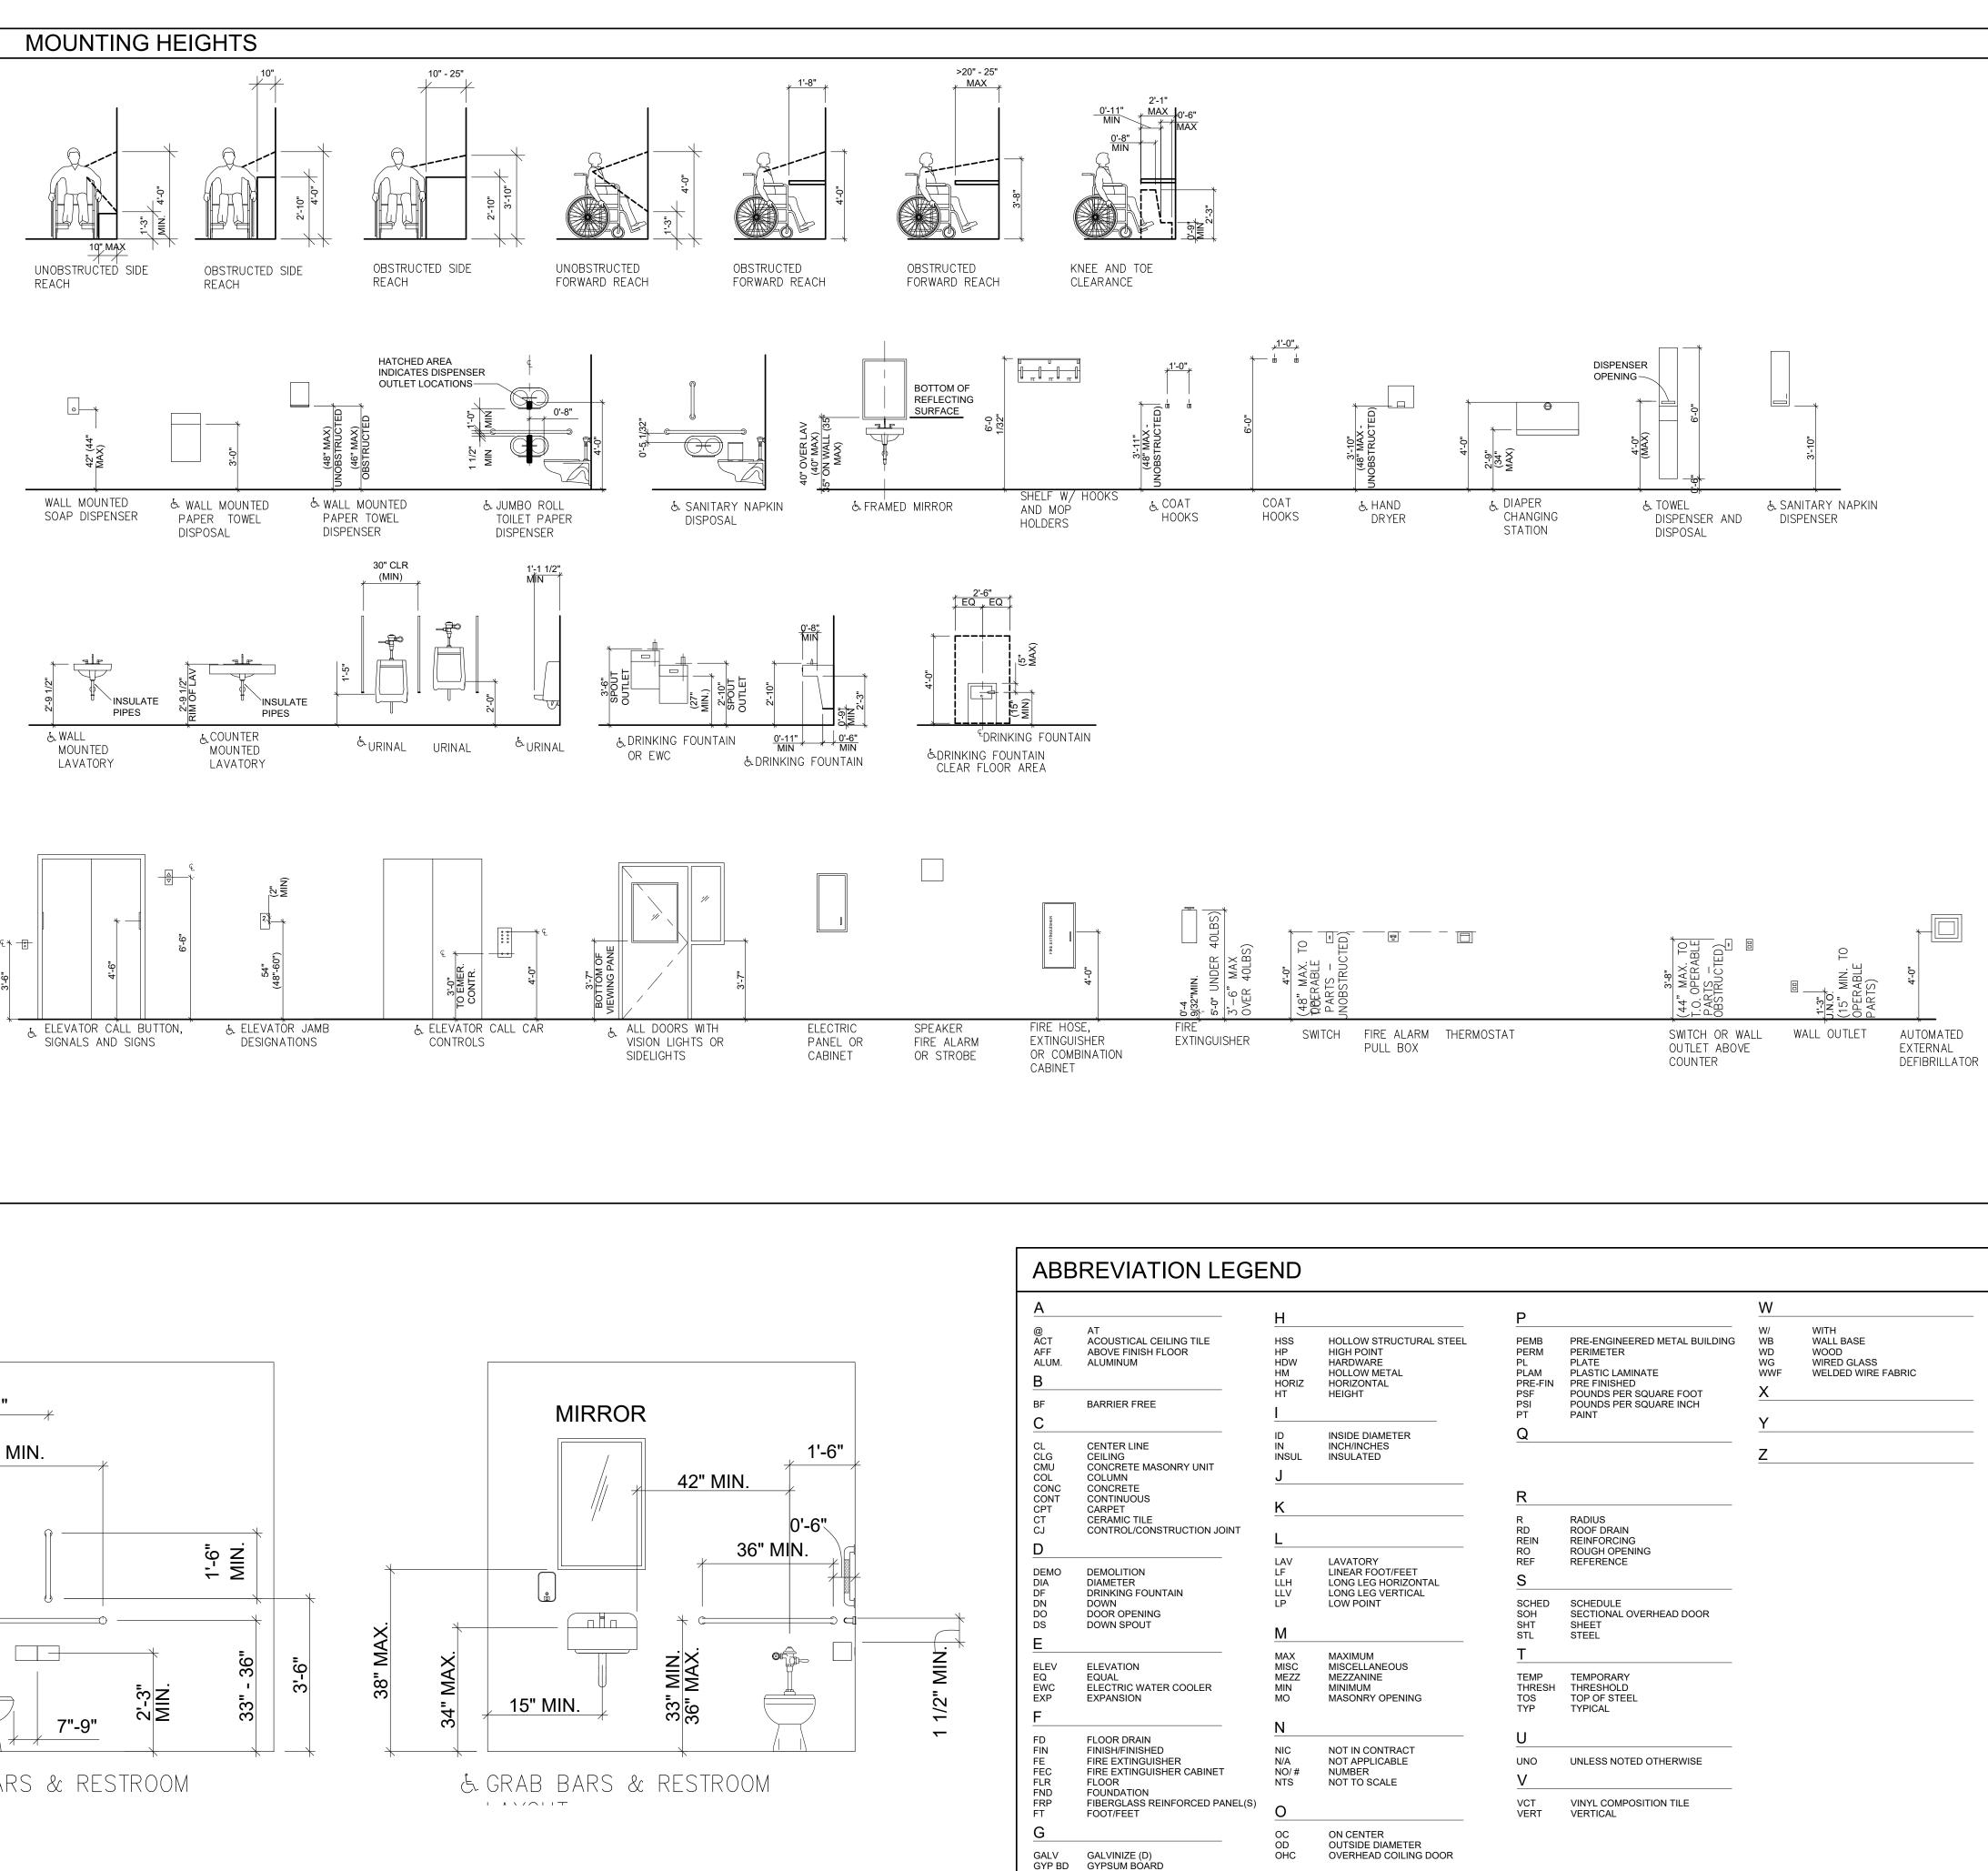

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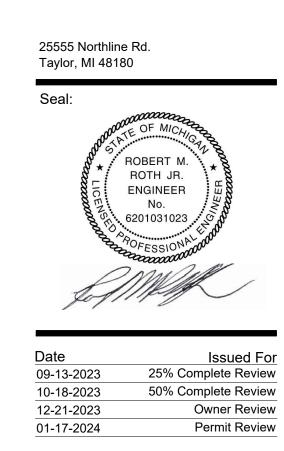
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Project:

City of Taylor Animal Shelter Remodel & Expansion




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Approved:	MR


Sheet Title: ABBREVIATIONS / SYMBOLS / MOUNTING HEIGHTS

Project Number: 22712.A

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SECOND FLOOR PLAN

SCALE: 1/8" = 1'-0"

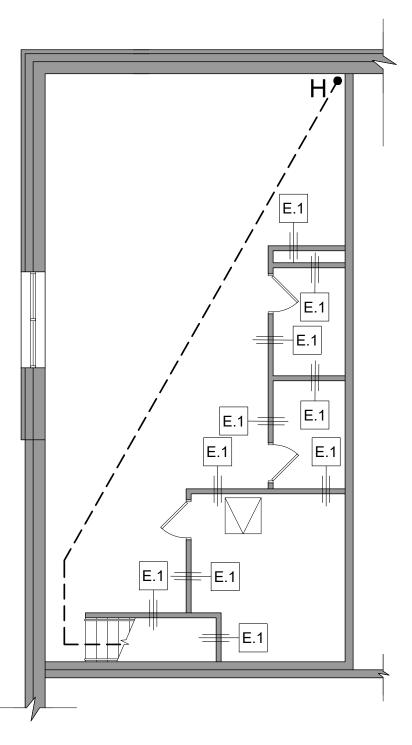WALL TYPES

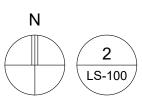PROPOSED WALLS

3-5/8" STUD WALLS

- 3-5/8" MTL. STUDS @ 16" O.C. FROM FIN. FLR. TO 8" ABOVE FINISH
 CEILING W/ (1) LAYER 5/8" GYP. BD. EA SIDE W/ SOUND ATTENUATING UNFACED BATT INSULATION WITHIN CAVITIES (FULL HEIGHT).
- 2 3-5/8" MTL. STUDS @ 16" O.C. FROM FIN. FLR. TO 8" ABOVE FINISH CEILING W/ (1) LAYER 5/8" GYP. BD. EA SIDE W/ 1/2" RESILIENT CHANNELS BENEATH GYP. BD. ONE SIDE W/ SOUND ATTENUATING UNFACED BATT INSULATION WITHIN CAVITIES (FULL HEIGHT).
- 3-5/8" MTL. STUDS @ 16" O.C. FROM FIN. FLR. TO UNDERSIDE OF DECK ABOVE W/ (1) LAYER 5/8" GYP. BD. EA SIDE W/ SOUND ATTENUATING UNFACED BATT INSULATION WITHIN CAVITIES (FULL HEIGHT).
- 3-5/8" MTL. STUDS @ 16" O.C. FROM FIN. FLR. TO UNDERSIDE OF DECK
 ABOVE W/ (1) LAYER 5/8" GYP. BD. EA SIDE W/ 1/2" RESILIENT CHANNELS
 BENEATH GYP. BD. ONE SIDE W/ SOUND ATTENUATING UNFACED BATT INSULATION WITHIN CAVITIES (FULL HEIGHT).
- 3-5/8" MTL. STUDS @16" O.C. FROM FIN. FLR. TO 7'-4"ABOVE FIN. FLR. W/
 (1) LAYER 5/8" GYP. BD. EA SIDE. UNFACED BATT INSULATION WITHIN
 6" STUD WALLS
- 6" MTL. STUDS @ 16" O.C. FROM FIN. FLR. TO 8" ABOVE FINISH CEILING W/ (1) LAYER 5/8" GYP. BD. EA SIDE W/ SOUND ATTENUATING UNFACED BATT INSULATION WITHIN CAVITIES (FULL HEIGHT).
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- 6" MTL. STUDS @ 16" O.C. FROM FIN. FLR. TO 7'-4" ABOVE FIN. FLR. W/ (1) LAYER 5/8" GYP. BD. EA SIDE. UNFACED BATT INSULATION WITHIN CMU WALLS
- 8" CMU WALL TO 8" ABOVE FINISH CEILING W/ PAINTED FINISH BOTH SIDES. REFER TO STRUCTURAL DRAWINGS FOR REINFORCING REQUIREMENTS.
- 8" CMU WALL FROM FIN. FLR. TO 7'-4" ABOVE FIN. FLR. W/ PAINTED FINISH BOTH SIDES. REFER TO STRUCTURAL DRAWINGS FOR REINFORCING REQUIREMENTS.
- 12" CMU WALL TO HEIGHT OF PARAPET WALL W/ PAINTED FINISH BOTH SIDES AT INTERIOR. REFER TO STRUCTURAL PLANS FOR REINFORCING REQUIREMENTS. REFER TO WALL SECTIONS FOR ANY EXTERIOR FINISHES.
- 12" CMU WALL FROM FIN. FLR. TO UNDERSIDE OF DECK ABOVE W/ PAINTED FINISH BOTH SIDES AT INTERIOR. REFER TO STRUCTURAL PLANS FOR REINFORCING REQUIREMENTS. REFER TO WALL SECTIONS FOR ANY EXTERIOR FINISHES.

INTERIOR FURRING

- 2" MTL. FURRING STUDS AT 16" O.C. ON FACE OF EXTERIOR WALL TO 8" ABOVE FINISH CEILING W/ (1) LAYER 5/8" GYP. BD. ON INTERIOR W/ 2" RIGID INSULATION WITHIN STUD CAVITIES.
- EXISTING WALLS
- E.1 EXISTING 3-1/2" STL. STUDS @ 16" O.C. FROM FIN. FLR. TO UNDERSIDE OF DECK ABOVE W/ (1) LAYER 5/8" GYP. BD. EA SIDE
- E.2 EXISTING 8" CMU WALL FROM FIN. FLR. TO UNDERSIDE OF DECK ABOVE




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^{Client:} City of Taylor 23555 Goddard Rd. Taylor, MI 48180



MAX. TRAVEL DISTANCE

6 1/2"	A2 = 108'-4"
0"	B2 = 94'-7"
-8"	C2 = 141'-0"
-6"	D2 = 95'-4.5"
0"	E2 = 124'-0"
'-5 1/2"	F2 = 155'-3"
-6"	G2 = 91'-1"
)'-9 1/2"	H2 = 190'-7 1/2"

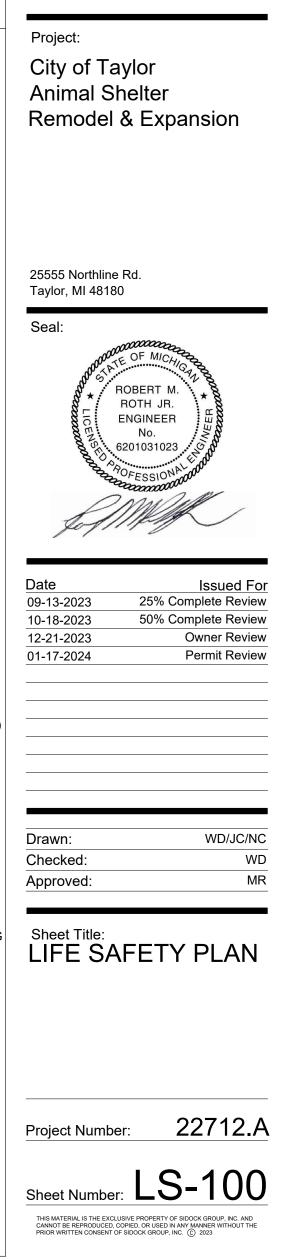WALL TYPE SYMBOL (SEE WALL TYPES LIST ON THIS SHEET LS-100)

EXISTING WALL

NEW PARTITION WALL

NEW MASONRY WALL


NOT IN CONTRACT NO WORK IN THIS ROOM

NEW DOOR

EXISTING DOOR



-(10)

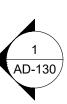

GENERAL DEMOLITION NOTES:

- A. COORDINATE ALL ARCHITECTURAL, STRUCTURAL, MECHANICAL, AND ELECTRICAL DEMOLITION DRAWINGS ACCORDINGLY.
- B. THESE DEMOLITION NOTES AND PLANS DO NOT FULLY REPRESENT ALL DEMOLITION WORK REQUIRED TO INSTALL NEW WORK IN ACCORDANCE WITH CONTRACT DOCUMENTS, BUT ARE INTENDED TO SERVE AS GENERAL DEMOLITION GUIDELINES. REFER TO ARCHITECTURAL, STRUCTURAL, MECHANICAL, AND ELECTRICAL DRAWINGS FOR LOCATIONS OF INCIDENTAL DEMOLITION WORK NOT INDICATED ON THIS PLAN.
- C. THE CONTRACTOR IS RESPONSIBLE FOR ALL ITEMS TO BE SALVAGED AND RELOCATED, INCLUDING SAFE STORAGE OF SAME. UPON DEMOLITION, THE OWNER SHALL RETAIN THOSE ITEMS DEEMED SALVAGEABLE. ITEMS NOT RETAINED SHALL BECOME THE PROPERTY OF THE CONTRACTOR WHO SHALL LEGALLY DISPOSE OF SAME.
- D. WHERE ITEMS ARE REMOVED, PATCH SURFACES TO MATCH ADJACENT SURFACES OR NEW FINISHES WHERE SCHEDULED. PATCHING OF NEW OR EXISTING FINISHES SHALL EXTEND TO NEAREST NATURAL BREAK OR TERMINATION FOR A CLEAN UNBLEMISHED APPEARANCE AT THE END OF CONSTRUCTION.
- DISCONNECT AND REMOVE ALL ITEMS AS INDICATED OR AS E. OTHERWISE REQUIRED TO CLEAR AREA FOR NEW WORK.
- CONTRACTOR IS RESPONSIBLE FOR SAFETY ON THIS PROJECT (PROVIDE BARRICADES, WARNING SIGNS, ETC).
- G. PROVIDE ALL DUST CURTAINS AND TEMPORARY PARTITIONS AS REQUIRED TO PROTECT EXISTING BUILDING DURING CONSTRUCTION.
- H. DEMOLITION SHALL INCLUDE BUT NOT BE LIMITED TO THIS SHEET. SEE ADDITIONAL SHEETS FOR FURTHER INFORMATION.
- MECHANICAL DUCT WORK TO BE REMOVED. FILL OR REPAIR EXISTING MECHANICAL WALL OPENINGS AS REQUIRED. REFER TO MECHANICAL DRAWINGS FOR PLACEMENT OF NEW OR REUSED OPENINGS.
- J. PLUMBING TO BE REMOVED TO CONCEALED AREA AND CAPPED. REFER TO ARCHITECTURAL & PLUMBING DRAWINGS FOR PLACEMENT OF NEW FIXTURES & DRAINS.
- K. ALL ELECTRICAL FIXTURES, WIRING, CONDUIT AND HOUSINGS TO BE REMOVED BACK TO ELECTRICAL PANEL. REFER TO ARCHITECTURAL & ELECTRICAL DRAWINGS FOR PLACEMENT OF NEW FIXTURES, RECEPTACLES, SWITCHES, ETC.

DEMOLITION PLAN NOTES:

- (1) REMOVE DOOR AND FRAME.
- (2) REMOVE OVERHEAD DOOR AND ASSOCIATED
- TRACKS/EQUIPMENT. (3) REMOVE MASONRY WALL.
- (4) REMOVE STUD FRAMED WALL
- (5) REMOVE LOW MASONRY KENNEL WALL AND ASSOCIATED KENNEL FENCING/GATES.
- (6) REMOVE FINISH FLOORING.
- (7) REMOVE FINISH CEILING.
- (8) REMOVE PLUMBING FIXTURE.
- (9) REMOVE MILLWORK.
- (10) REMOVE PORTION OF WALL TO CREATE NEW OPENING.
- (11) REMOVE WINDOW.
- (12) REMOVE EXTERIOR MASONRY WALL.
- (13) REMOVE COLUMNS AND AWNING ABOVE.
- (14) REMOVE INTERIOR WALL FURRING.
- (15) REMOVE EXISTING FOOTING
- (16) EXISTING FOOTING
- (17) EXISTING COLUMN PAD FOOTING
- (18) EXISTING CONCRETE FLOOR SLAB TO REMAIN
- (19) EXISTING SANITARY PIPING SHOWN FOR REFERENCE. REFER TO PLUMBING PLANS.
- (20) NEW FLOOR DRAINS SHOWN FOR REFERENCE. REFER TO PLUMBING PLANS.
- (21) APPROXIMATE LOCATION AND SIZE OF CONCRETE FLOOR SLAB TO BE REMOVED AS NEEDED TO INSTALL NEW FLOOR DRAINS AND ASSOCIATED PIPING.
- (22) REMOVE EXISTING DOOR. FRAME TO REMAIN
- (23) REMOVE EXISTING DOMESTIC WATER HEATER

LEGEND:

	ELEVATION SYMBOL
(X)	KEY NOTE
	EXISTING WALL
<u> </u>	APPROXIMATE LOCATION OF EXISTING CONCRETE TO BE SAWCUT
	ITEM TO BE REMOVED
N.I.C.	NOT IN CONTRACT. NO WORK IN THIS AREA



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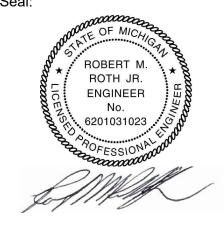
Client: City of Taylor 23555 Goddard Rd. Taylor, MI 48180

Project:

City of Taylor Animal Shelter Remodel & Expansion

25555 Northline Rd. Taylor, MI 48180


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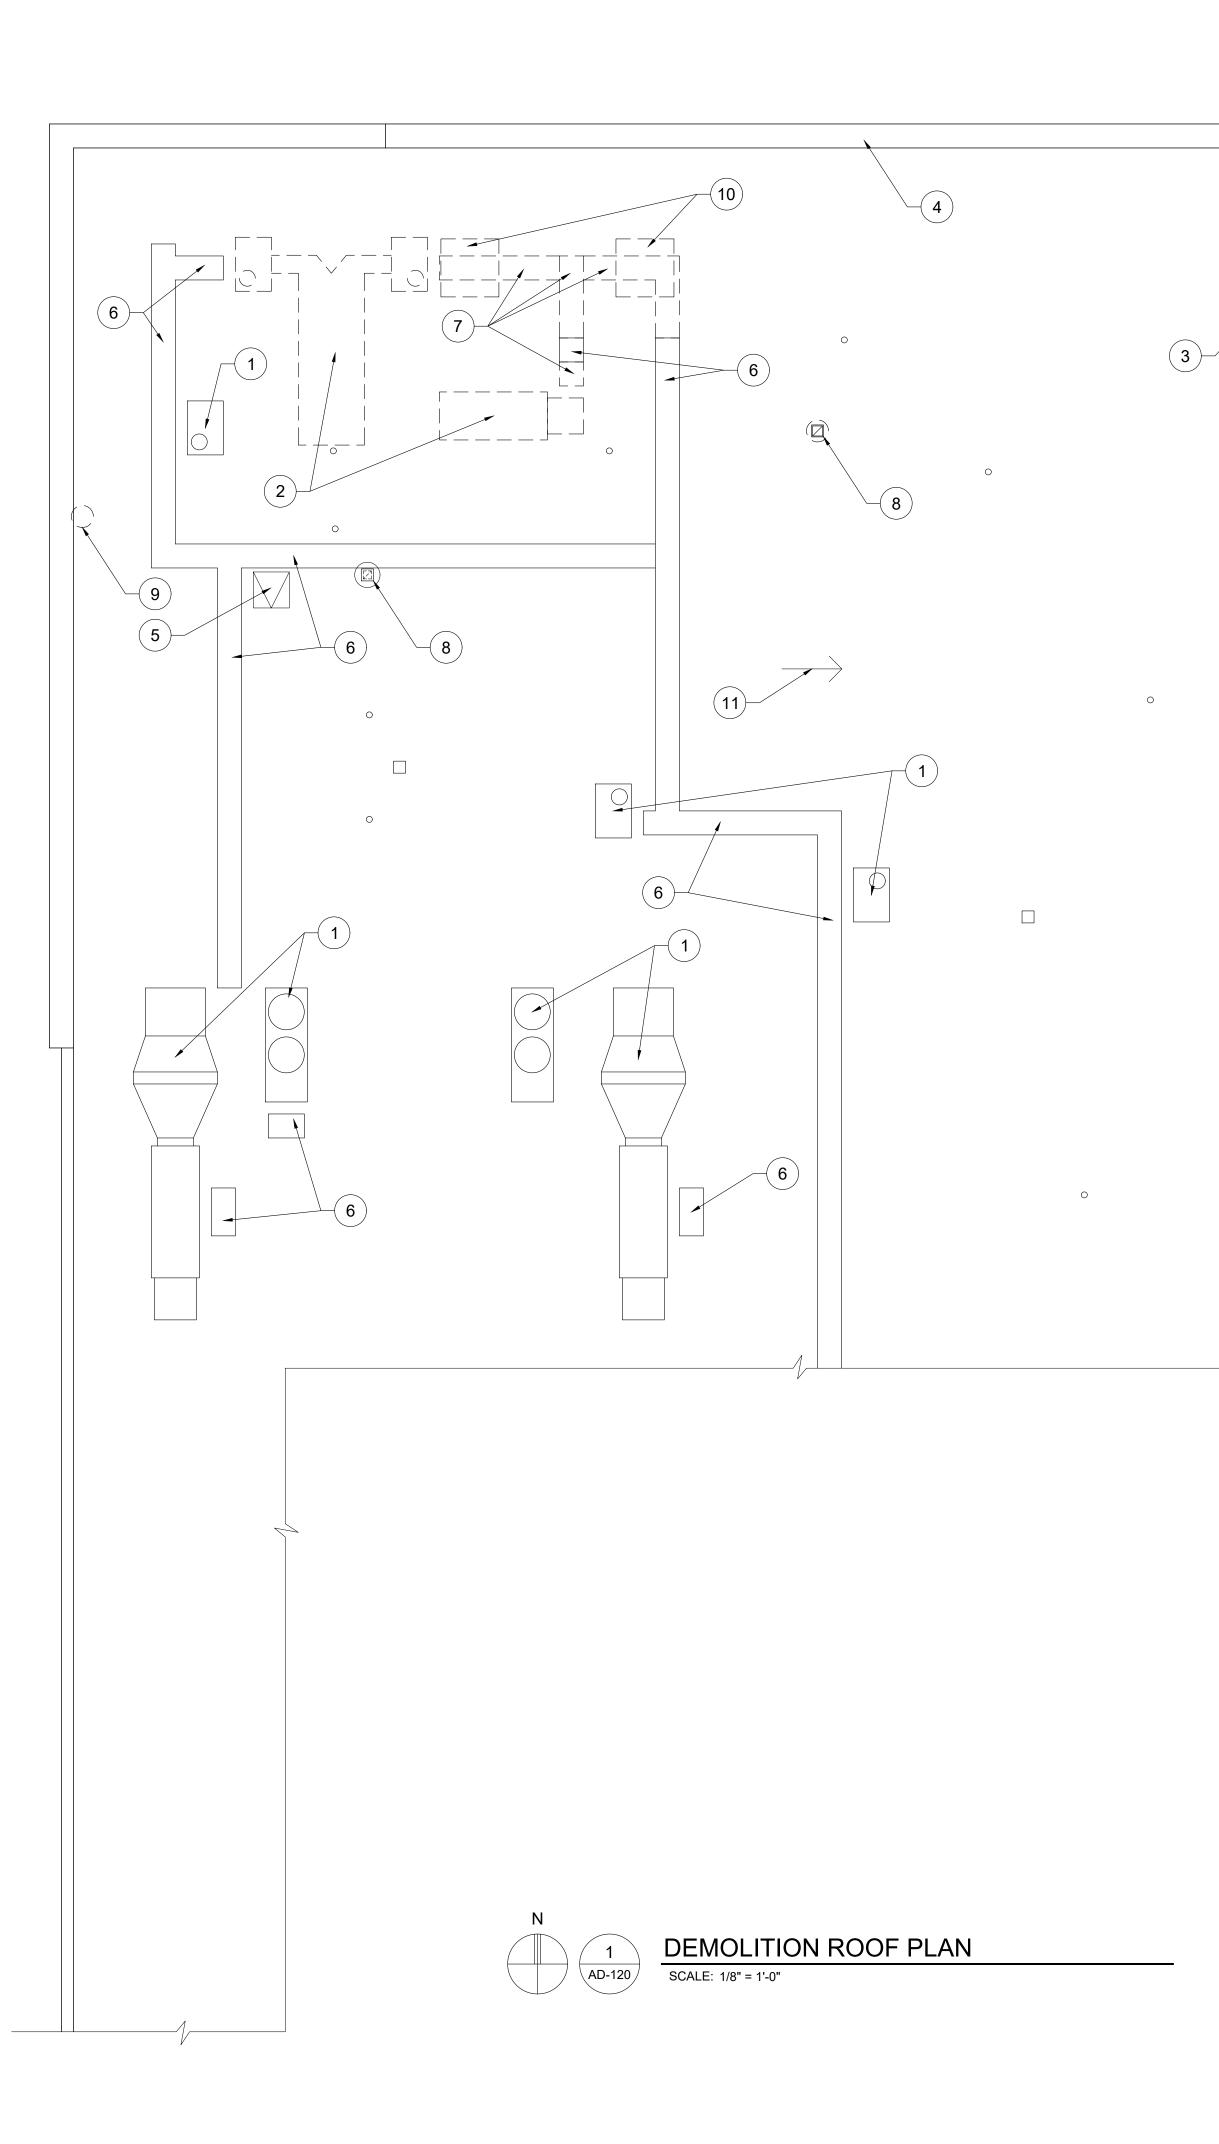
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Approved:	MR

Sheet Title: DEMOLITION FLOOR PLANS



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- B. THESE DEMOLITION NOTES AND PLANS DO NOT FULLY REPRESENT ALL DEMOLITION WORK REQUIRED TO INSTALL NEW WORK IN ACCORDANCE WITH CONTRACT DOCUMENTS, BUT ARE INTENDED TO SERVE AS GENERAL DEMOLITION GUIDELINES. REFER TO ARCHITECTURAL, STRUCTURAL, MECHANICAL, AND ELECTRICAL DRAWINGS FOR LOCATIONS OF INCIDENTAL DEMOLITION WORK NOT INDICATED ON THIS PLAN.
- C. THE CONTRACTOR IS RESPONSIBLE FOR ALL ITEMS TO BE SALVAGED AND RELOCATED, INCLUDING SAFE STORAGE OF SAME. UPON DEMOLITION, THE OWNER SHALL RETAIN THOSE ITEMS DEEMED SALVAGEABLE. ITEMS NOT RETAINED SHALL BECOME THE PROPERTY OF THE CONTRACTOR WHO SHALL LEGALLY DISPOSE OF SAME.
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- I. MECHANICAL DUCT WORK TO BE REMOVED. FILL OR REPAIR EXISTING MECHANICAL WALL OPENINGS AS REQUIRED. REFER TO MECHANICAL DRAWINGS FOR PLACEMENT OF NEW OR REUSED OPENINGS.
- J. PLUMBING TO BE REMOVED TO CONCEALED AREA AND CAPPED. REFER TO ARCHITECTURAL & PLUMBING DRAWINGS FOR PLACEMENT OF NEW FIXTURES & DRAINS.
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DEMOLITION ROOF PLAN NOTES:

- 1 EXISTING RTU
- 2 EXISTING RTU TO BE REMOVED
- 3 EXISTING GUTTER
- (4) EXISTING COPING
- 5 EXISTING ROOF HATCH
- (6) EXISTING WALKWAY PADS
- (7) EXISTING WALKWAY PADS TO BE REMOVED
- (8) EXISTING EXHAUST VENT
- 9 AREA OF EXISTING ROOF TO BE REMOVED FOR INSTALLATION OF NEW EXHAUST VENT
- (10) AREA OF EXISTING ROOF TO BE DEMOLISHED FOR INSTALLATION OF NEW SKYLIGHT
- (11) EXISTING ROOF SLOPE DOWN

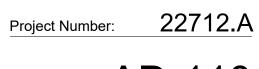

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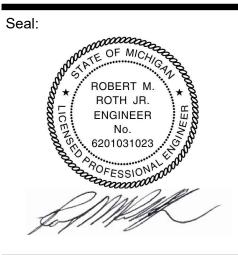


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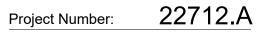
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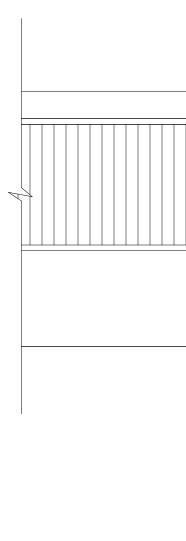
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01-17-2024	Permit Review


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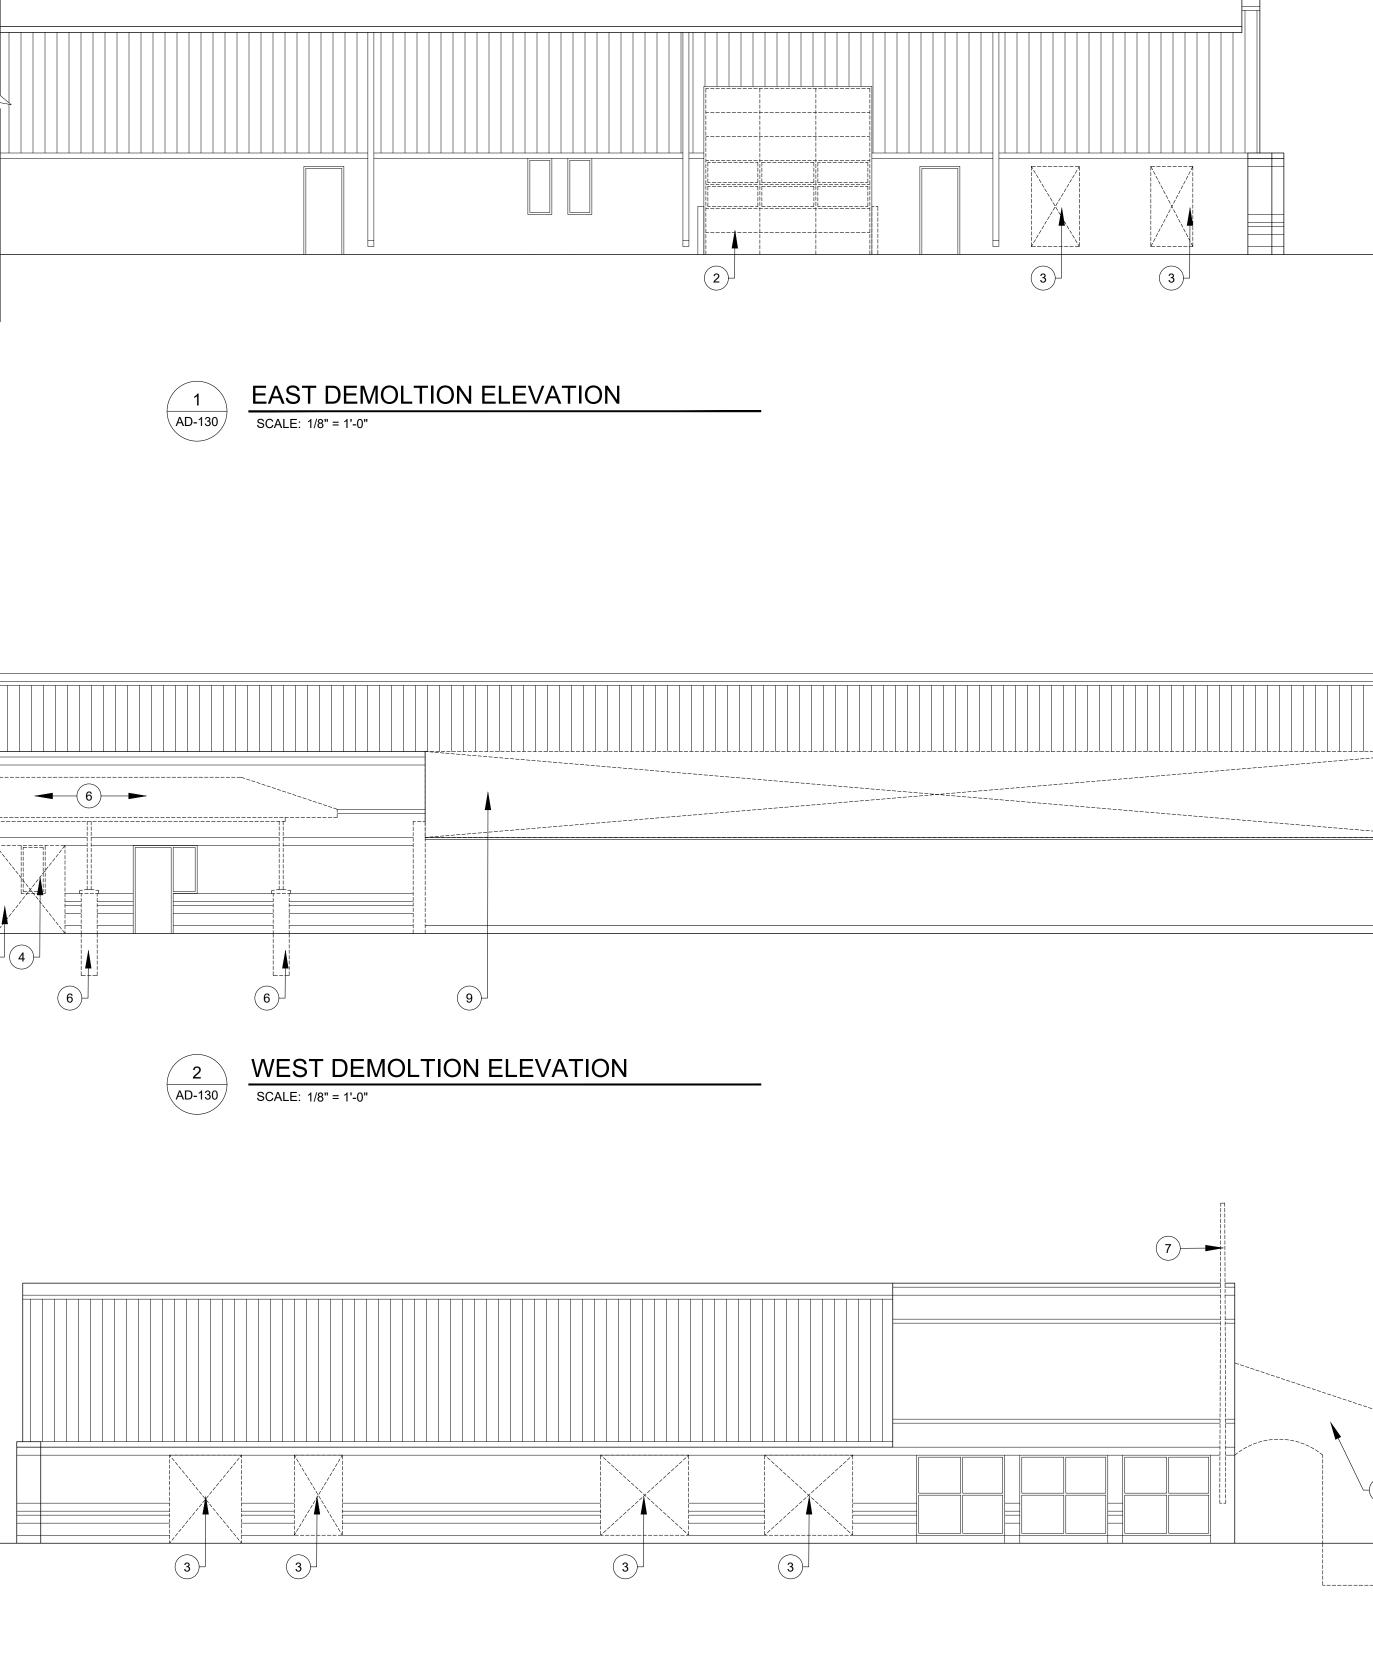
Sheet Title: DEMOLITION **ROOF PLAN**









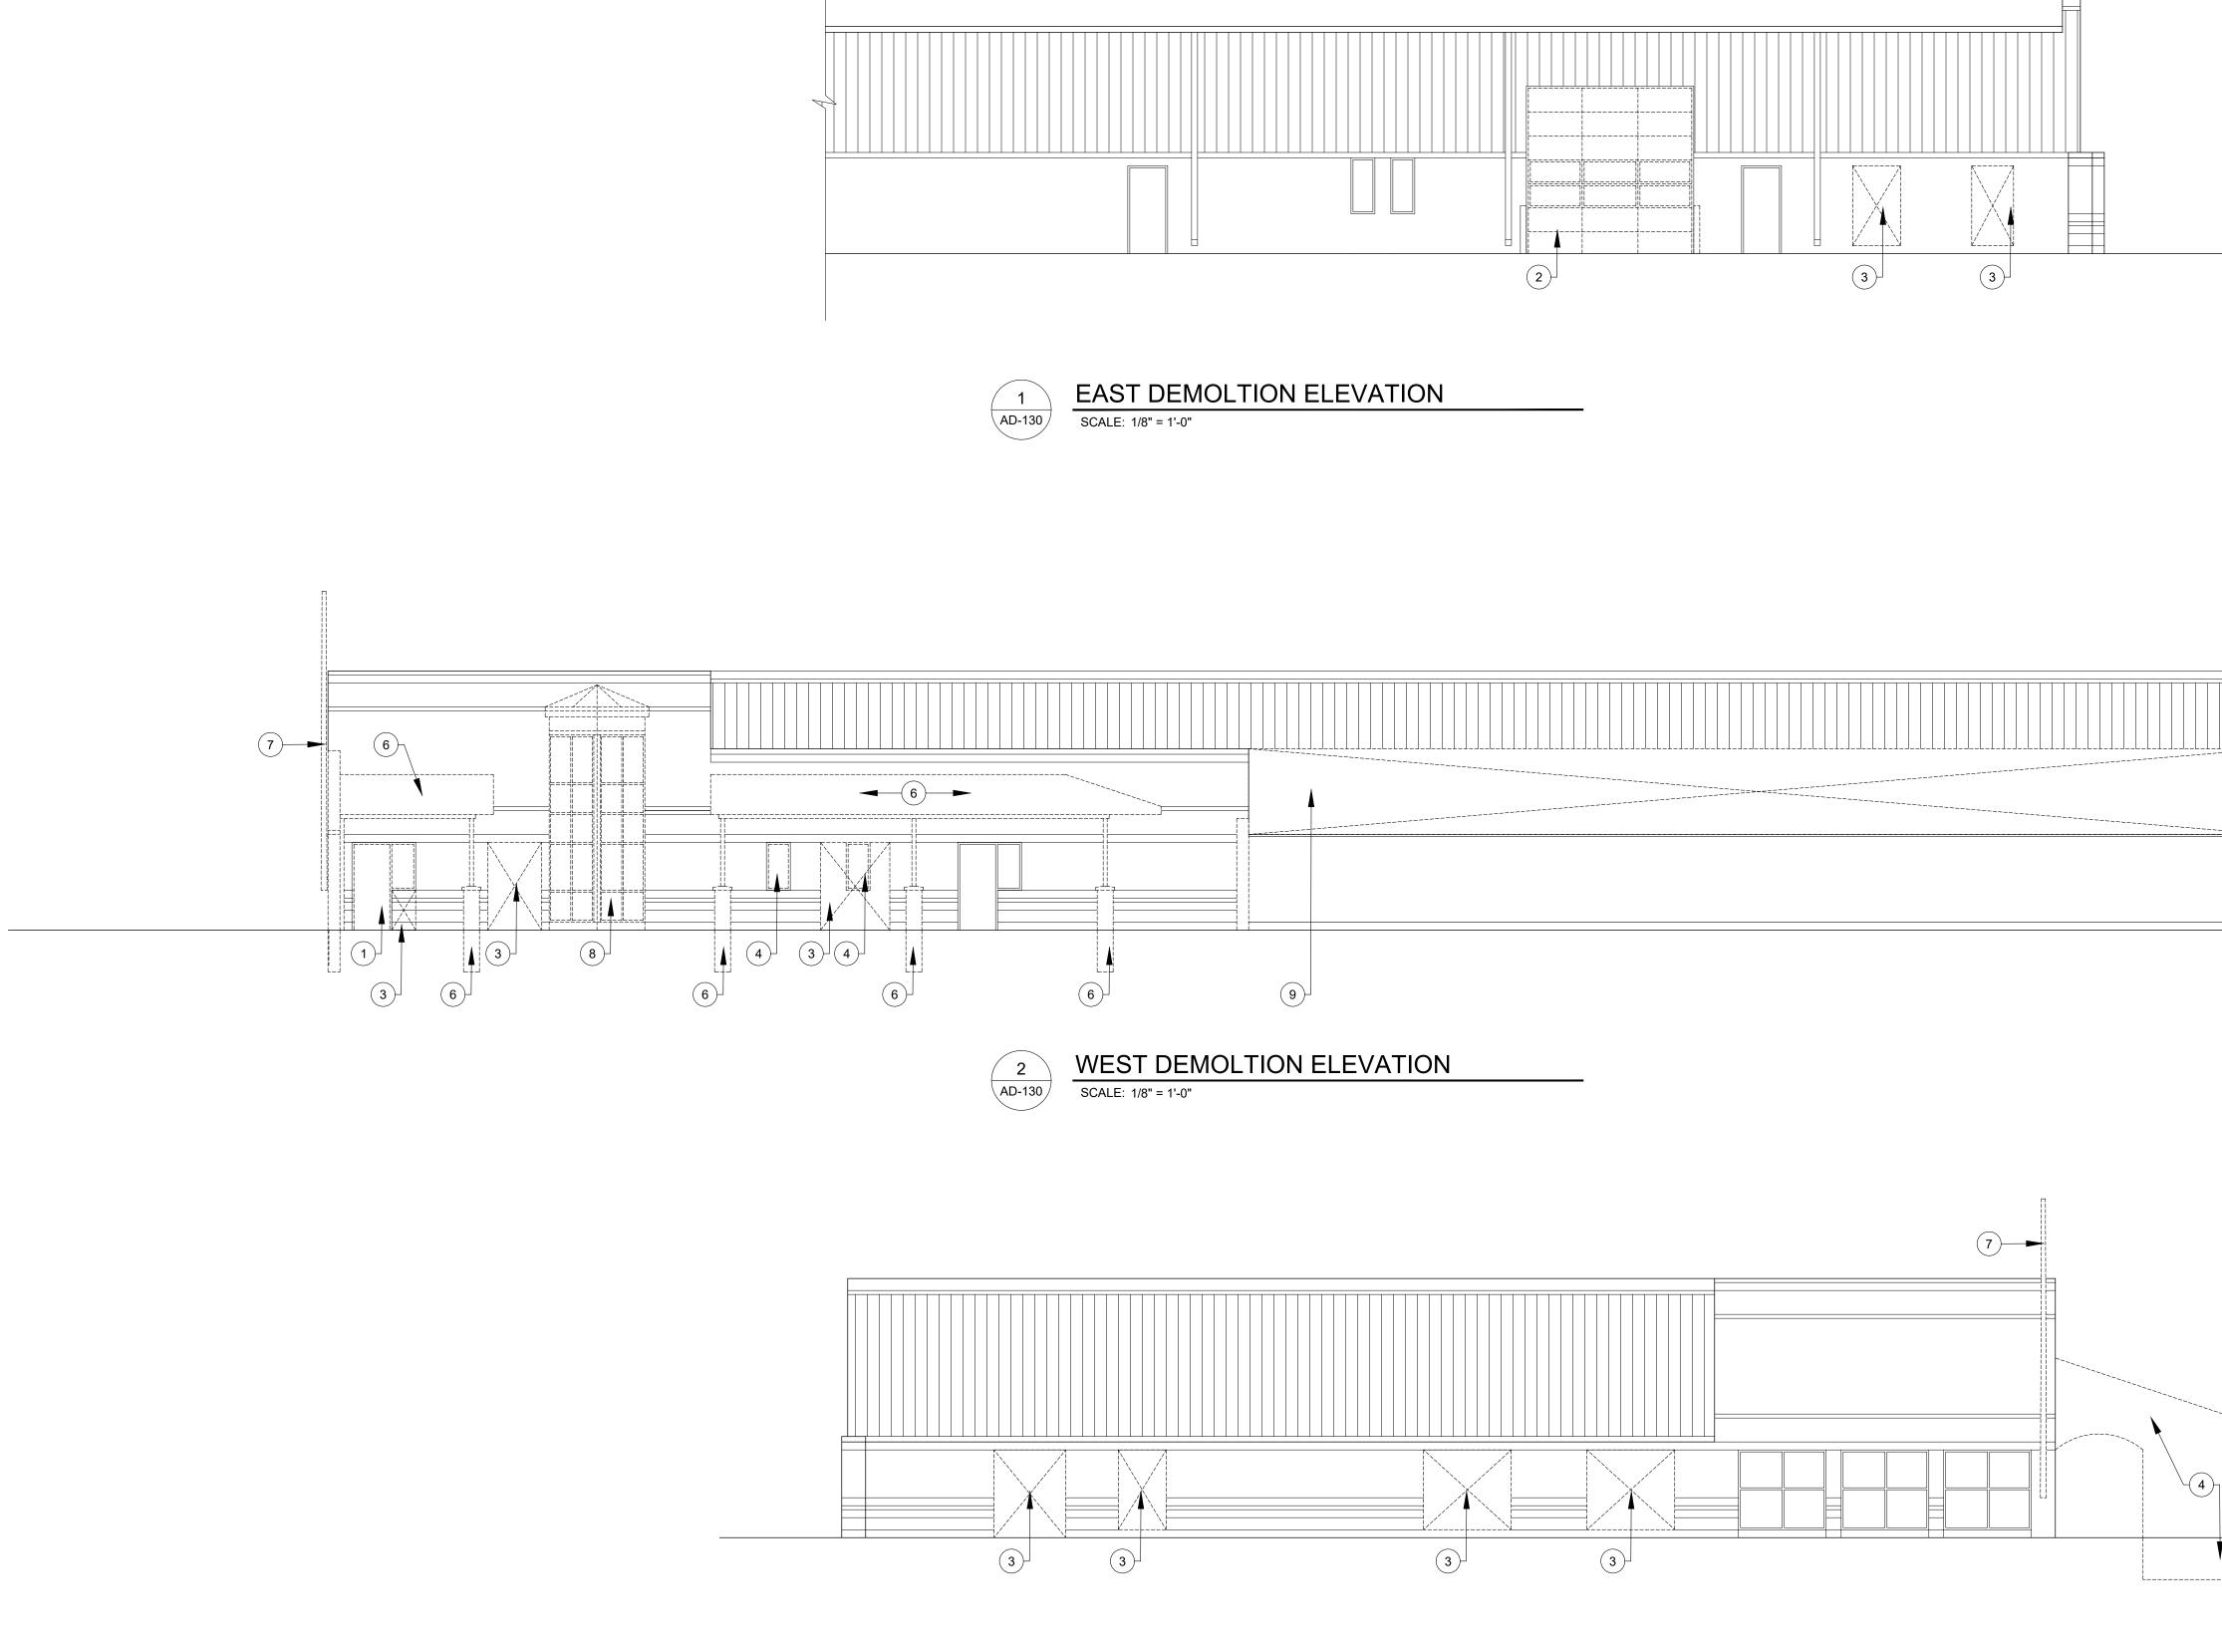

3 \ AD-130 /

NORTH DEMOLTION ELEVATION SCALE: 1/8" = 1'-0"

GENERAL DEMOLITION NOTES:

- A. COORDINATE ALL ARCHITECTURAL, STRUCTURAL, MECHANICAL, AND ELECTRICAL DEMOLITION DRAWINGS ACCORDINGLY.
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DEMOLITION ELEVATION NOTES:

- (1) REMOVE DOOR AND FRAME.
- (2) REMOVE OVERHEAD DOOR AND ASSOCIATED TRACKS/EQUIPMENT.
- (3) REMOVE PORTION OF WALL TO CREATE NEW OPENING.
- (4) REMOVE WINDOW.
- (5) REMOVE EXTERIOR MASONRY WALL AND ASSOCIATED FOOTING.
- (6) REMOVE COLUMNS AND AWNING ABOVE.
- 7 REMOVE AND RELOCATE WALL MOUNTED FLAG POLE.
- (8) REMOVE CURTAIN WALL WINDOW SYSTEM.
- (9) REMOVE PORTION OF EXISTING METAL SIDING TO A HEIGHT OF 12" ABOVE THE NEW T.O.S. DECK ELEVATION

LEGEND:

_ _ _ _ _ _ _

ITEM TO BE REMOVED

KEY NOTE



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Project:

City of Taylor Animal Shelter Remodel & Expansion

25555 Northline Rd. Taylor, MI 48180




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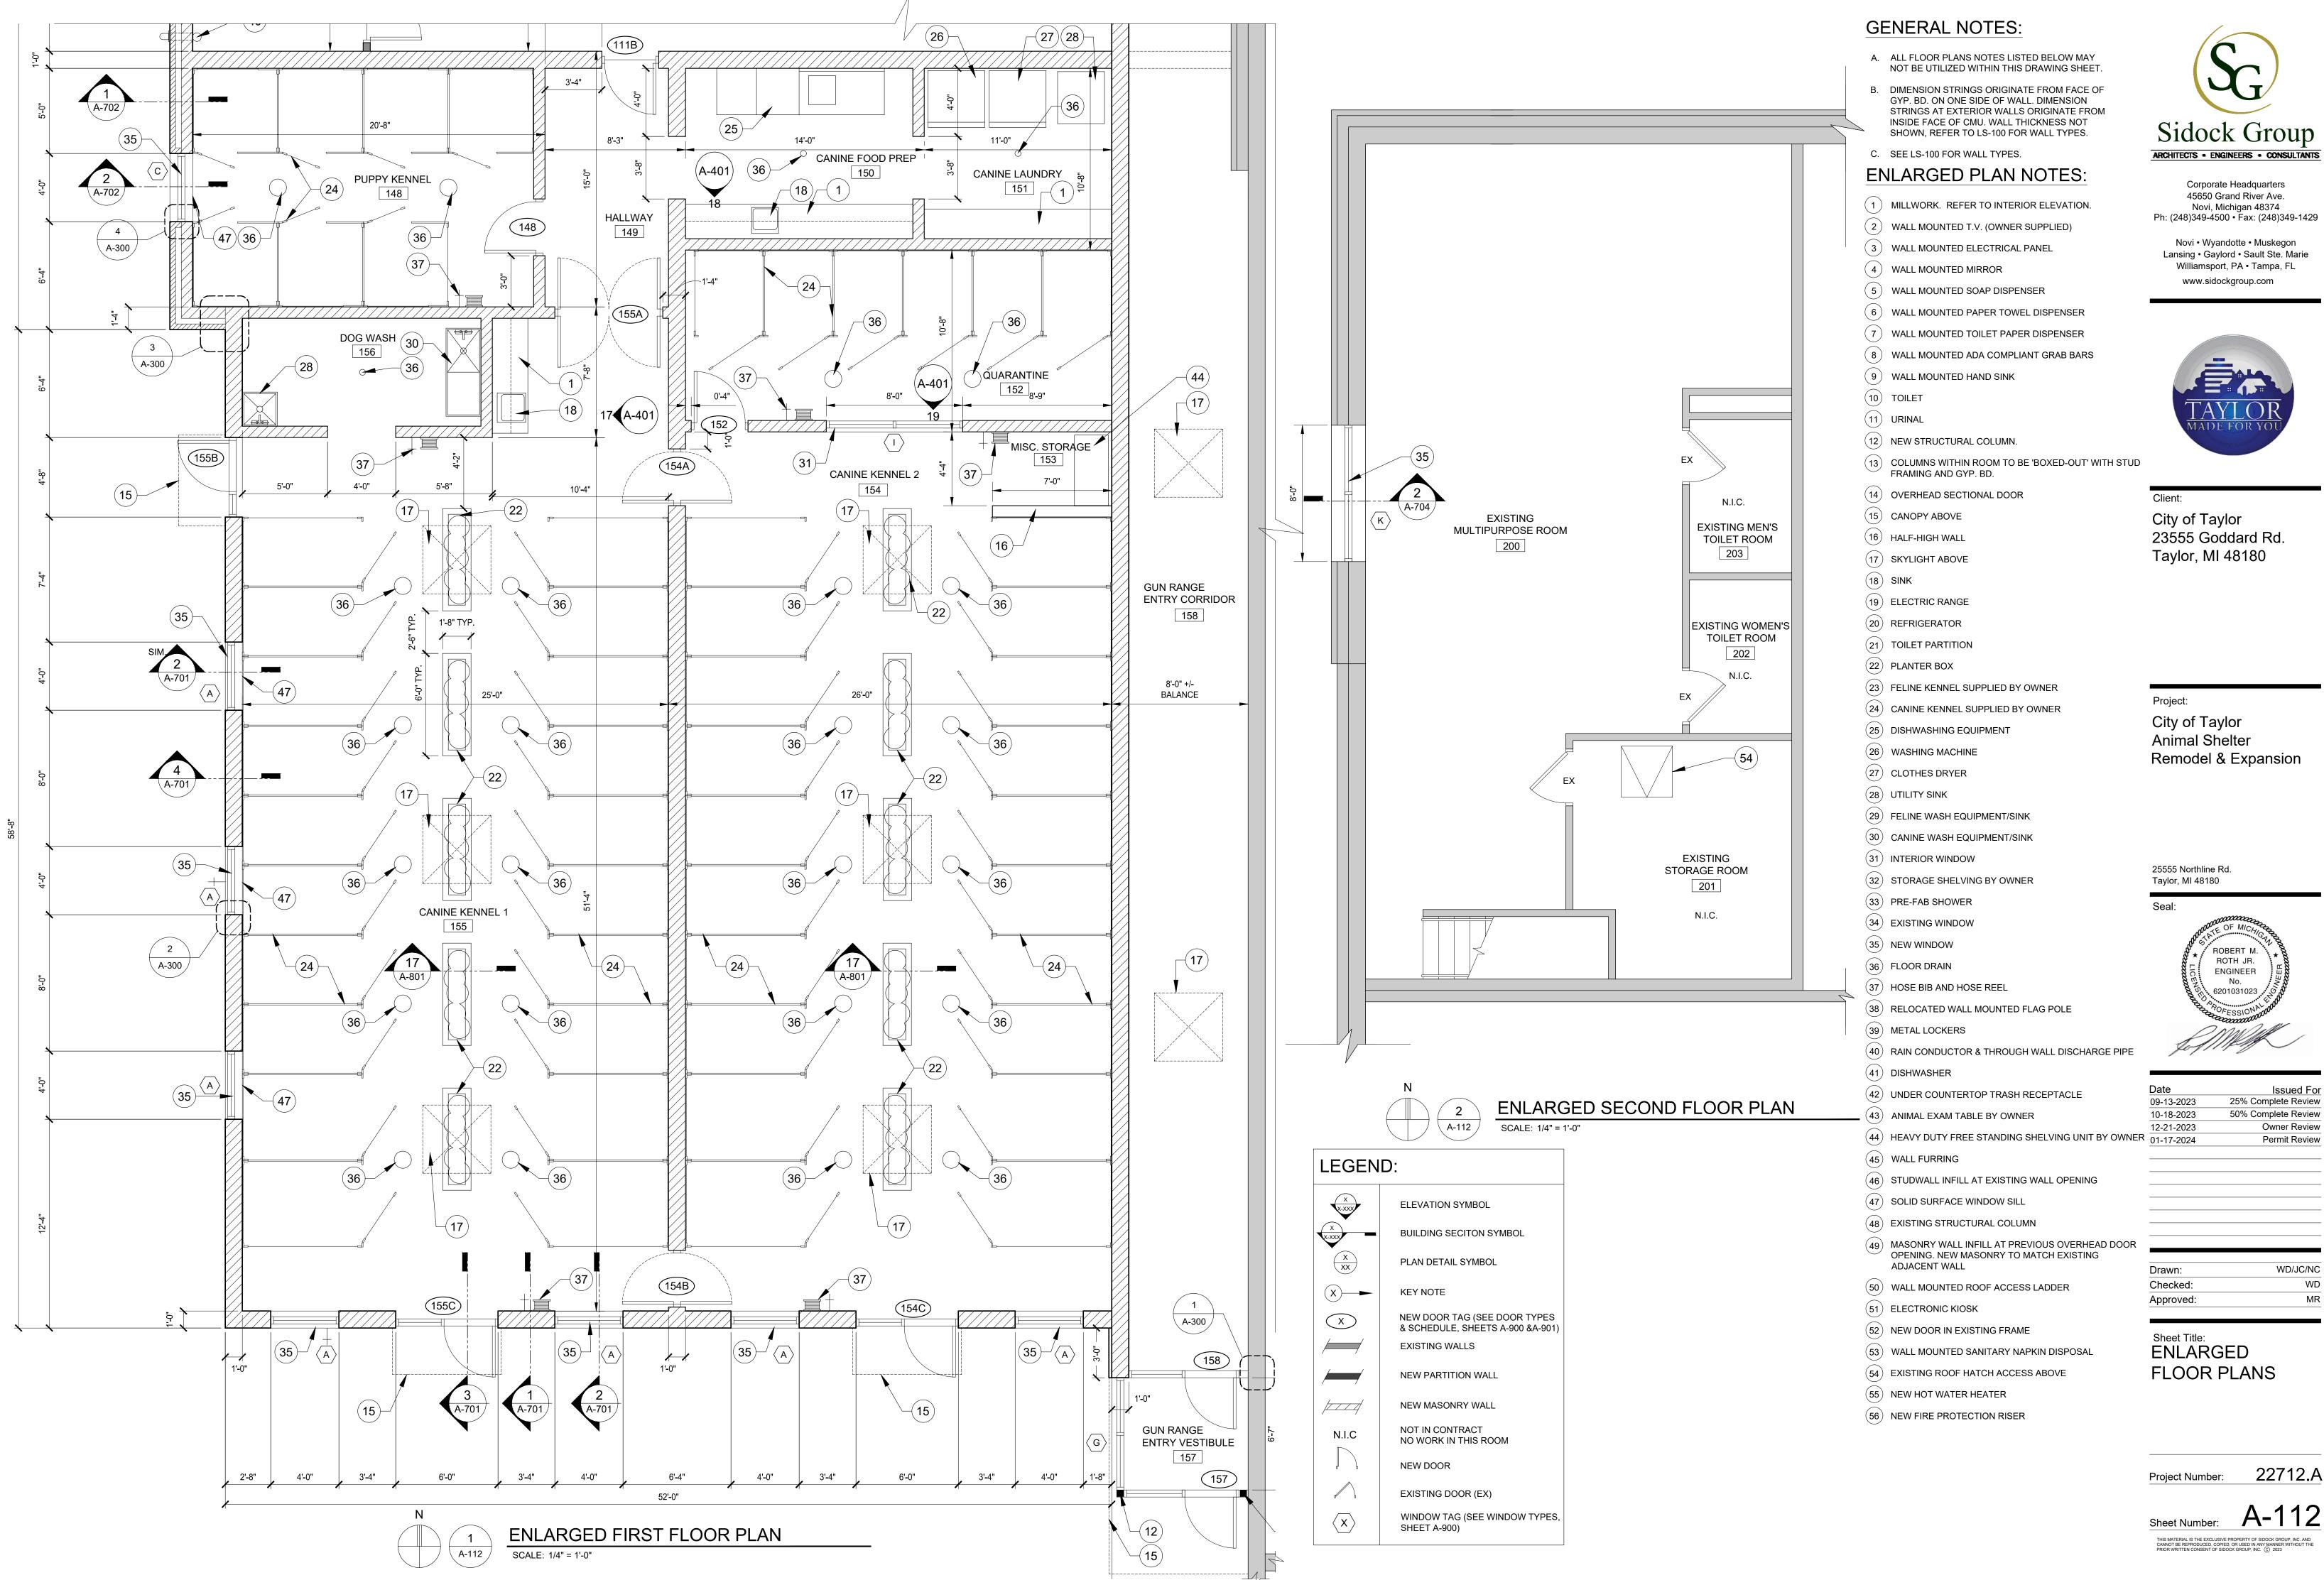
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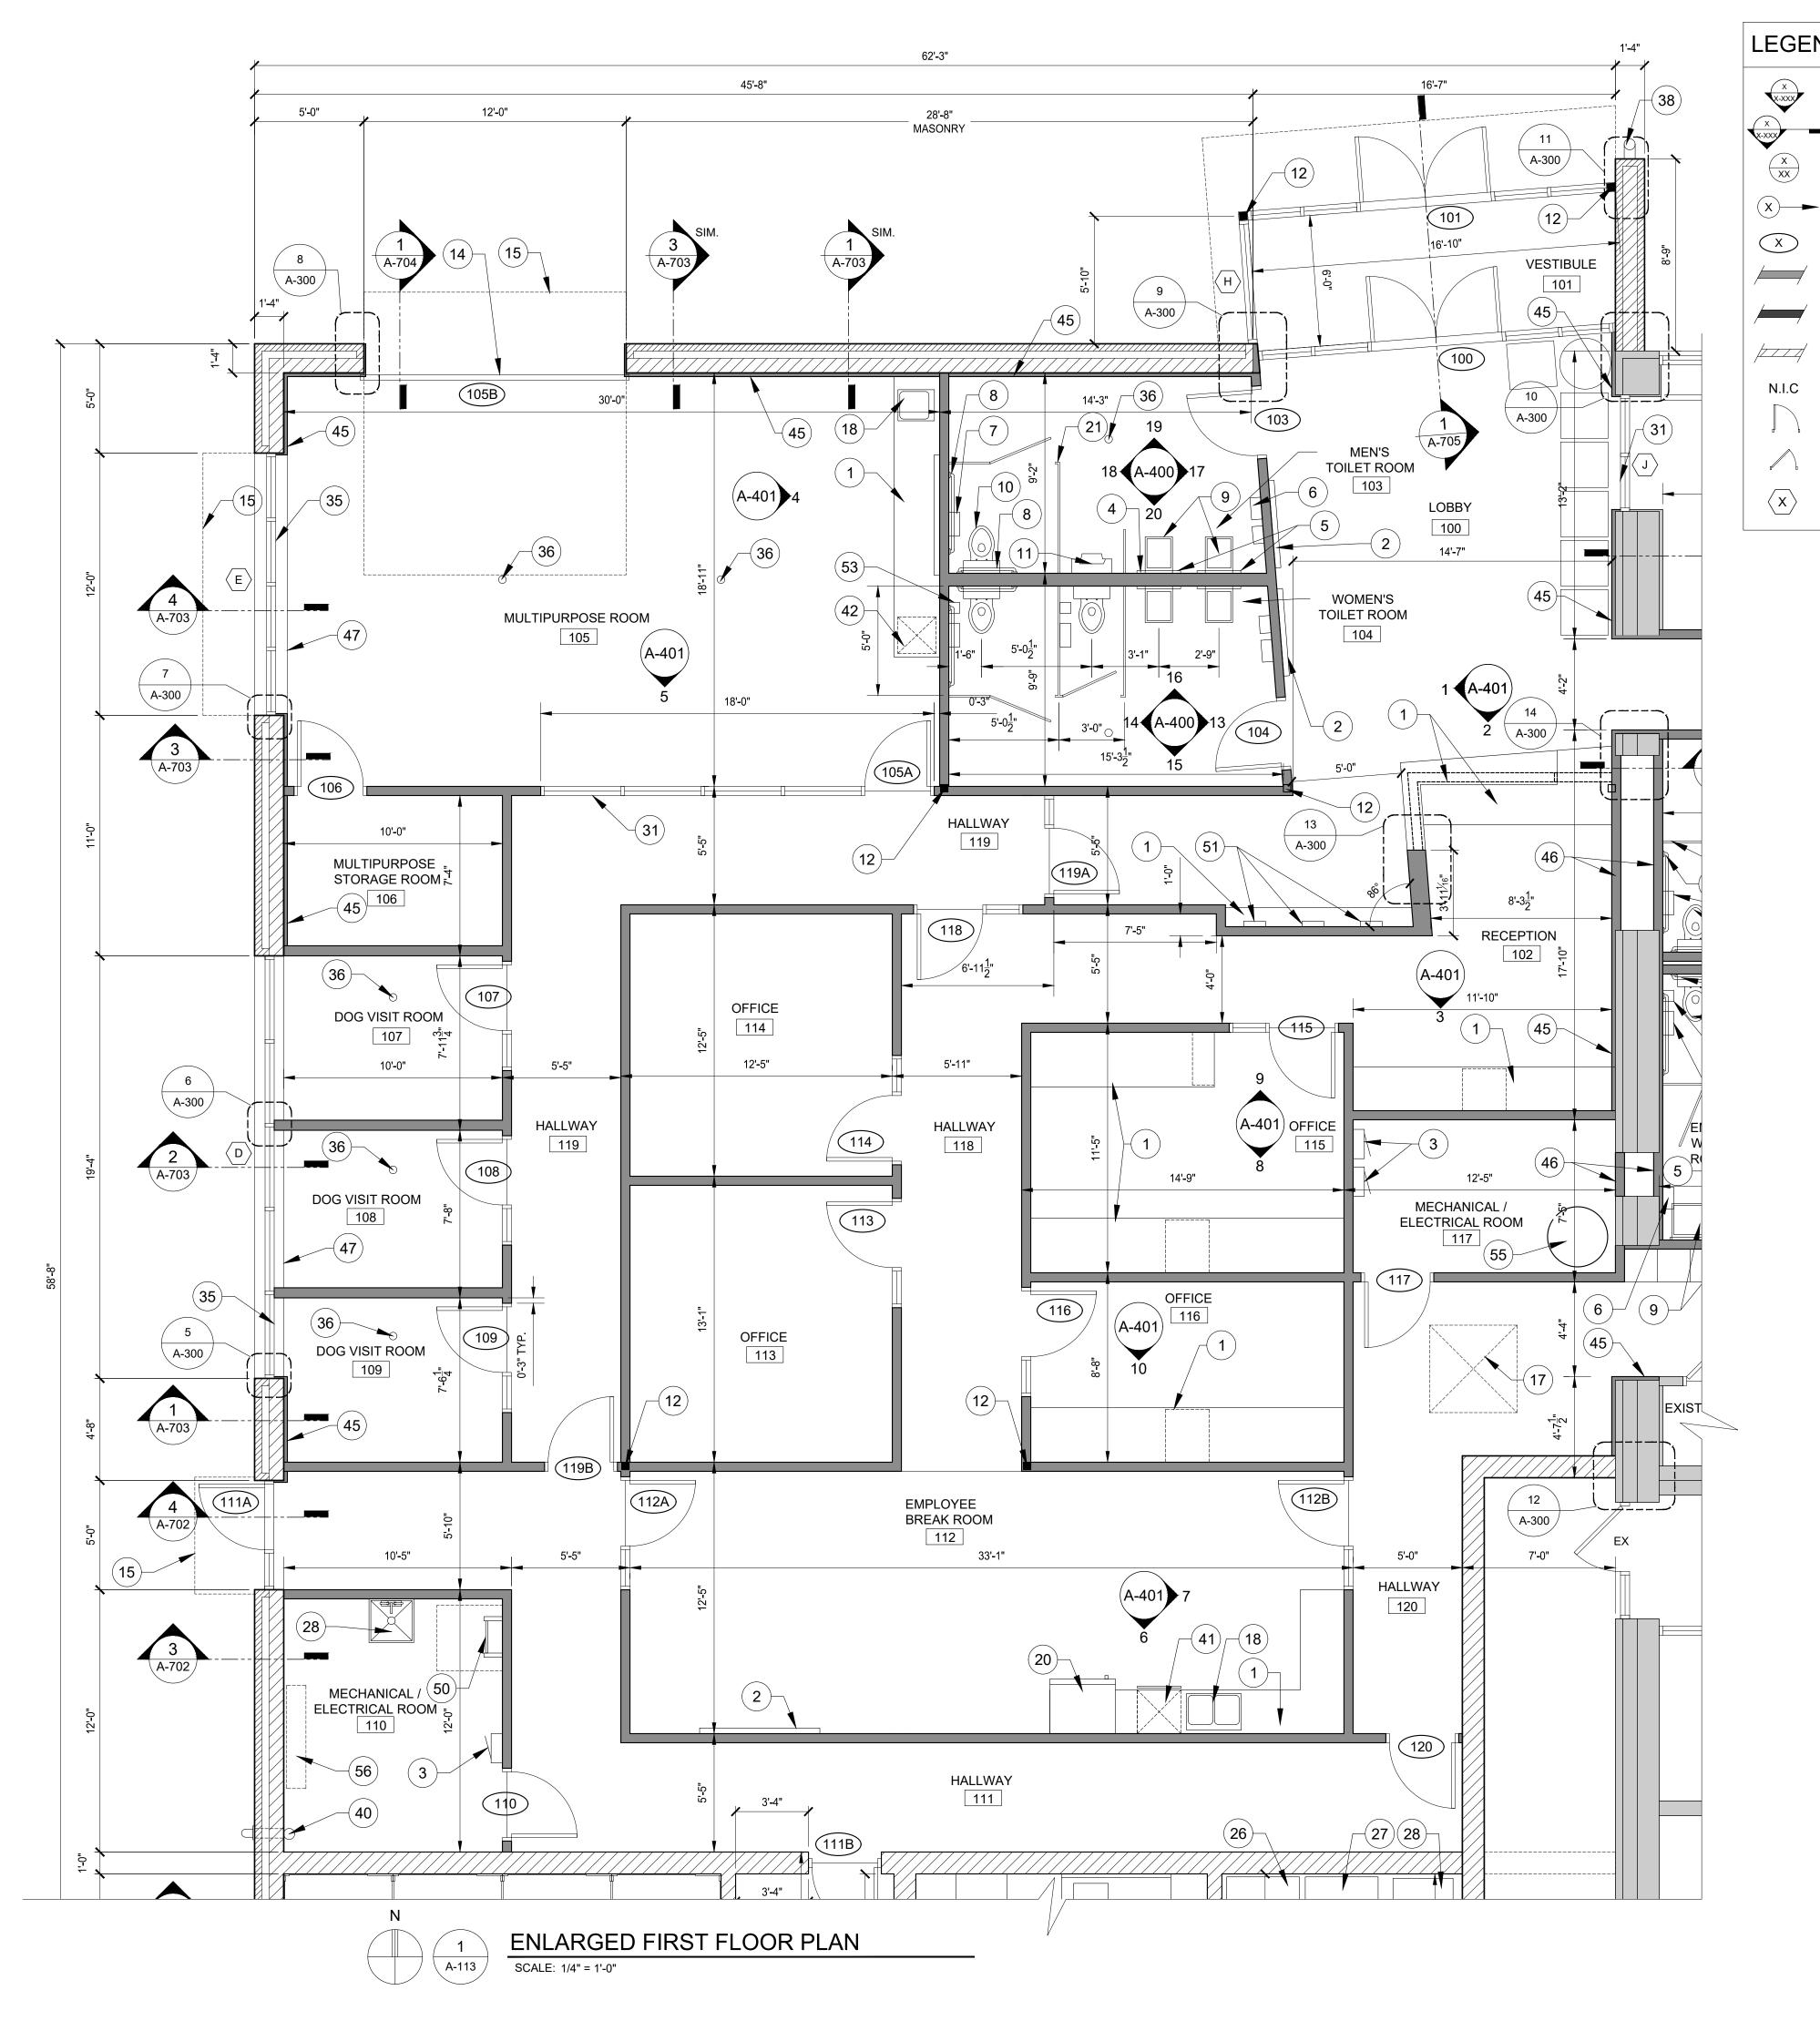




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Checked:	WD
Approved:	MR



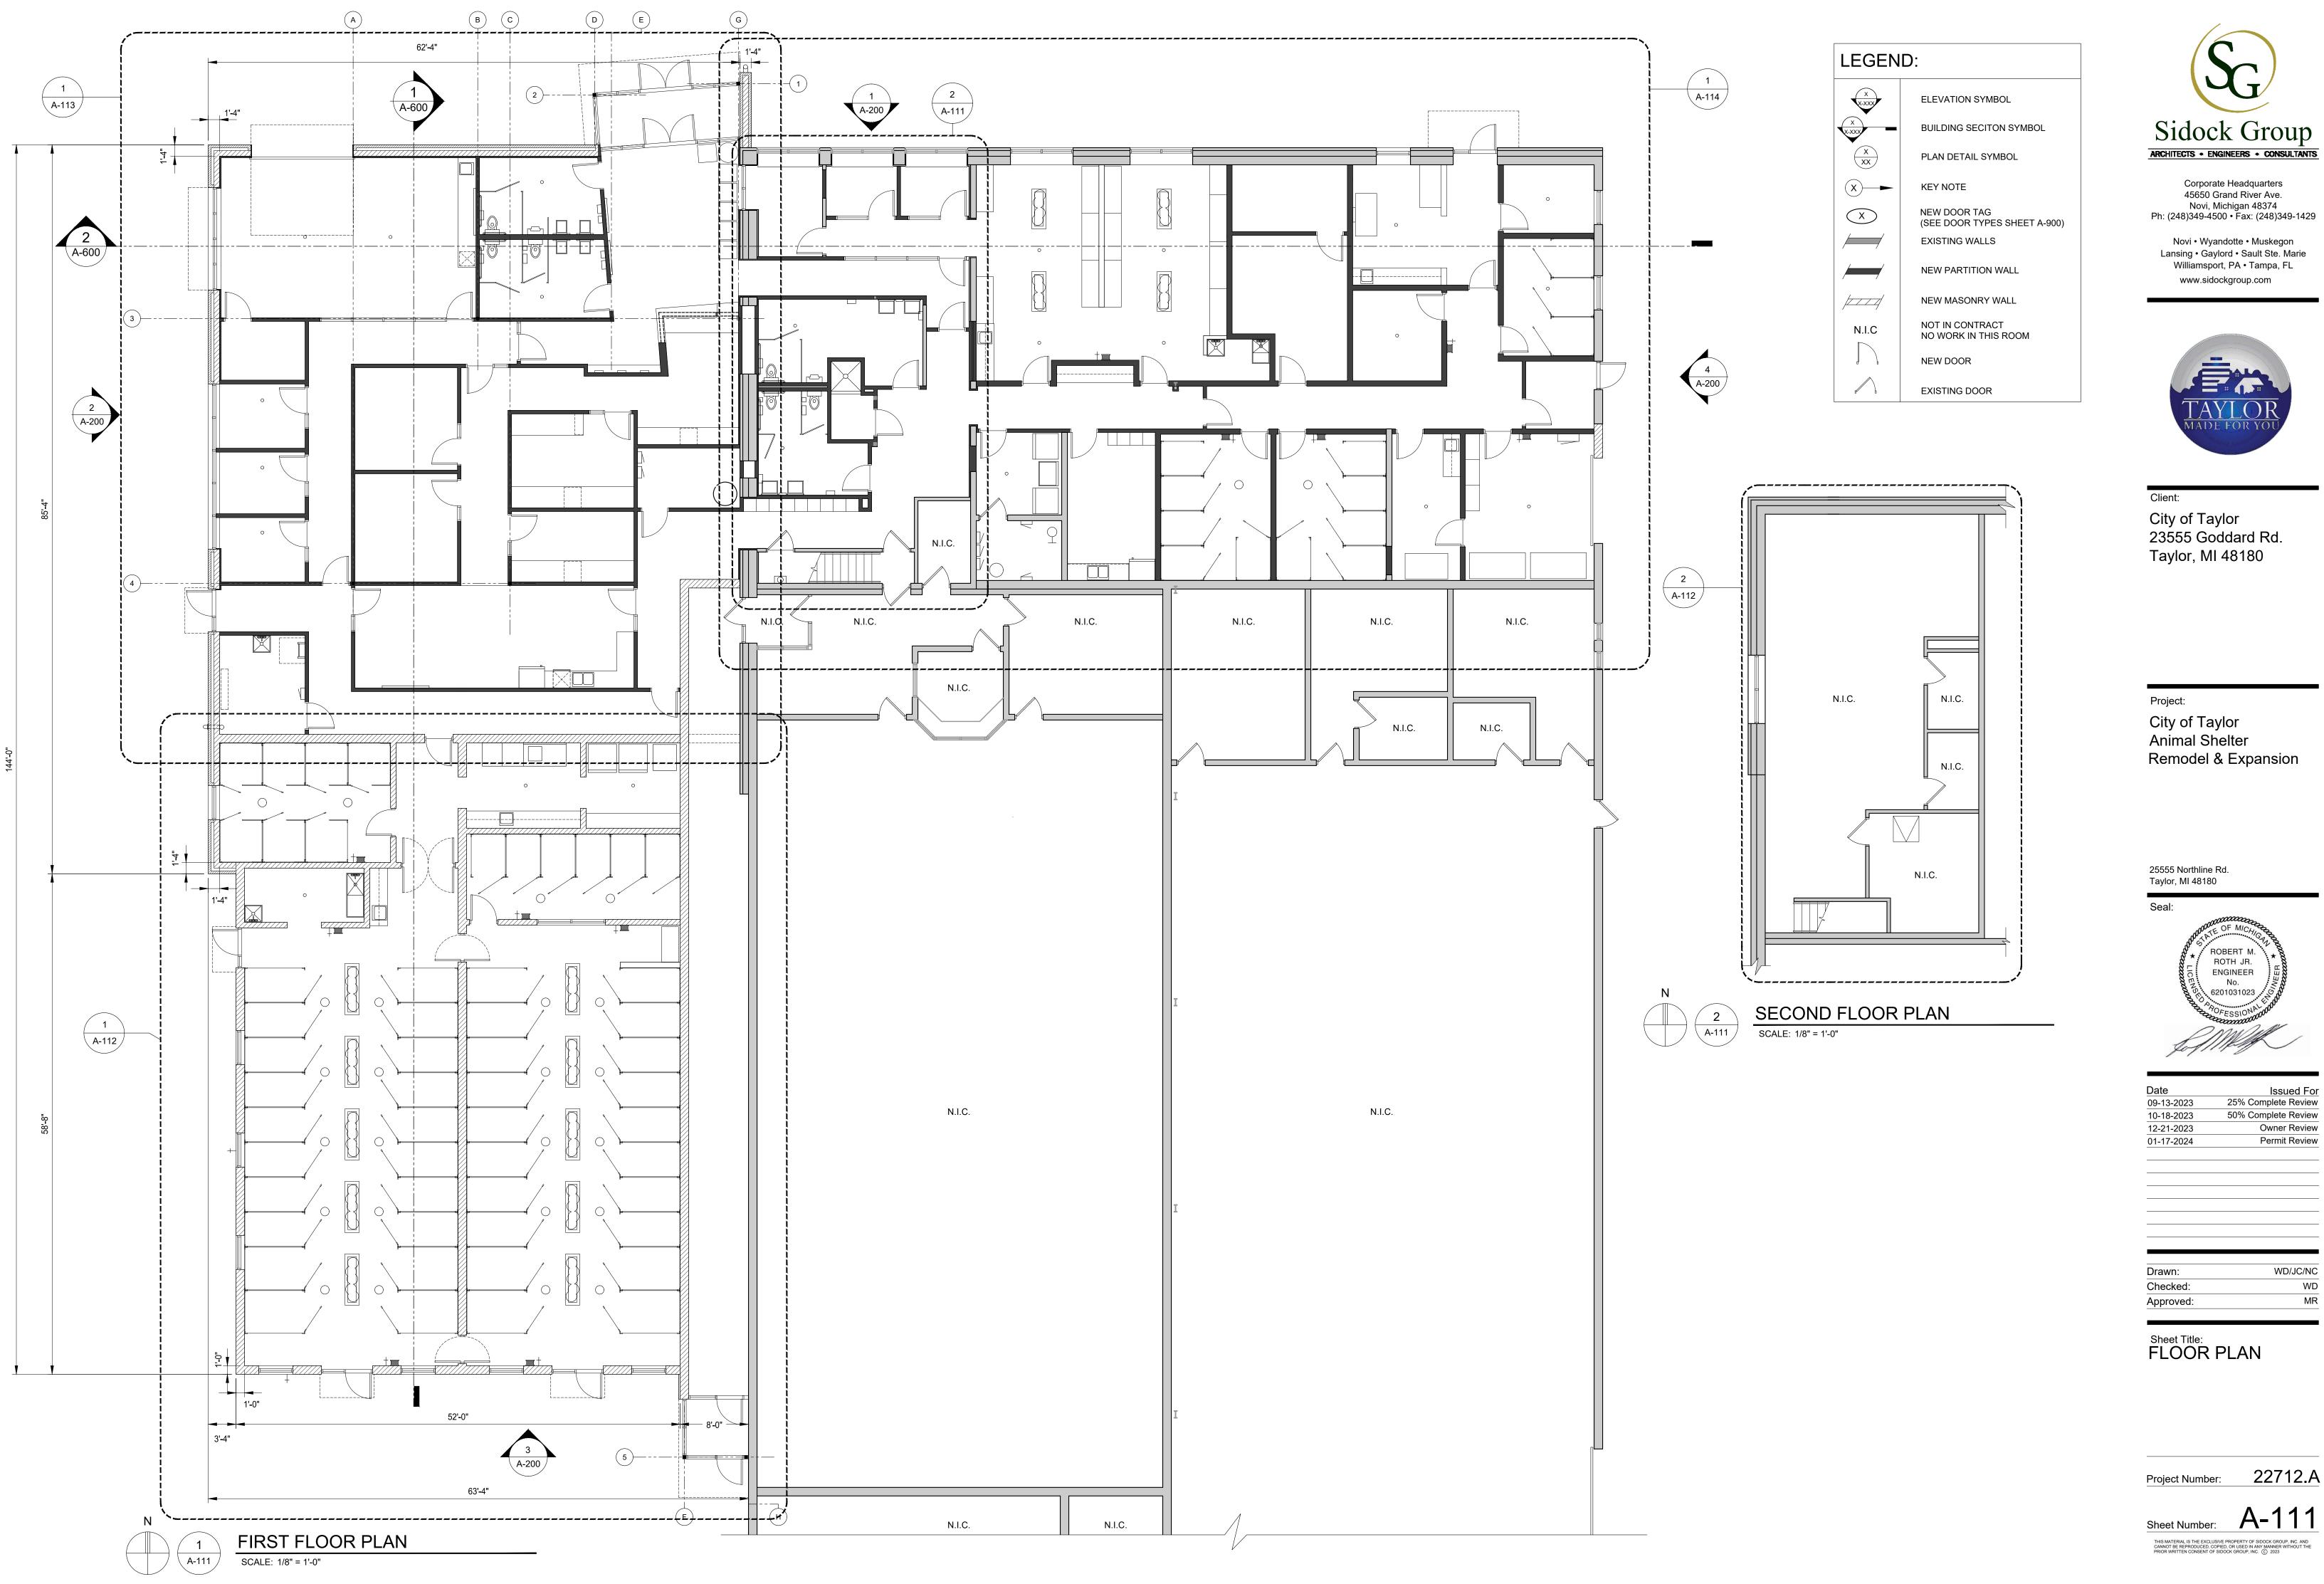

LEGEND:

ELEVATION SYMBOL

BUILDING SECITON SYMBOL

- PLAN DETAIL SYMBOL
- KEY NOTE

NEW DOOR TAG (SEE DOOR TYPES & SCHEDULE, SHEETS A-900 & A-901) EXISTING WALLS

- NEW PARTITION WALL
- NEW MASONRY WALL
- NOT IN CONTRACT NO WORK IN THIS ROOM
- NEW DOOR
- EXISTING DOOR (EX)

WINDOW TAG (SEE WINDOW TYPES, SHEET A-900)

- A. ALL FLOOR PLANS NOTES LISTED BELOW MAY NOT BE UTILIZED WITHIN THIS DRAWING SHEET.
- B. DIMENSION STRINGS ORIGINATE FROM FACE OF GYP. BD. ON ONE SIDE OF WALL. DIMENSION STRINGS AT EXTERIOR WALLS ORIGINATE FROM INSIDE FACE OF CMU. WALL THICKNESS NOT SHOWN, REFER TO LS-100 FOR WALL TYPES.

C. SEE LS-100 FOR WALL TYPES.

ENLARGED PLAN NOTES:

- (1) MILLWORK. REFER TO INTERIOR ELEVATION.
- (2) WALL MOUNTED T.V. (OWNER SUPPLIED)
- (3) WALL MOUNTED ELECTRICAL PANEL
- (4) WALL MOUNTED MIRROR
- (5) WALL MOUNTED SOAP DISPENSER
- (6) WALL MOUNTED PAPER TOWEL DISPENSER
- (7) WALL MOUNTED TOILET PAPER DISPENSER
- (8) WALL MOUNTED ADA COMPLIANT GRAB BARS
- (9) WALL MOUNTED HAND SINK
- (10) TOILET
- (11) URINAL
- (12) NEW STRUCTURAL COLUMN.
- (13) COLUMNS WITHIN ROOM TO BE 'BOXED-OUT' WITH STUD FRAMING AND GYP. BD.
- (14) OVERHEAD SECTIONAL DOOR
- (15) CANOPY ABOVE
- (16) HALF-HIGH WALL
- (17) SKYLIGHT ABOVE
- (18) SINK
- (19) ELECTRIC RANGE
- (20) REFRIGERATOR
- (21) TOILET PARTITION
- (22) PLANTER BOX
- (23) FELINE KENNEL SUPPLIED BY OWNER
- (24) CANINE KENNEL SUPPLIED BY OWNER
- (25) DISHWASHING EQUIPMENT
- (26) WASHING MACHINE
- (27) CLOTHES DRYER
- (28) UTILITY SINK
- (29) FELINE WASH EQUIPMENT/SINK
- (30) CANINE WASH EQUIPMENT/SINK
- (31) INTERIOR WINDOW
- (32) STORAGE SHELVING BY OWNER
- (33) PRE-FAB SHOWER
- (34) EXISTING WINDOW
- (35) NEW WINDOW
- (36) FLOOR DRAIN
- (37) HOSE BIB AND HOSE REEL
- (38) RELOCATED WALL MOUNTED FLAG POLE
- (39) METAL LOCKERS
- (40) RAIN CONDUCTOR & THROUGH WALL DISCHARGE PIPE
- (41) DISHWASHER
- (42) UNDER COUNTERTOP TRASH RECEPTACLE
- (43) ANIMAL EXAM TABLE BY OWNER
- (44) HEAVY DUTY FREE STANDING SHELVING UNIT BY OWNER
- (45) WALL FURRING
- (46) STUDWALL INFILL AT EXISTING WALL OPENING
- (47) SOLID SURFACE WINDOW SILL
- (48) EXISTING STRUCTURAL COLUMN
- (49) MASONRY WALL INFILL AT PREVIOUS OVERHEAD DOOR OPENING. NEW MASONRY TO MATCH EXISTING ADJACENT WALL
- (50) WALL MOUNTED ROOF ACCESS LADDER
- (51) ELECTRONIC KIOSK
- (52) NEW DOOR IN EXISTING FRAME
- (53) WALL MOUNTED SANITARY NAPKIN DISPOSAL
- (54) EXISTING ROOF HATCH ACCESS ABOVE
- (55) NEW HOT WATER HEATER
- (56) NEW FIRE PROTECTION RISER



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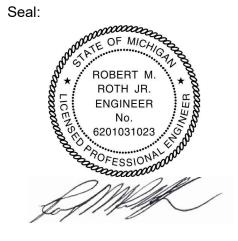
Client: City of Taylor 23555 Goddard Rd. Taylor, MI 48180

Project:

City of Taylor Animal Shelter Remodel & Expansion

Taylor, MI 48180

25555 Northline Rd.




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Checked:	WD
Approved:	MR

Sheet Title: ENLARGED FLOOR PLANS



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GENERAL NOTES:

- A. ALL FLOOR PLANS NOTES LISTED BELOW MAY NOT BE UTILIZED WITHIN THIS DRAWING SHEET.
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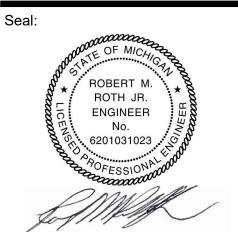

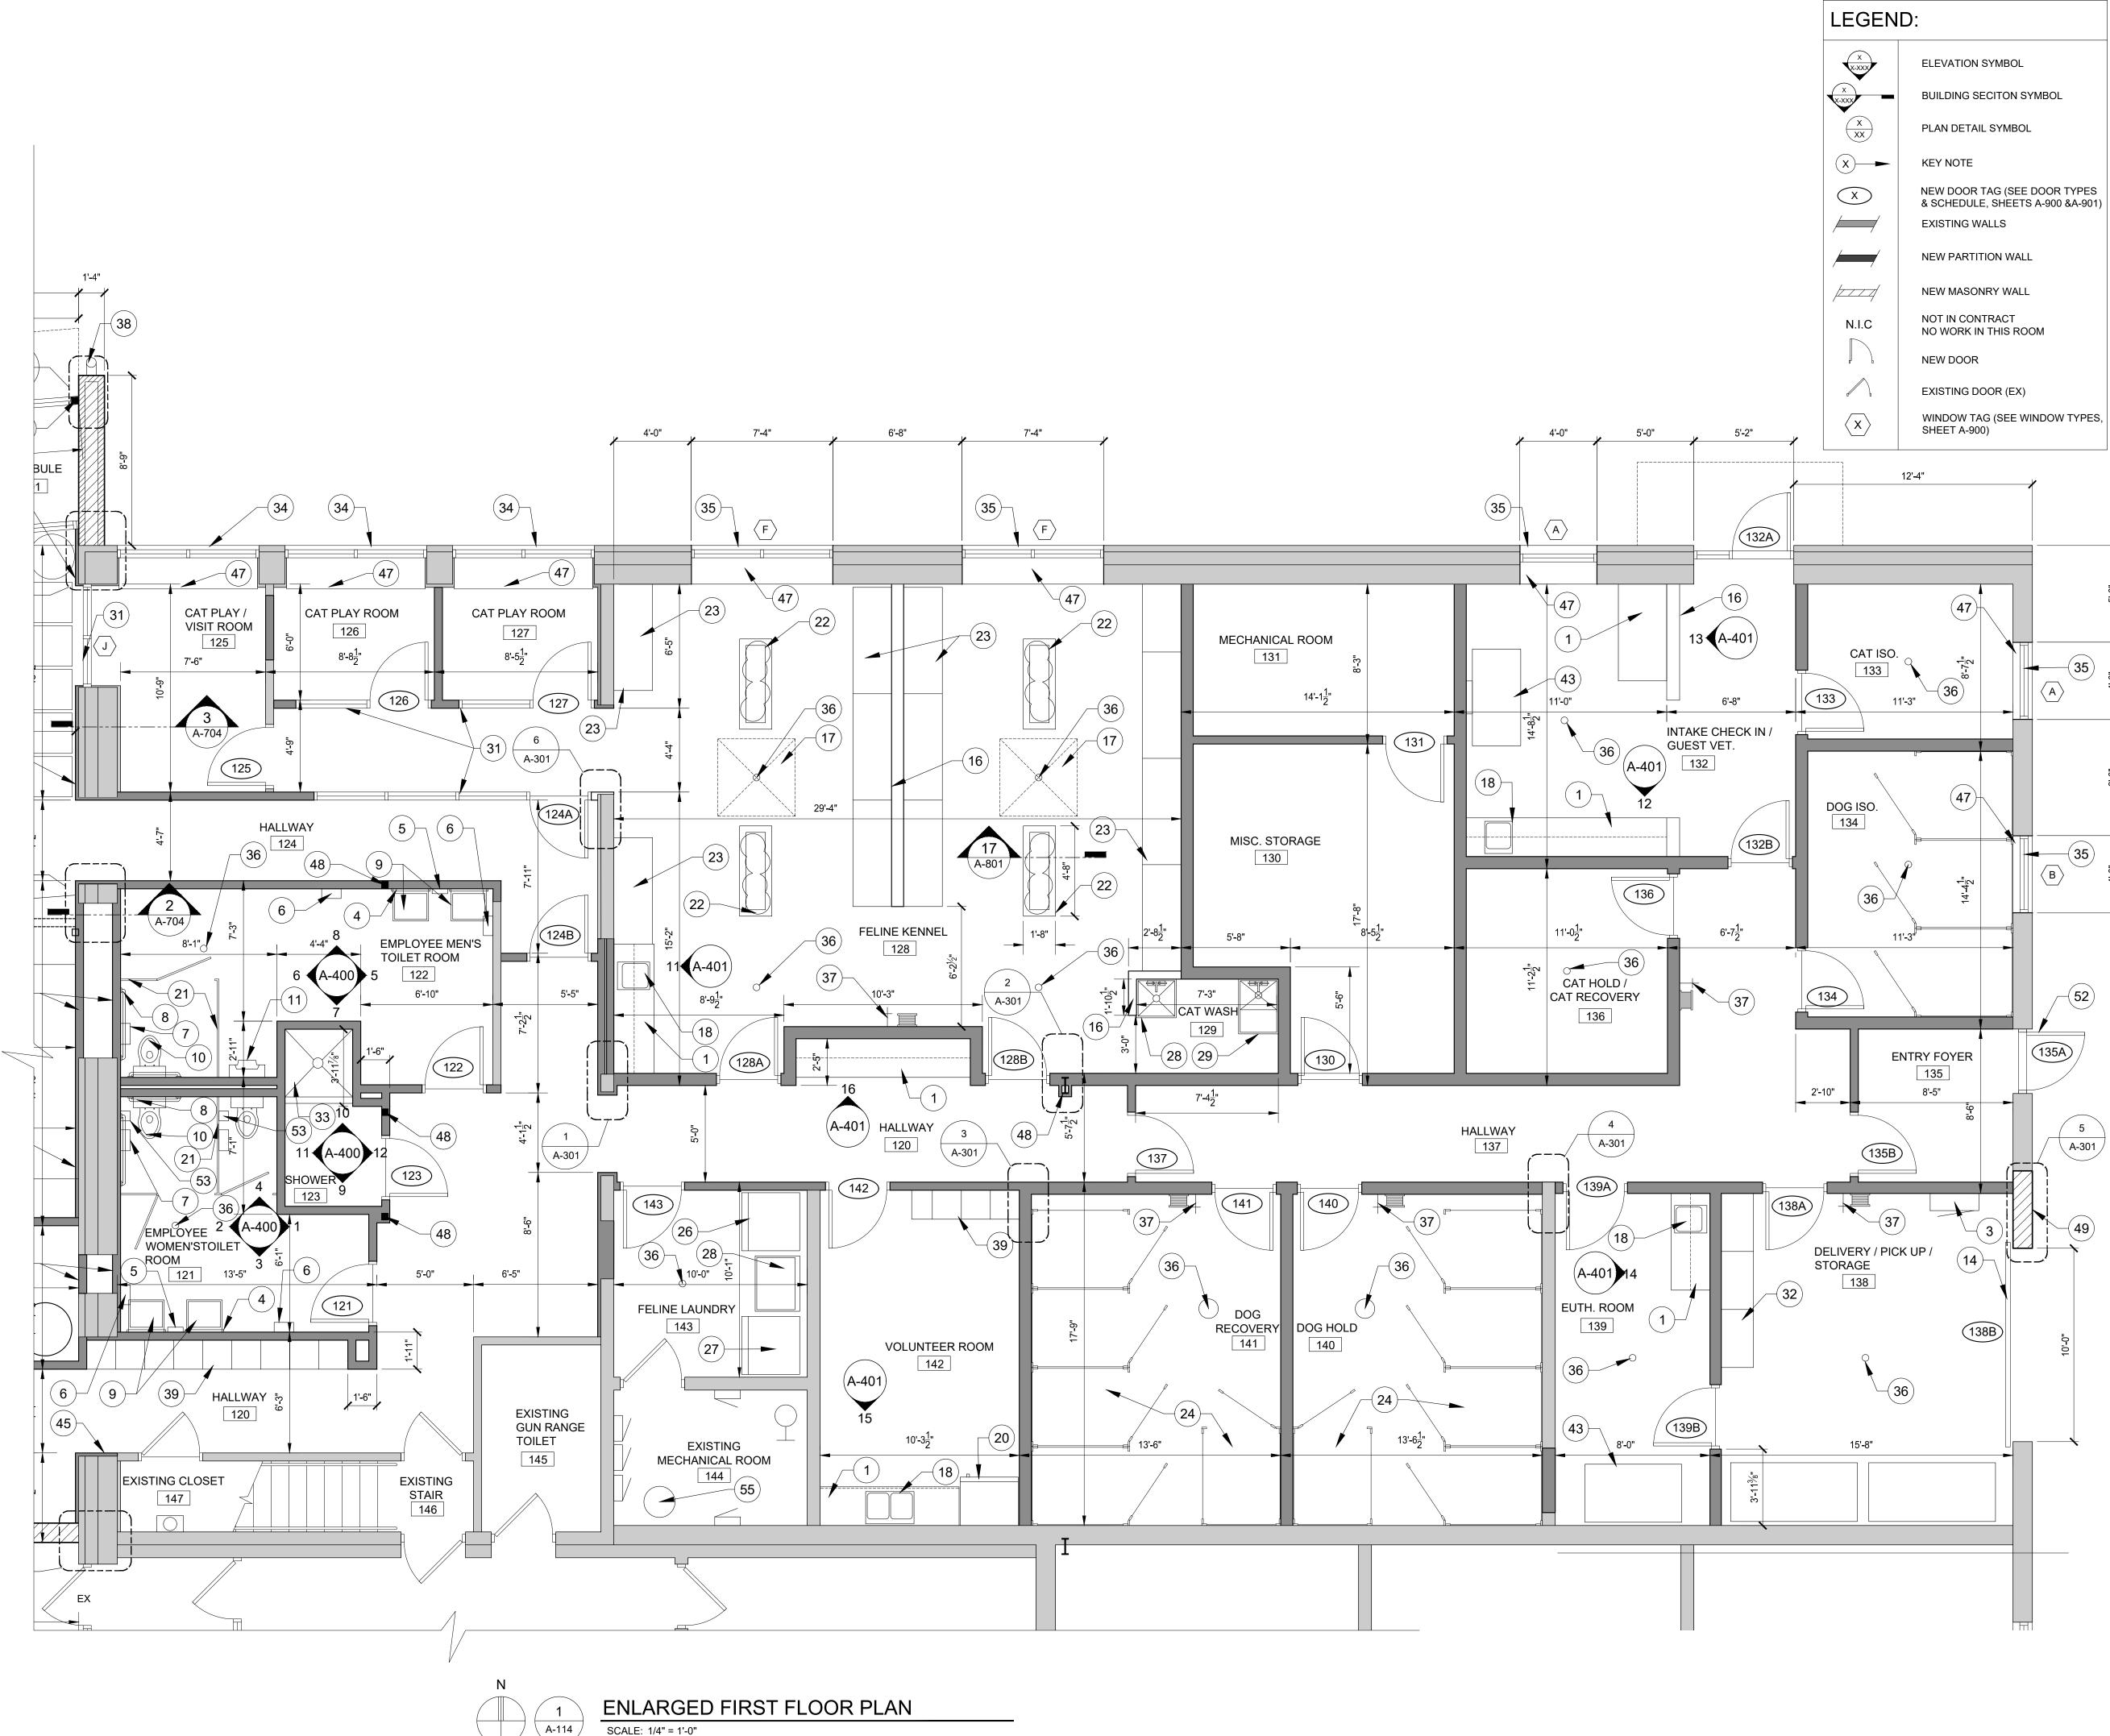
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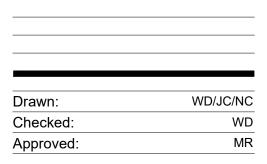
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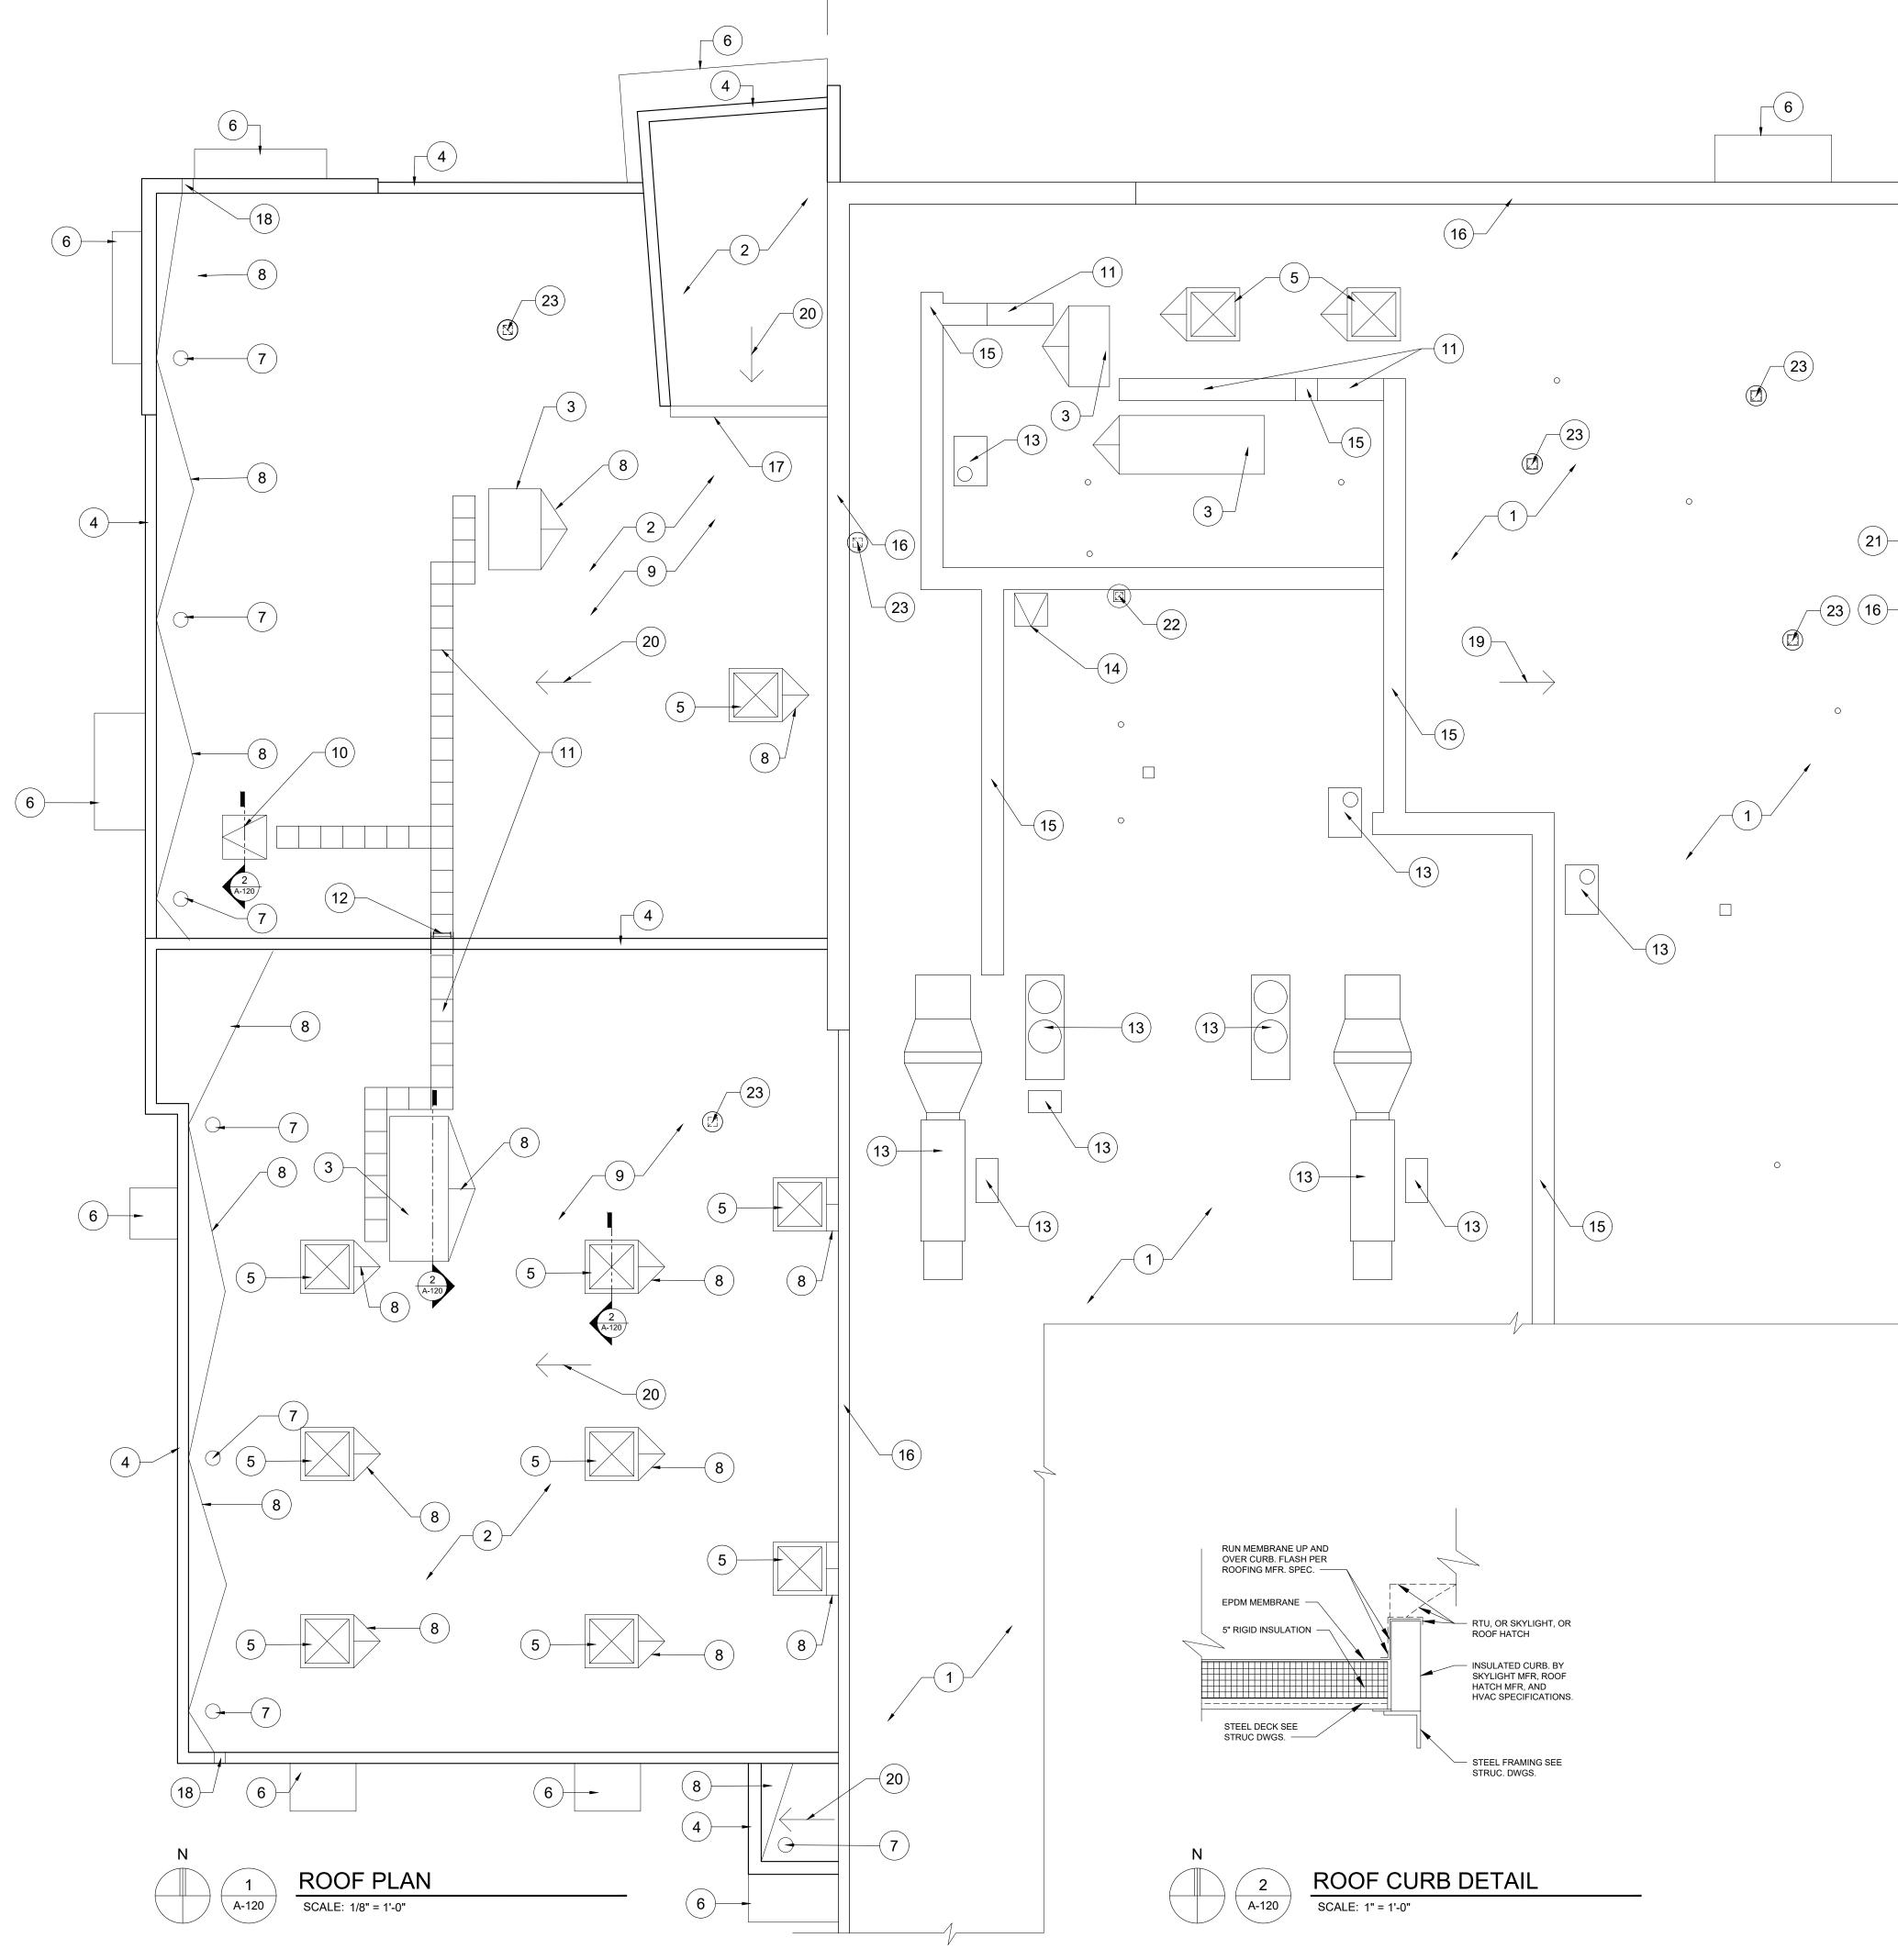
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GENERAL NOTES:

- A. NEW ROOFING SYSTEM CONSISTS OF EPDM MEMBRANE ON 5" RIGID INSULATION ON SLOPED STRUCTURAL DECK. ROOF SADDLES TO BE COMPRISED OF TAPERED INSULATION.
- B. NEW ROOFING SYSTEM IS TO BE INSTALLED PER THE MFR. SPECIFICATIONS AS REQUIRED TO MEET PRODUCT WARRANTY GUIDELINES. THIS WOULD INCLUDE THE FOLLOWING DETAILS: LAPS, SEAMS, PIPE PENETRATIONS, ROOF CURB TERMINATIONS, PARAPET WALL TERMINATIONS, PRESSURE BARS, SADDLES, AND ALL REQUIRED FASTENERS/ADHESIVES/SEALANTS/CAULKS.
- C. ROOFING CONTRACTOR IS REQUIRED TO BE A CERTIFIED INSTALLER OF THE FINAL ROOFING PRODUCT/MFR. SELECTION.
- D. REFER TO STRUCTURAL, MECHANICAL, AND PLUMBING PLANS FOR ADDITIONAL INFORMATION REGARDING ROOF PENETRATIONS & OPENINGS.
- E. REFER TO WALL SECTIONS FOR COPING DETAILS.
- F. THE CONTRACTOR SHALL COORDINATE STRUCTURAL STEEL OPENING SIZES W/ ALL ROOF CURB SIZES PRIOR TO COMMENCEMENT OF WORK.
- G. REFER TO A-900 FOR PRODUCT INFORMATION. PRODUCTS INCLUDE SKYLIGHTS, ROOF HATCH, & ROOF ACCESS LADDERS.

ROOF PLAN NOTES:

(1) EXISTING ROOFING TO REMAIN

- 2 NEW EDPM MEMBRANE ROOFING AND RIGID INSULATION
- 3 NEW RTU AND CURB. SEE MECHANICAL DRAWINGS.
- (4) NEW COPING AT PARAPET WALL. SEE WALL SECTIONS.
- 5 NEW SKYLIGHT AND CURB. SEE STRUCTURAL PLANS FOR EXACT LOCATION.
- 6 NEW CANOPY BELOW
- 7 NEW ROOF DRAIN
- 8 NEW TAPERED INSULATION ROOF SADDLE
- (9) NEW ROOF STRUCTURE TO SLOPE TO DRAINS. SEE STRUCTURAL DRAWINGS.
- (10) NEW ROOF HATCH WITH INTEGRAL CURB.
- (11) NEW EDPM WALKWAY PADS
- (12) NEW ROOF ACCESS LADDER
- (13) EXISTING HVAC EQUIPMENT
- (14) EXISTING ROOF ACCESS HATCH
- (15) EXISTING WALKING PADS
- (16) EXISTING COPING
- (17) NEW GUTTER
- (18) NEW THROUGH WALL OVERFLOW SCUPPER
- (19) EXISTING ROOF SLOPE DOWN
- (20) NEW ROOF SLOPE DOWN
- (21) EXISTING GUTTER
- (22) EXISTING EXHAUST VENT
- (23) NEW EXHAUST VENT



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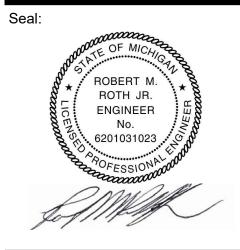
Client:

City of Taylor 23555 Goddard Rd. Taylor, MI 48180

Project:

City of Taylor Animal Shelter Remodel & Expansion


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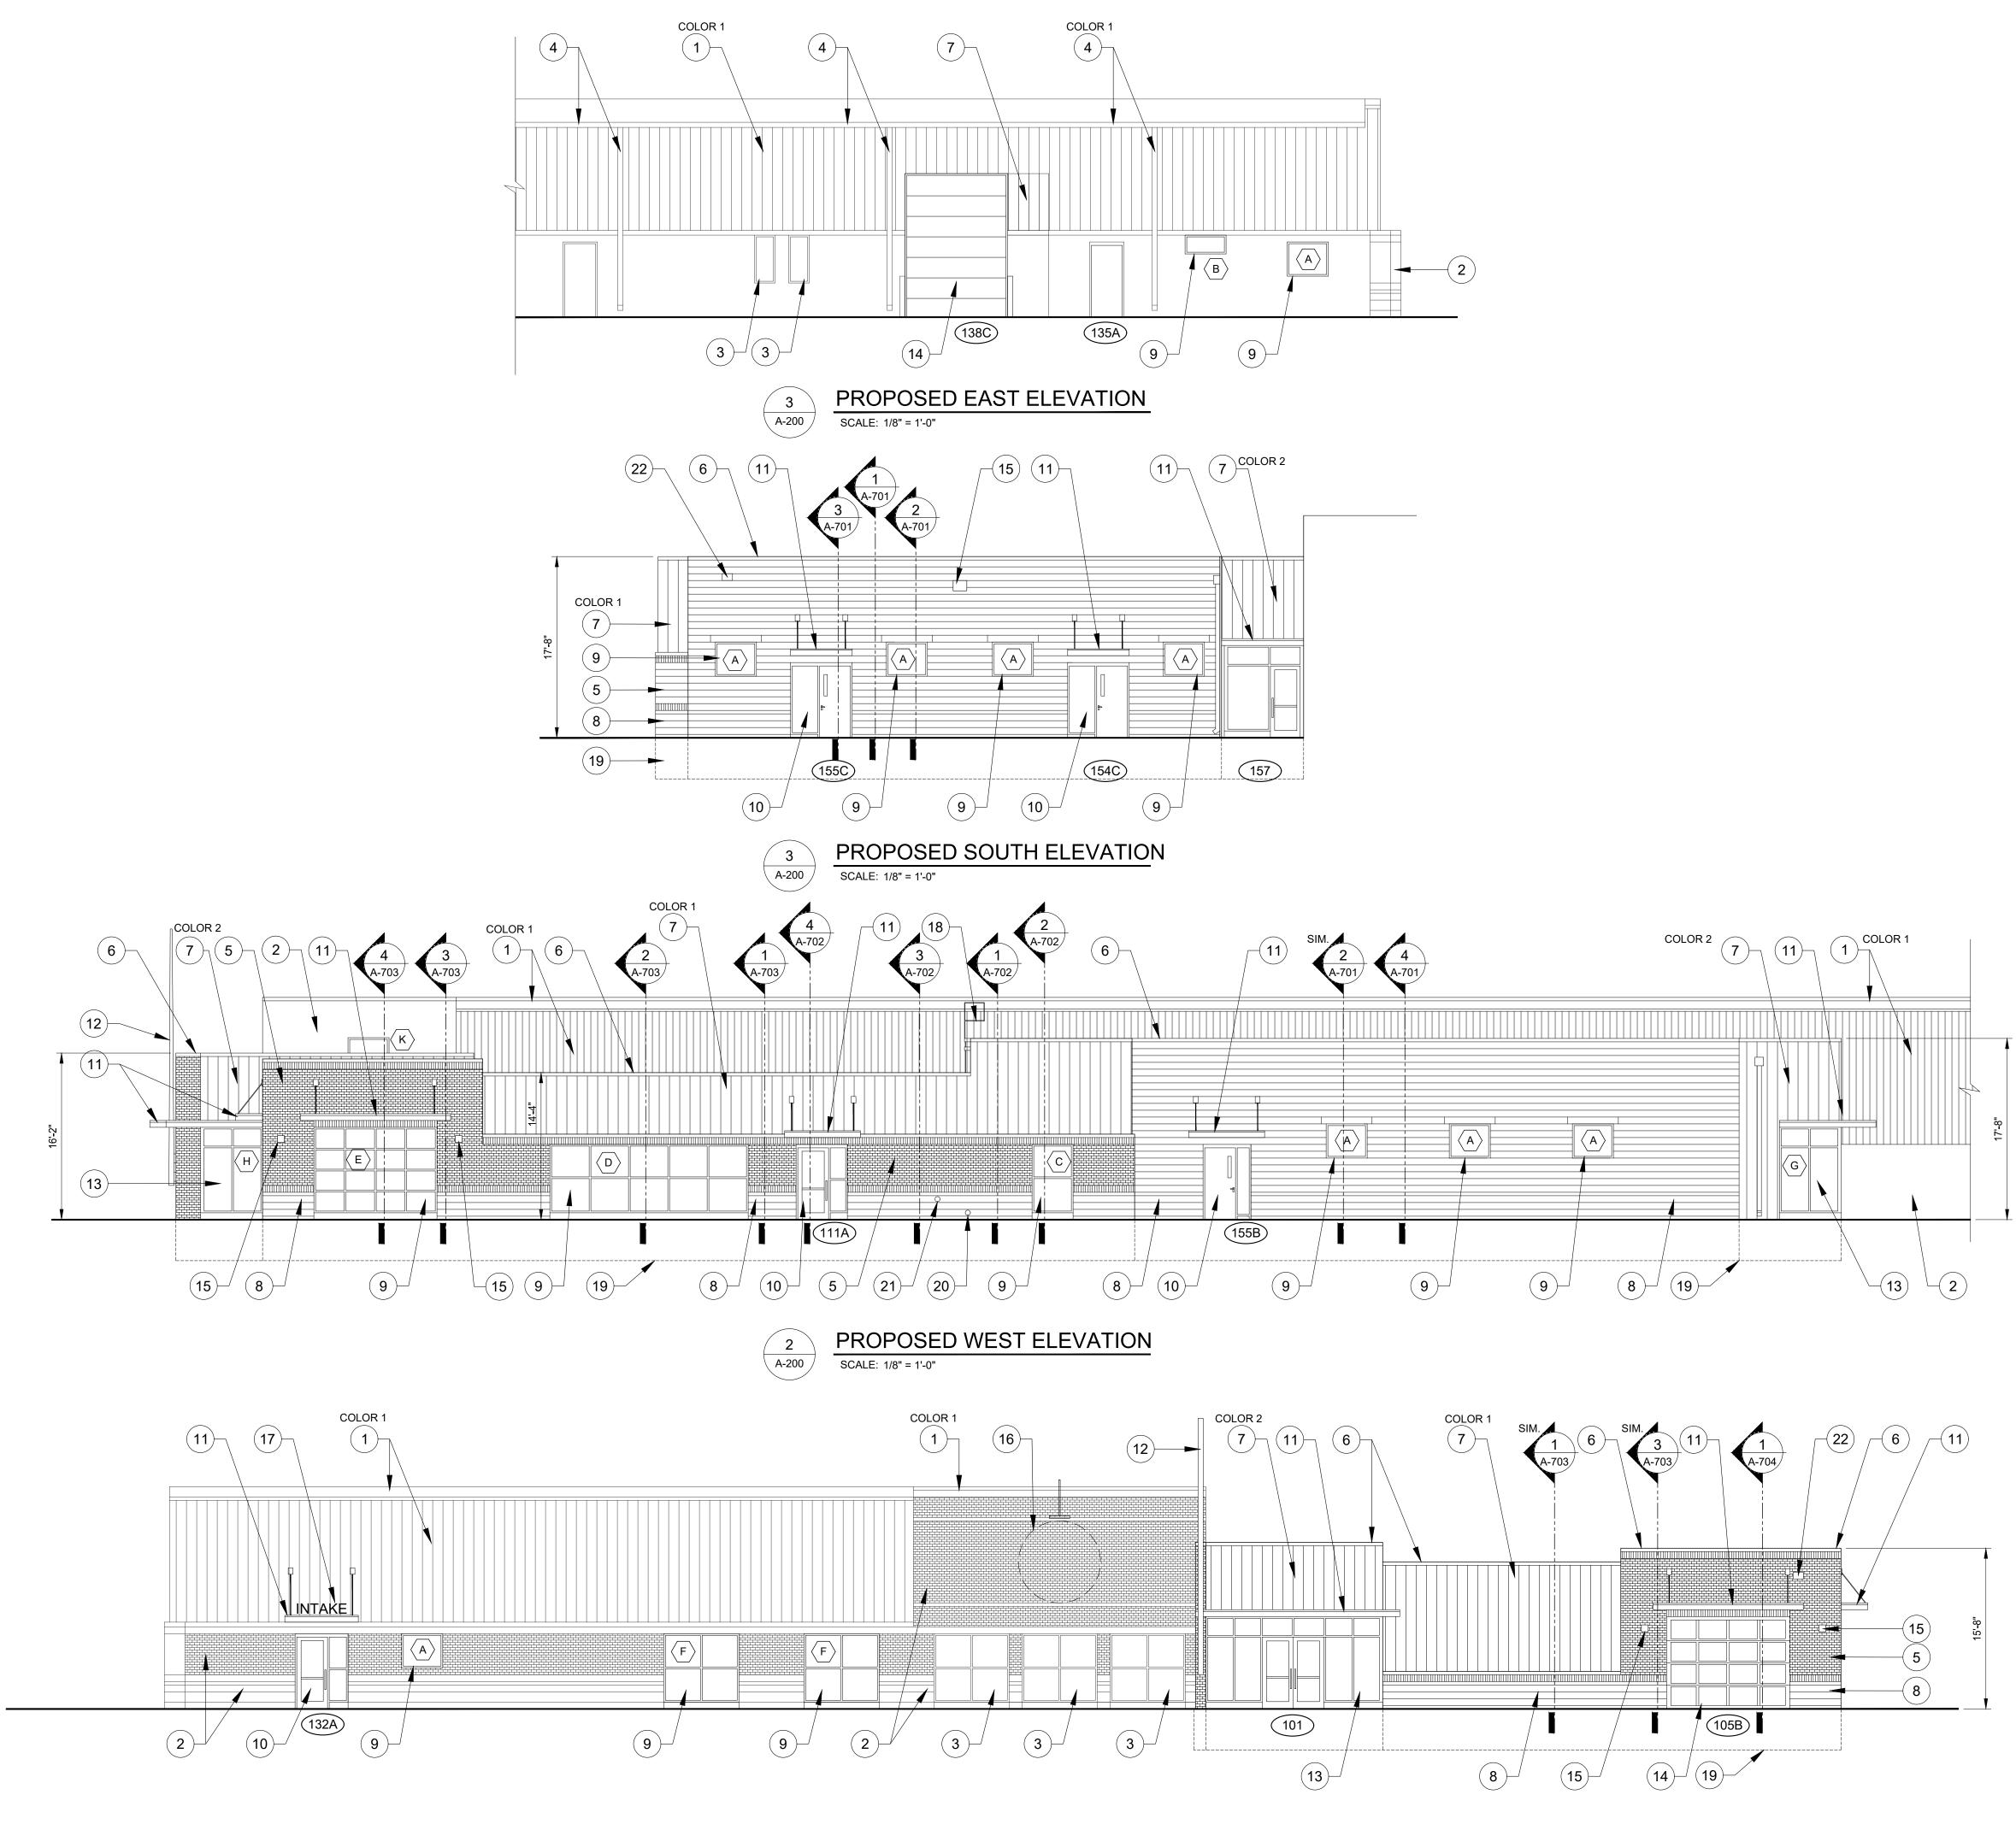
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10-18-2023	50% Complete Review
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01-17-2024	Permit Review

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Checked:	WD
Approved:	MR

Sheet Title: ROOF PLAN



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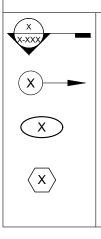


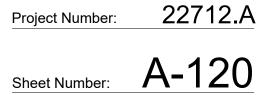1 A-200

PROPOSED NORTH ELEVATION

SCALE: 1/8" = 1'-0"

LEGEND:



KEY NOTE NEW DOOR TAG

BUILDING SECITON SYMBOL

(SEE SHEET A-900 FOR MORE INFO.)

NEW WINDOW TAG (SEE SHEET A-900 FOR MORE INFO.)

GENERAL NOTES:

- A. REFER TO SHEET A-901 FOR EXTERIOR MATERIAL INFORMATION.
- B. NEW SPLIT-FACE BLOCK TO MATCH EXISTING.
- C. NEW FACBRICK TO MATCH EXISTING.
- D. NEW METAL SIDING PROFILE TO MATCH EXISTING. AT COLOR 1 LOCATIONS.
- E. NEW METAL SIDING TO BE FLUSH PANEL PROFILE AT COLOR 2 LOCATIONS.

ELEVATION KEY NOTES:

- 1 EXISTING METAL SIDING AND COPING (TO BE PAINTED) (SEE A-901)
- 2 EXISTING MASONRY (TO BE POWER WASHED)
- 3 EXISTING WINDOW
- 4 EXISTING GUTTER & DOWNSPOUT (TO BE PAINTED)
- 5 NEW FACEBRICK VENEER TO MATCH EXISTING (SEE A-901)
- 6 NEW METAL COPING THROUGHOUT
- 7 NEW METAL SIDING COLOR 1 & COLOR 2 (SEE A-901)
- 8 NEW SPLIT-FACE BLOCK TO MATCH EXISTING
- 9 NEW WINDOW
- (10) NEW DOOR
- (11) NEW METAL CANOPY
- (12) RELOCATED WALL MOUNTED FLAG POLE
- (13) NEW STOREFRONT SYSTEM
- (14) NEW OVERHEAD SECTIONAL DOOR
- 15 NEW WALL MOUNTED LIGHT FIXTURE
- (16) LOCATION OF NEW WALL MOUNTED SIGN
- (17) NEW METAL LETTERING FIXED TO CANOPY
- (18) NEW ROOF ACCESS LADDER
- (19) LINE OF NEW FOOTING
- 20) NEW BRASS 'COWS TONGUE' DOWNSPOUT
- 1) NEW FIRE DEPARTMENT CONNECTION (FDC)
- (22) NEW THROUGH-WALL OVERFLOW SCUPPER



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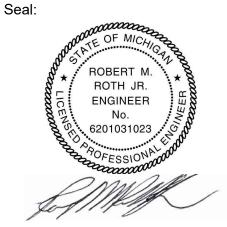


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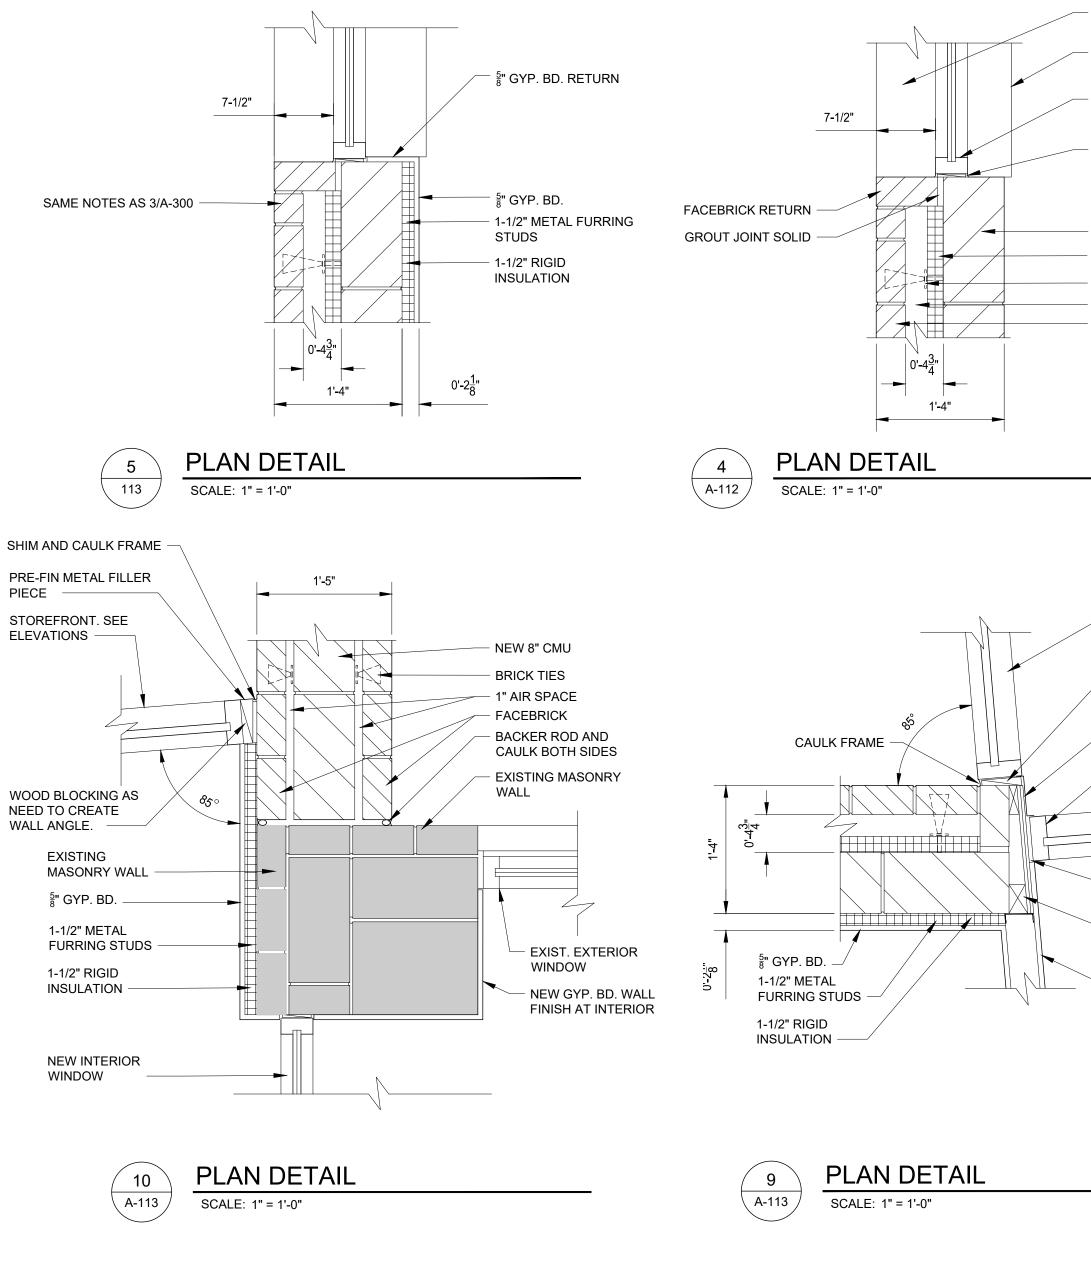



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Approved:	MR

Sheet Title: ELEVATIONS

Project Number: 22712.A





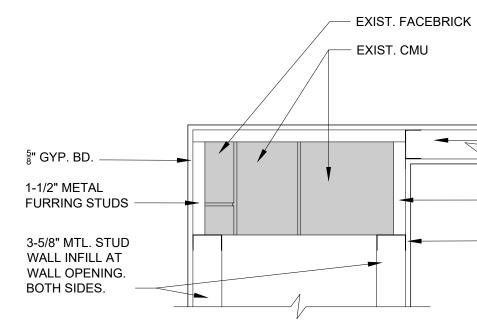



PRE-FIN METAL WINDOW WASH BELOW


- LINE OF WINDOW SILL BELOW

ALUMINUM WINDOW FRAME

- SHIM AND CAULK WINDOW FRAME/JAMBS

- 8" CMU 2" RIGID INSULATION

- BRICK TIES - AIR SPACE - FACEBRICK

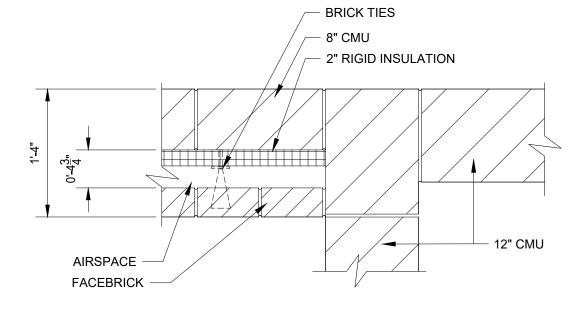


PLAN DETAIL

SCALE: 1" = 1'-0"

3 `


A-112

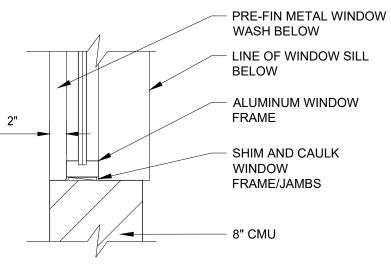

PLAN DETAIL 2 A-112 SCALE: 1" = 1'-0"

SCALE: 1" = 1'-0"

A-113

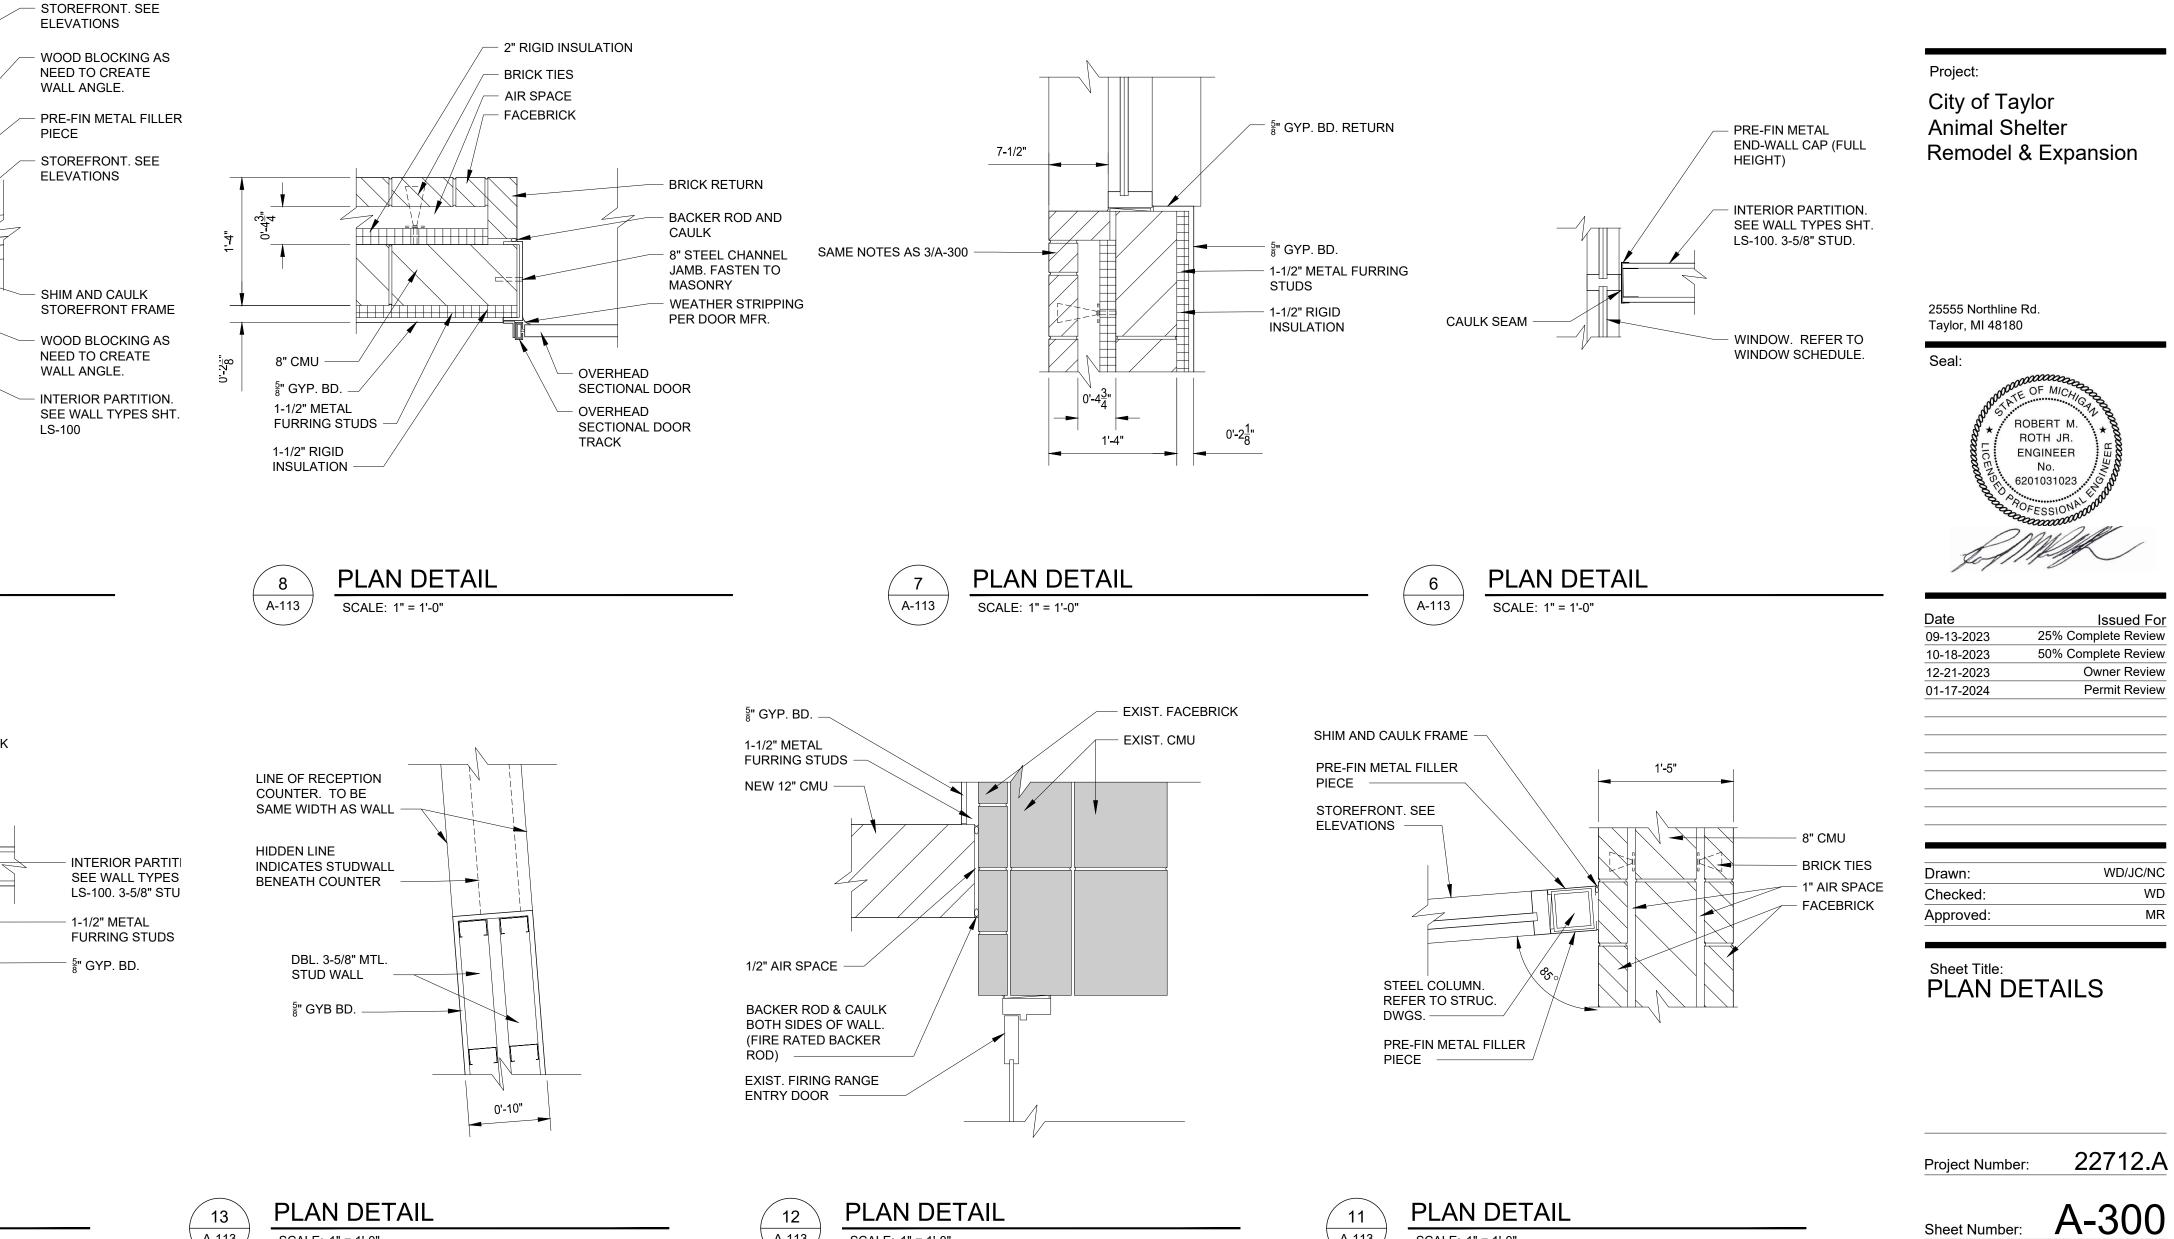

A-113

SCALE: 1" = 1'-0"

GENERAL NOTES:

- A. REFER TO LS-100 WALL TYPE INFORMATION. WALL CAVITY INSULATION NOT SHOWN THIS SHEET.
- B. REFER TO STRUCTURAL DRAWINGS FOR MASONRY WALL INFORMATION.



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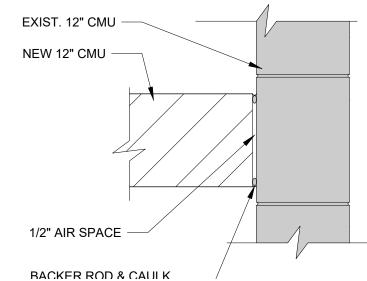
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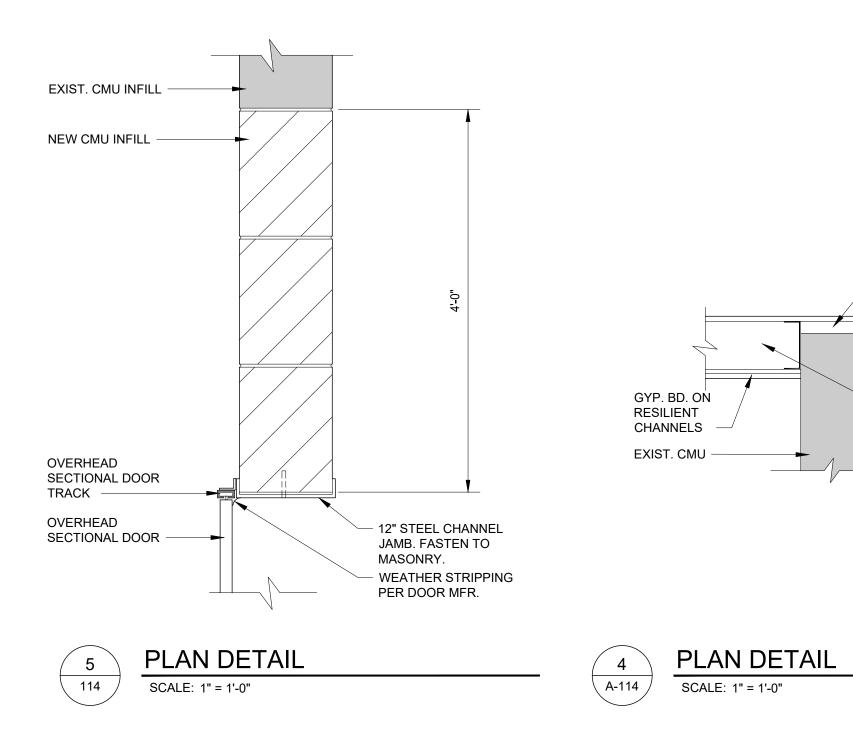





PLAN DETAIL SCALE: 1" = 1'-0"

SCALE: 1" = 1'-0"


A-113 /



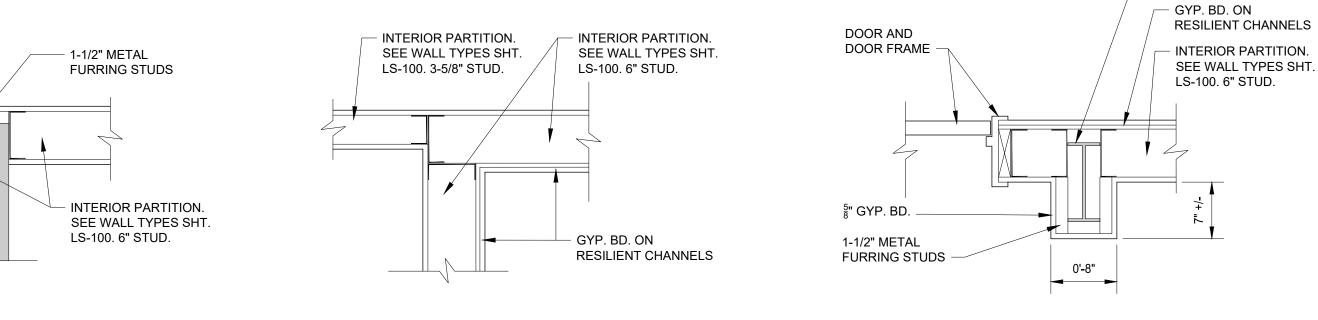





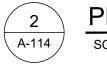

PLAN DETAIL SCALE: 1" = 1'-0"

GENERAL NOTES:

A. REFER TO LS-100 WALL TYPE INFORMATION. WALL CAVITY INSULATION NOT SHOWN THIS SHEET.

- GYP. BD. ON

RESILIENT CHANNELS

- INTERIOR PARTITION.

SEE WALL TYPES SHT.

LS-100. 6" STUD.

B. REFER TO STRUCTURAL DRAWINGS FOR MASONRY WALL INFORMATION.



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3-5/8" MTL. STUD

WALL INFILL AT WALL OPENING.

BOTH SIDES.


EXIST. CMU -

⁵/₈" GYP. BD. –

1-1/2" METAL

FURRING STUDS -


- EXIST. STEEL COLUMN

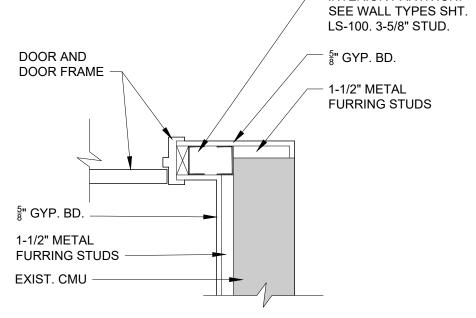

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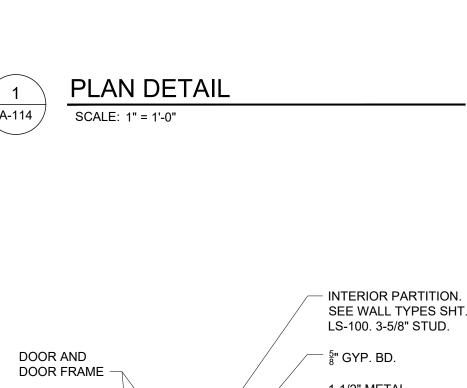
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1'-0"

-

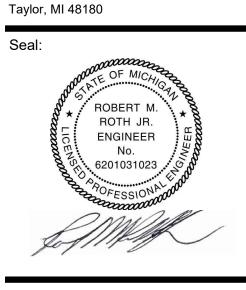


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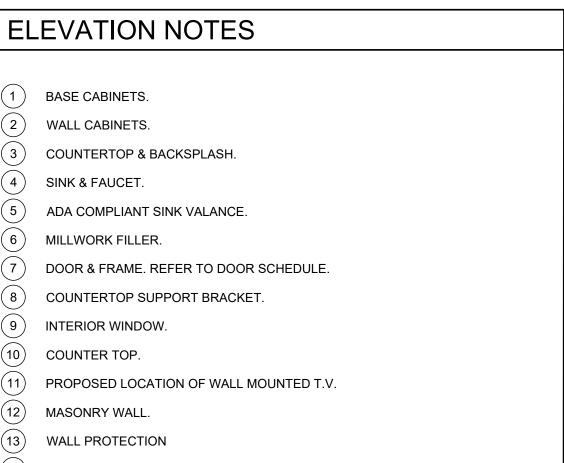
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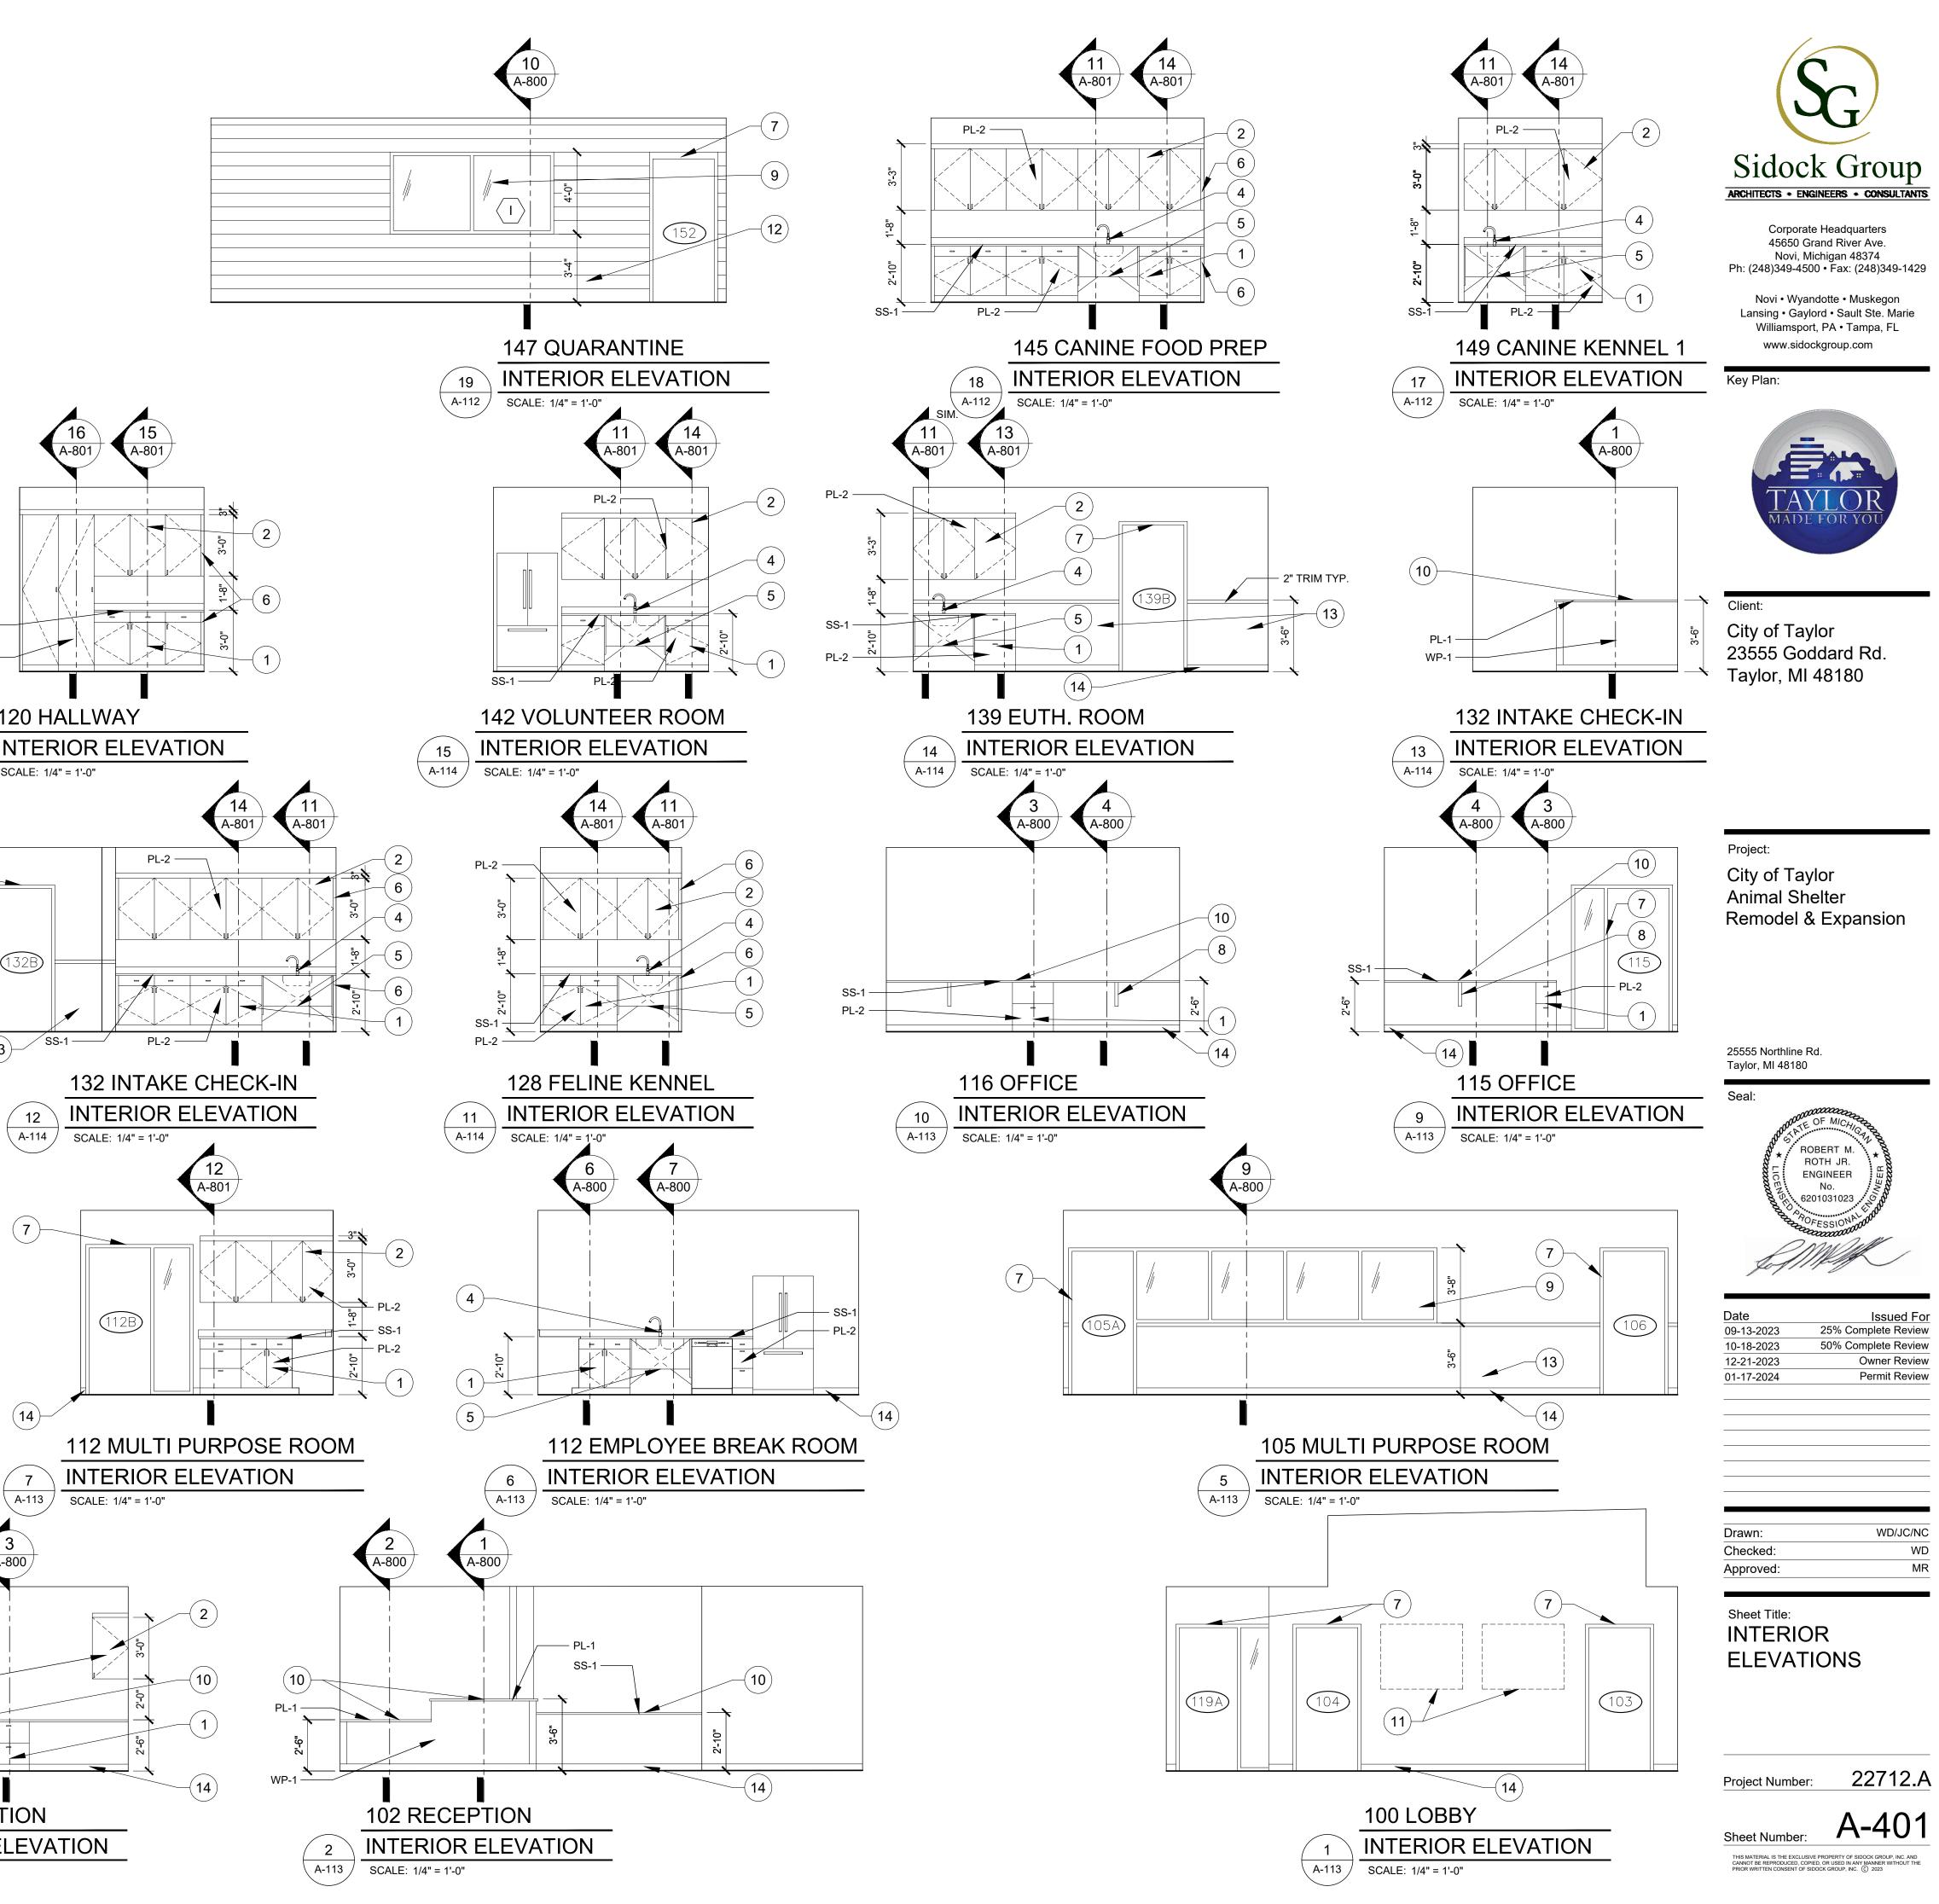
- A. ELECTRICAL OUTLETS & SWITCHES NOT SHOWN ON ELEVATIONS. REFER TO ELECTRICAL PLANS FOR LOCATIONS OF SUCH DEVICES. REFER TO CS-002 FOR TYPICAL MOUNTING HEIGHTS.
- B. REFER TO ROOM SCHEDULE FOR WALL FINISHES.


ELEVATION NOTES


- 1 2'-0" X 1'-0" WALL TILE
- 2 0'-3" X 0'-6" WALL TILE
- 3 DOOR & FRAME. REFER TO DOOR SCHEDULE
- 4 PREFAB SHOWER
- 5 TOILET PARTITIONS
- 6TOILET7URINAL
- (8) GRAB BARS
- 9 SINK
- 10 MIRROR
- (11) SOAP DISPENSER
- (12) PAPER TOWEL DISPENSER
- 13 TOILET PAPER DISPENSER
- (14) SANITARY NAPKIN DISPOSAL






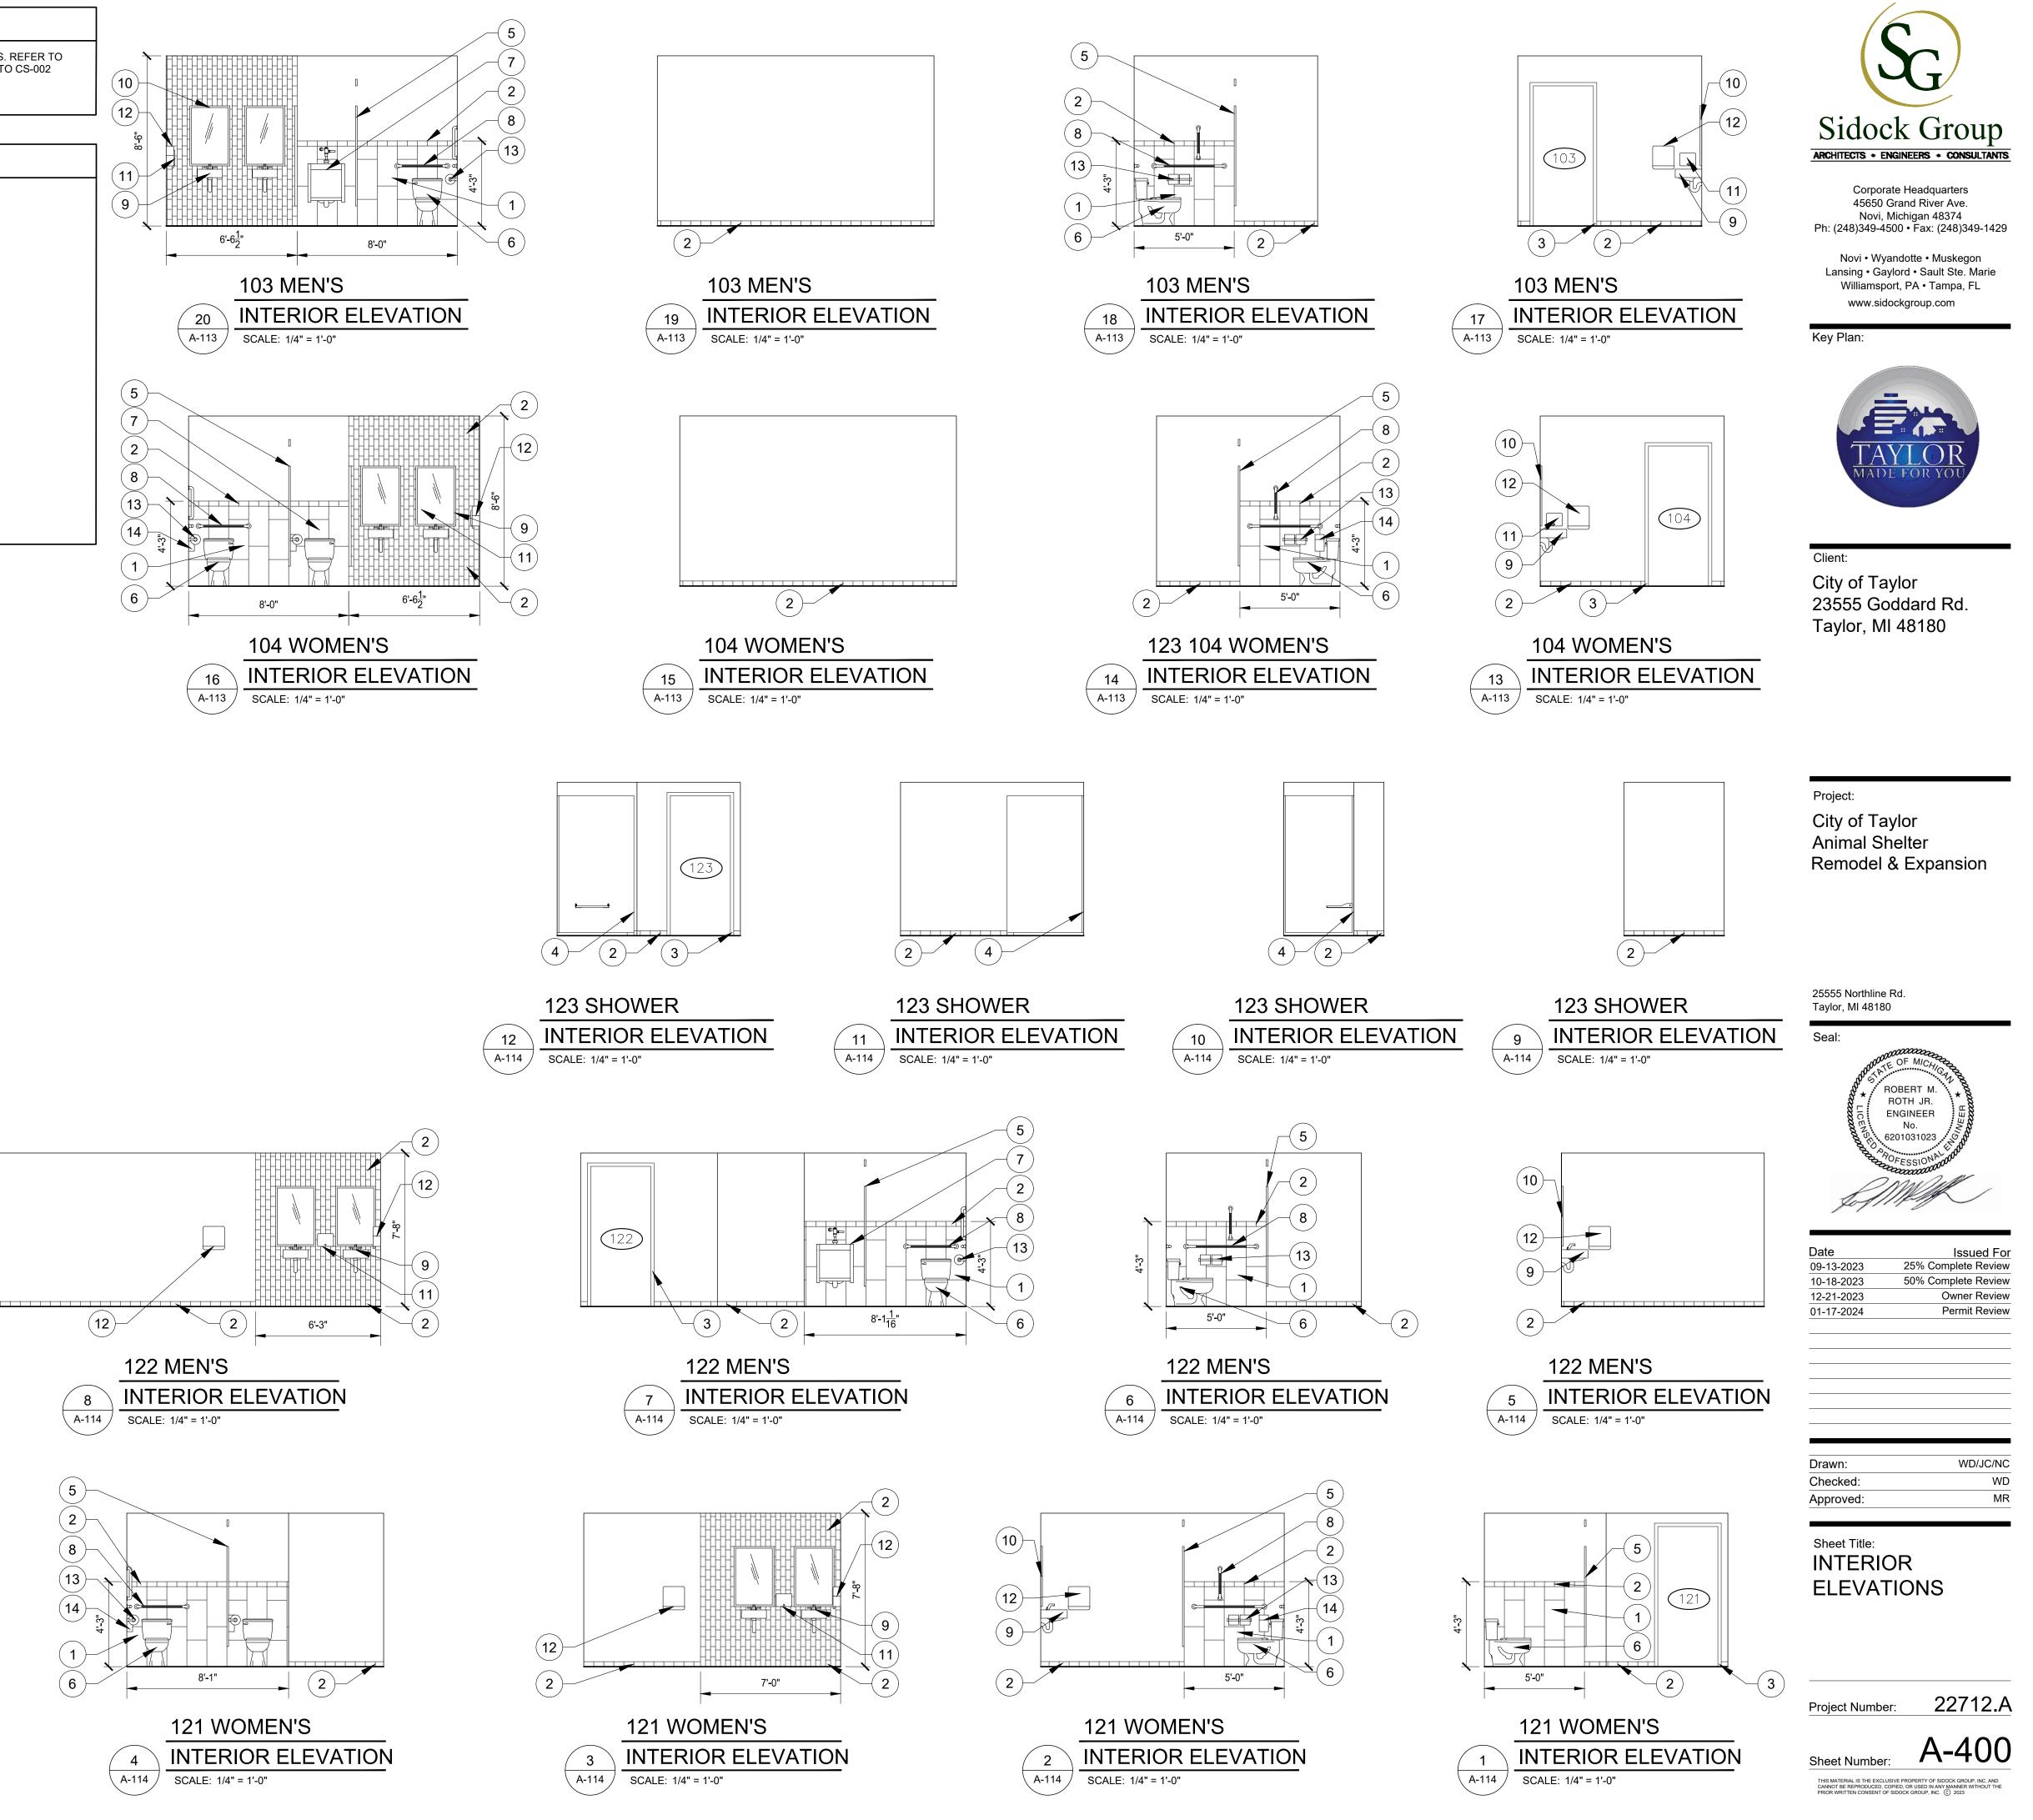

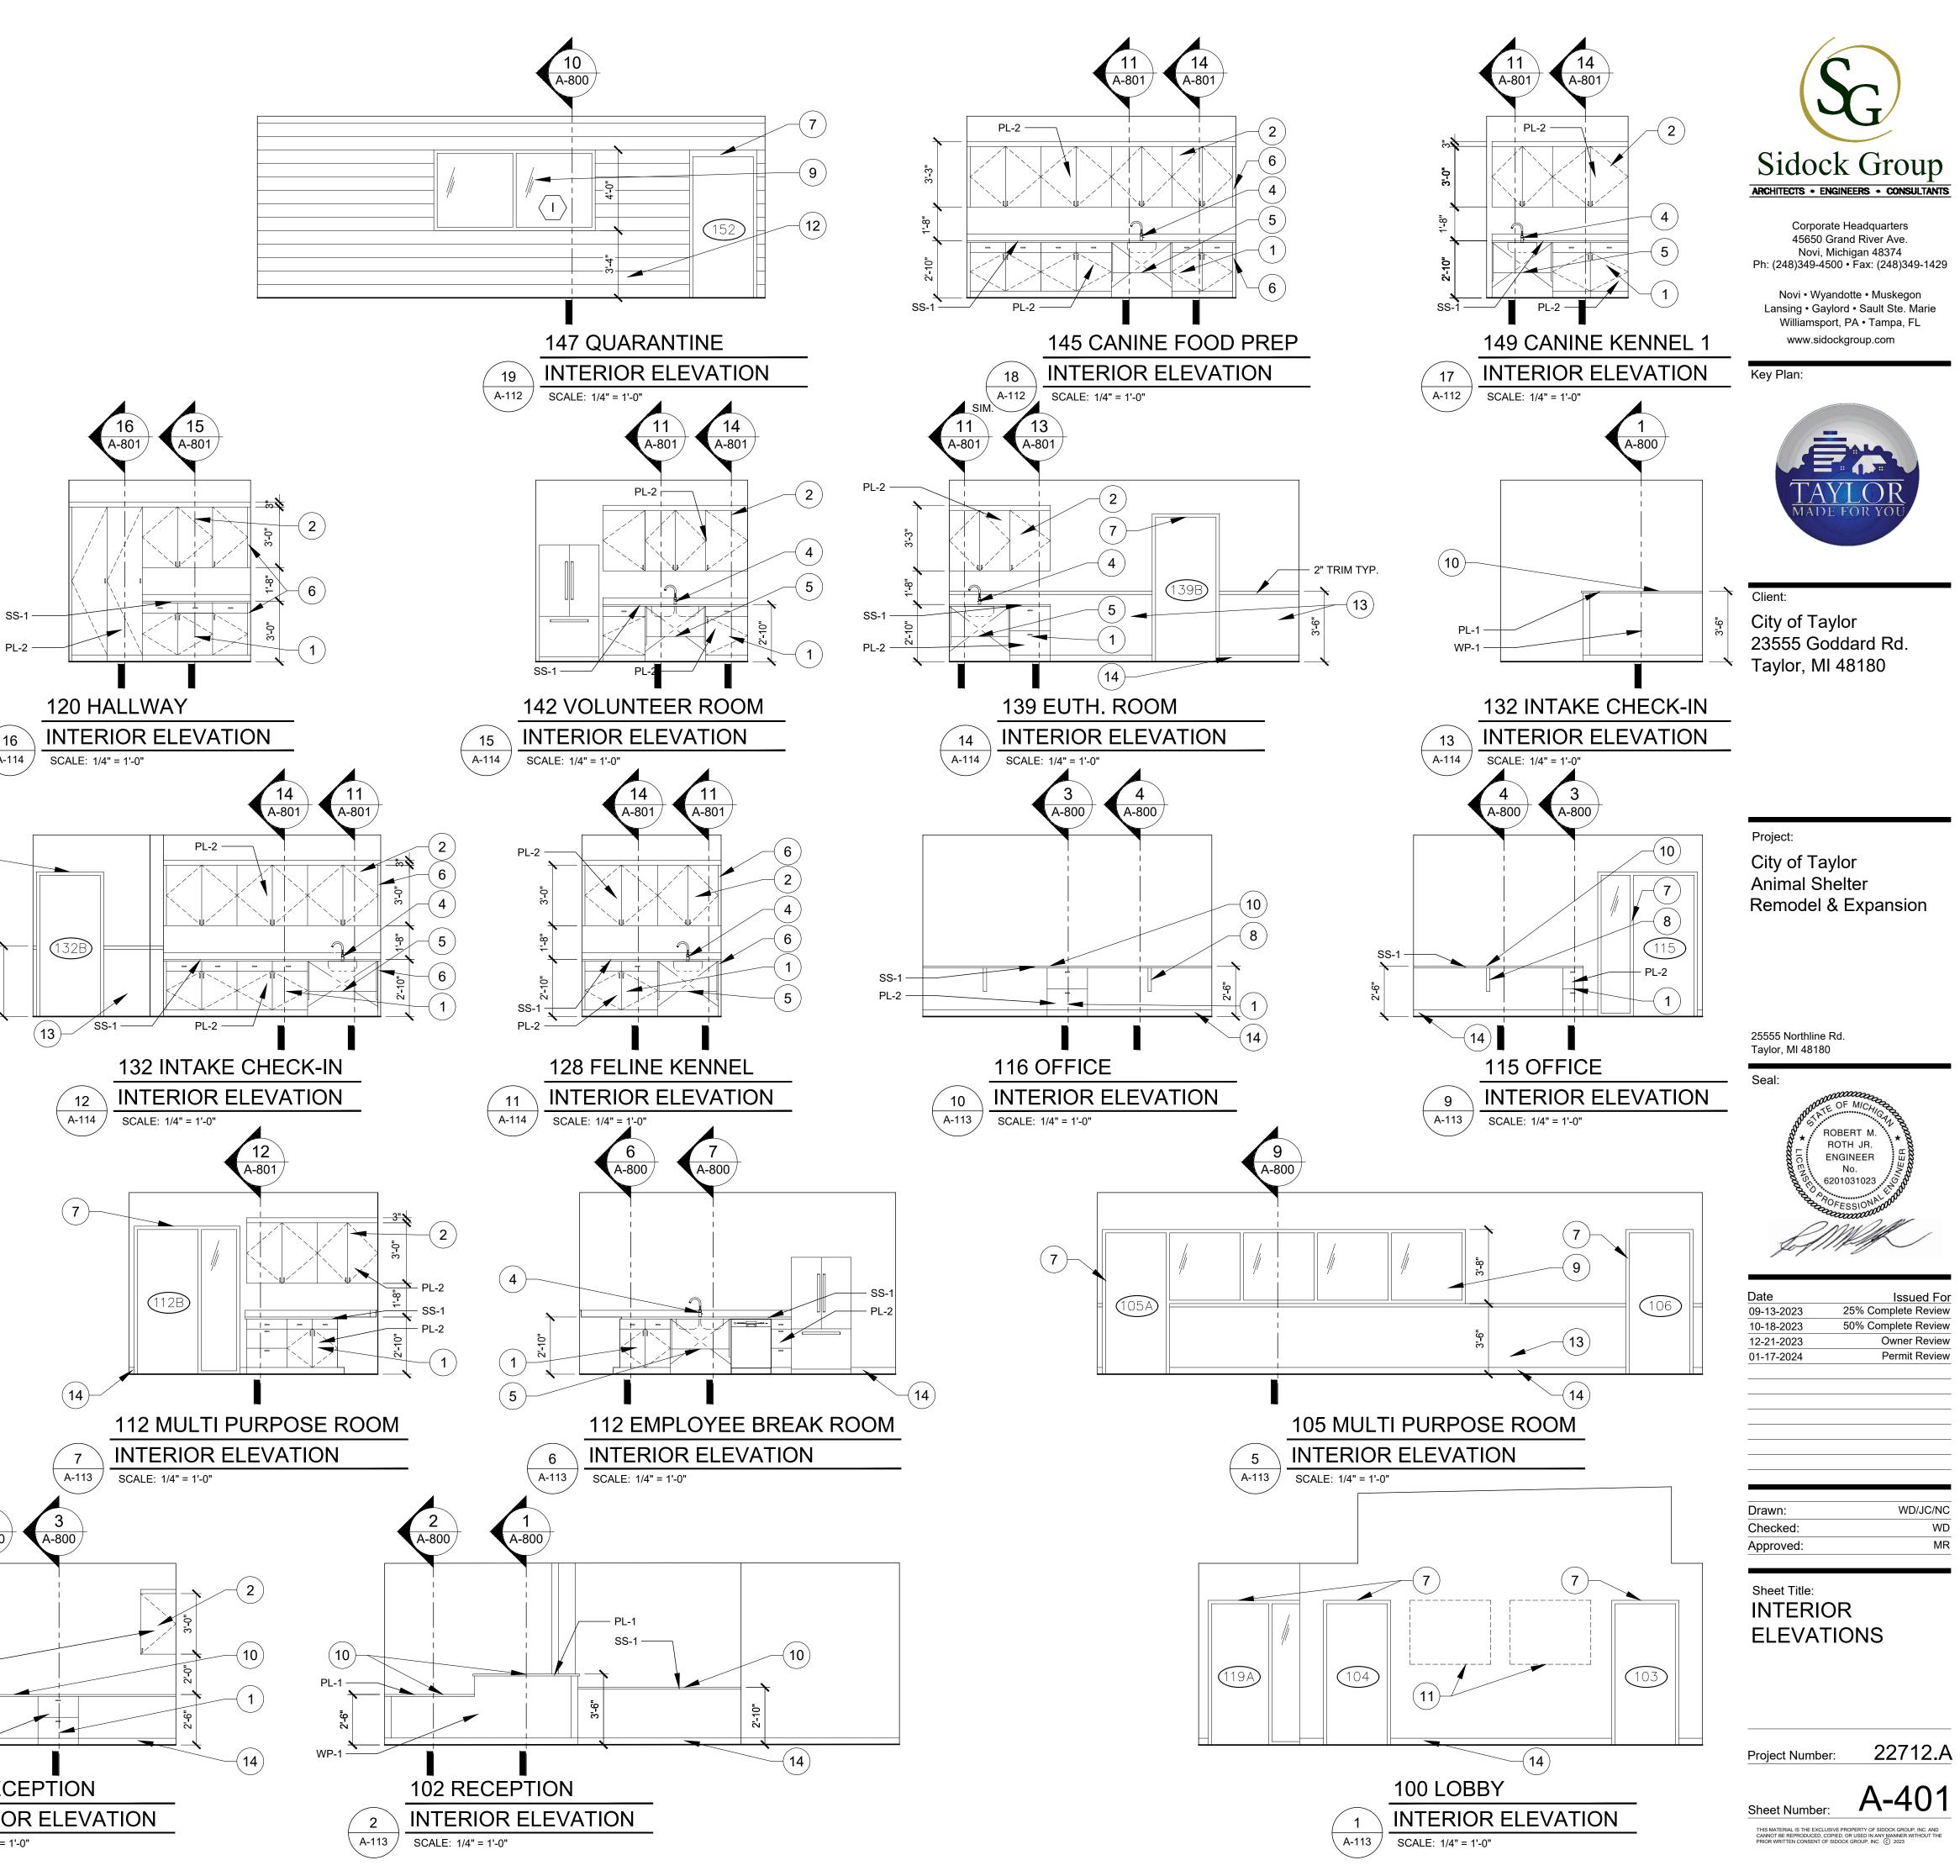

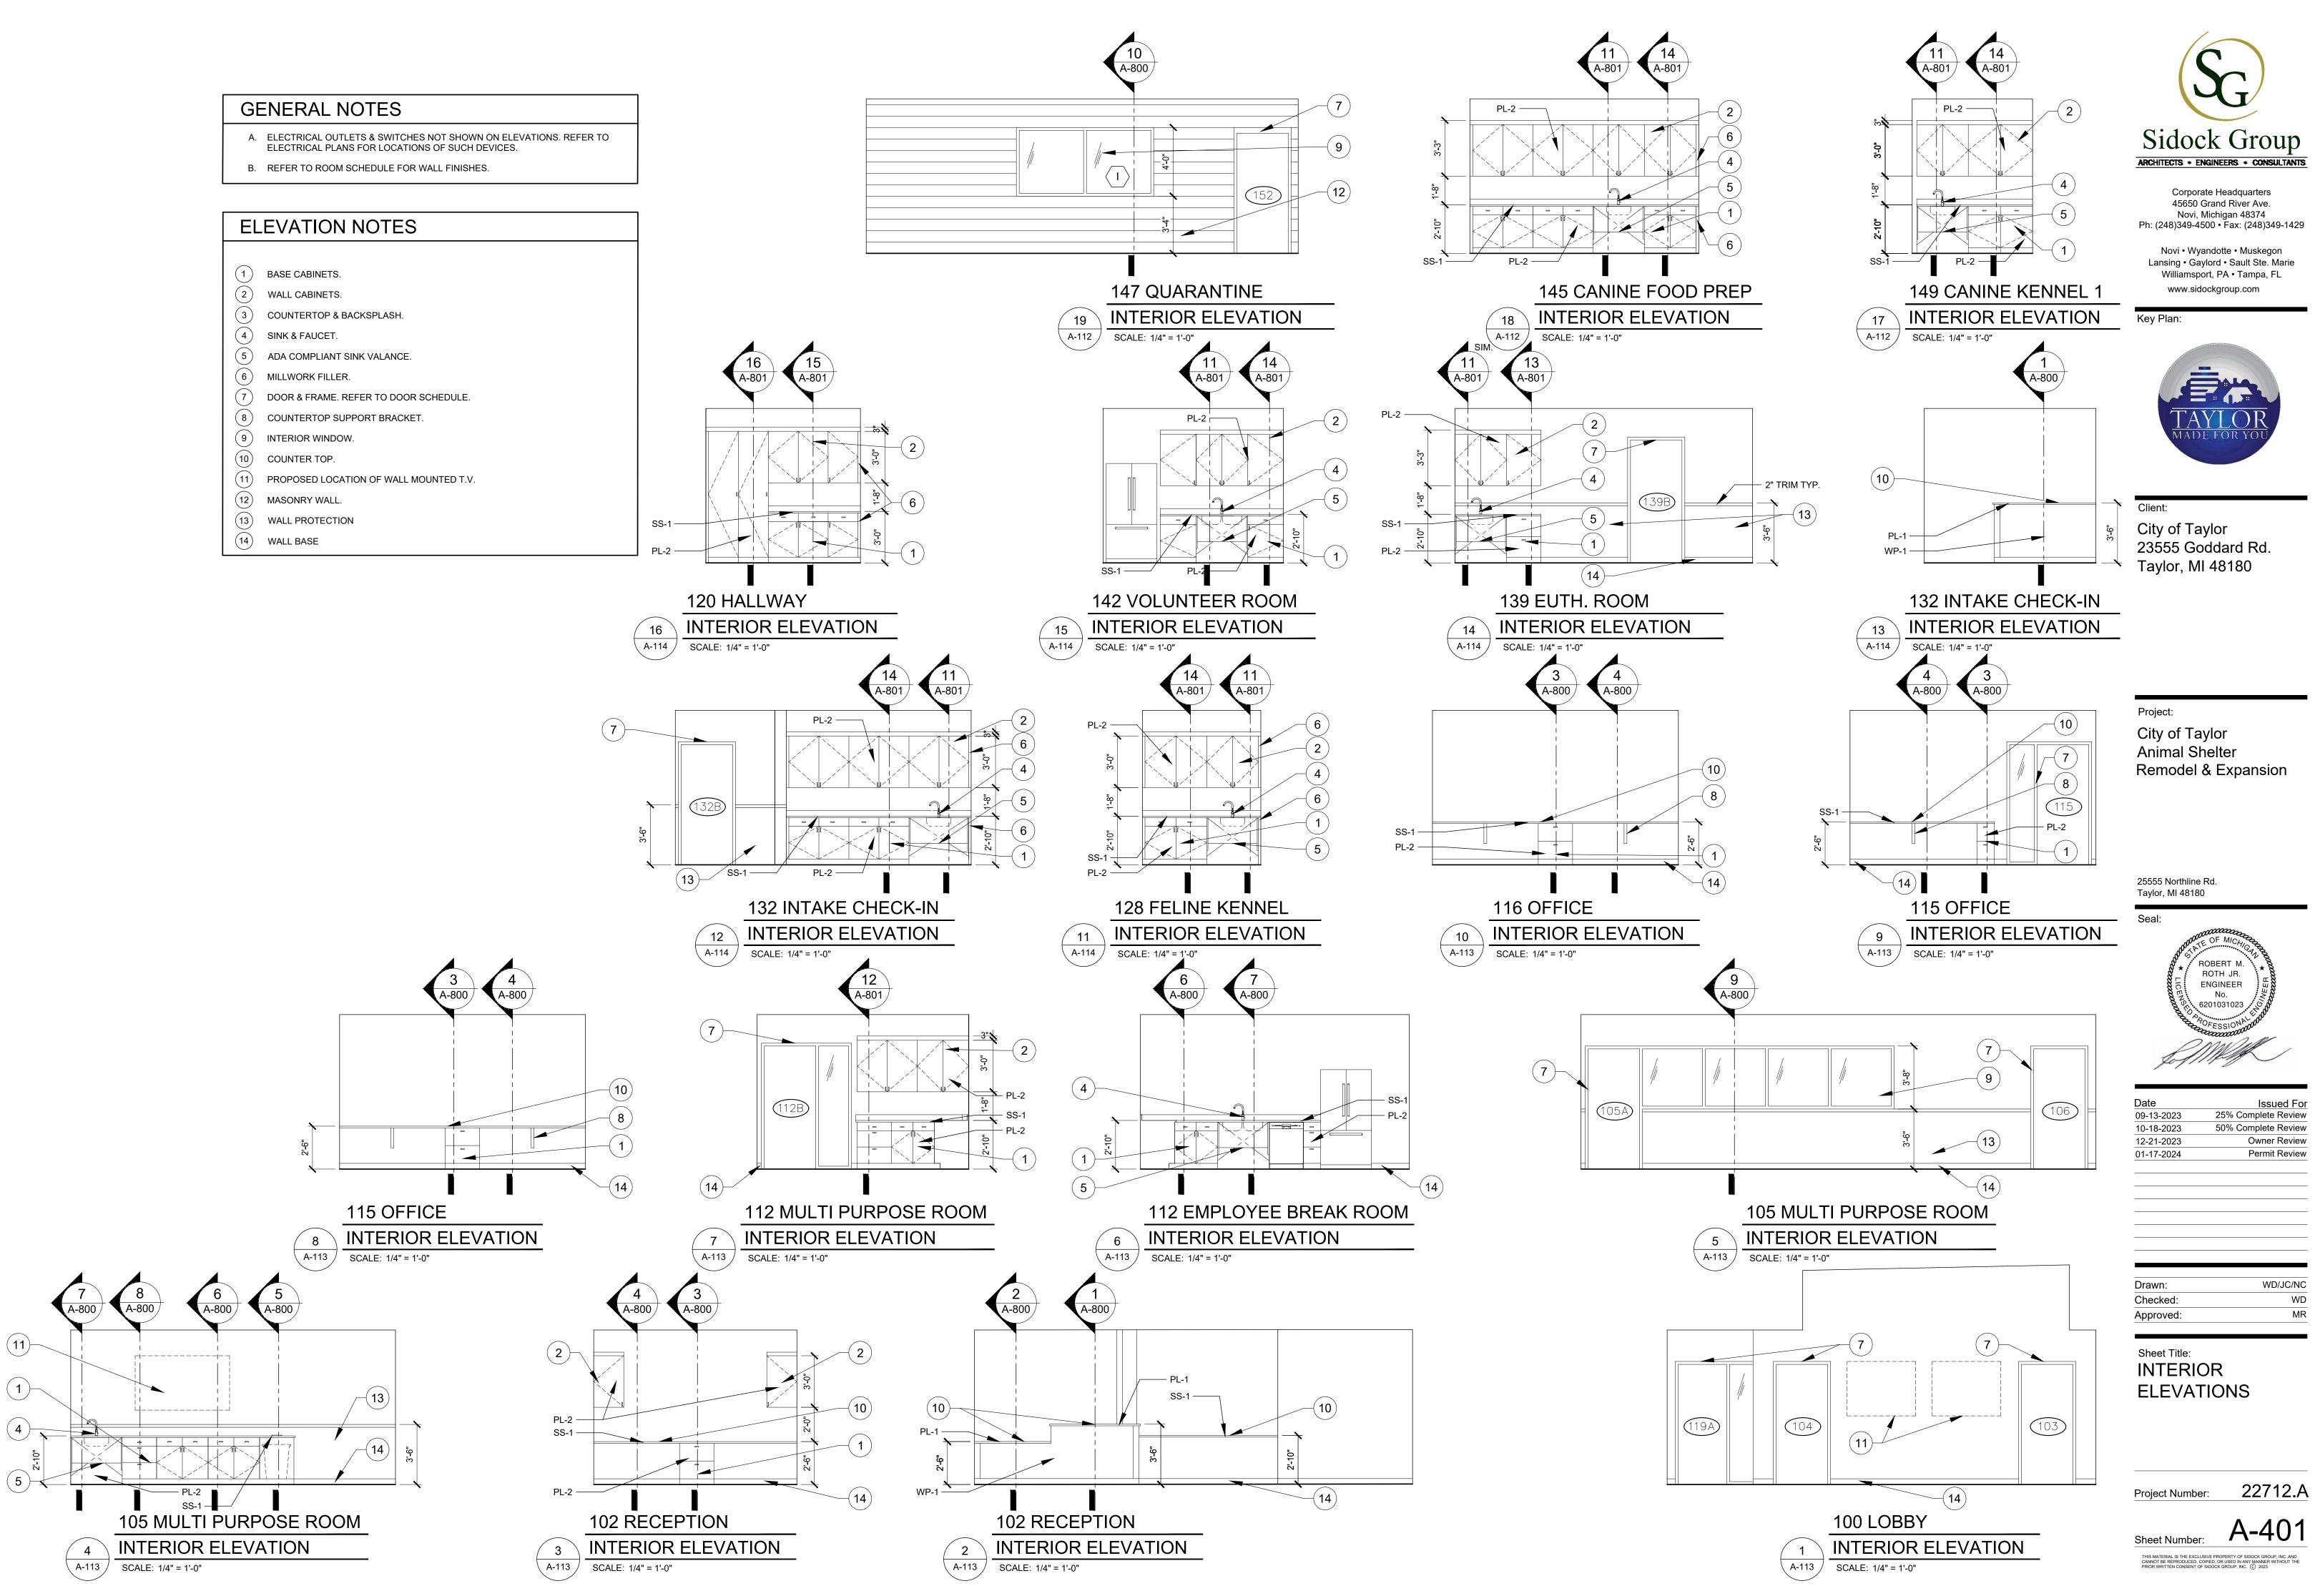

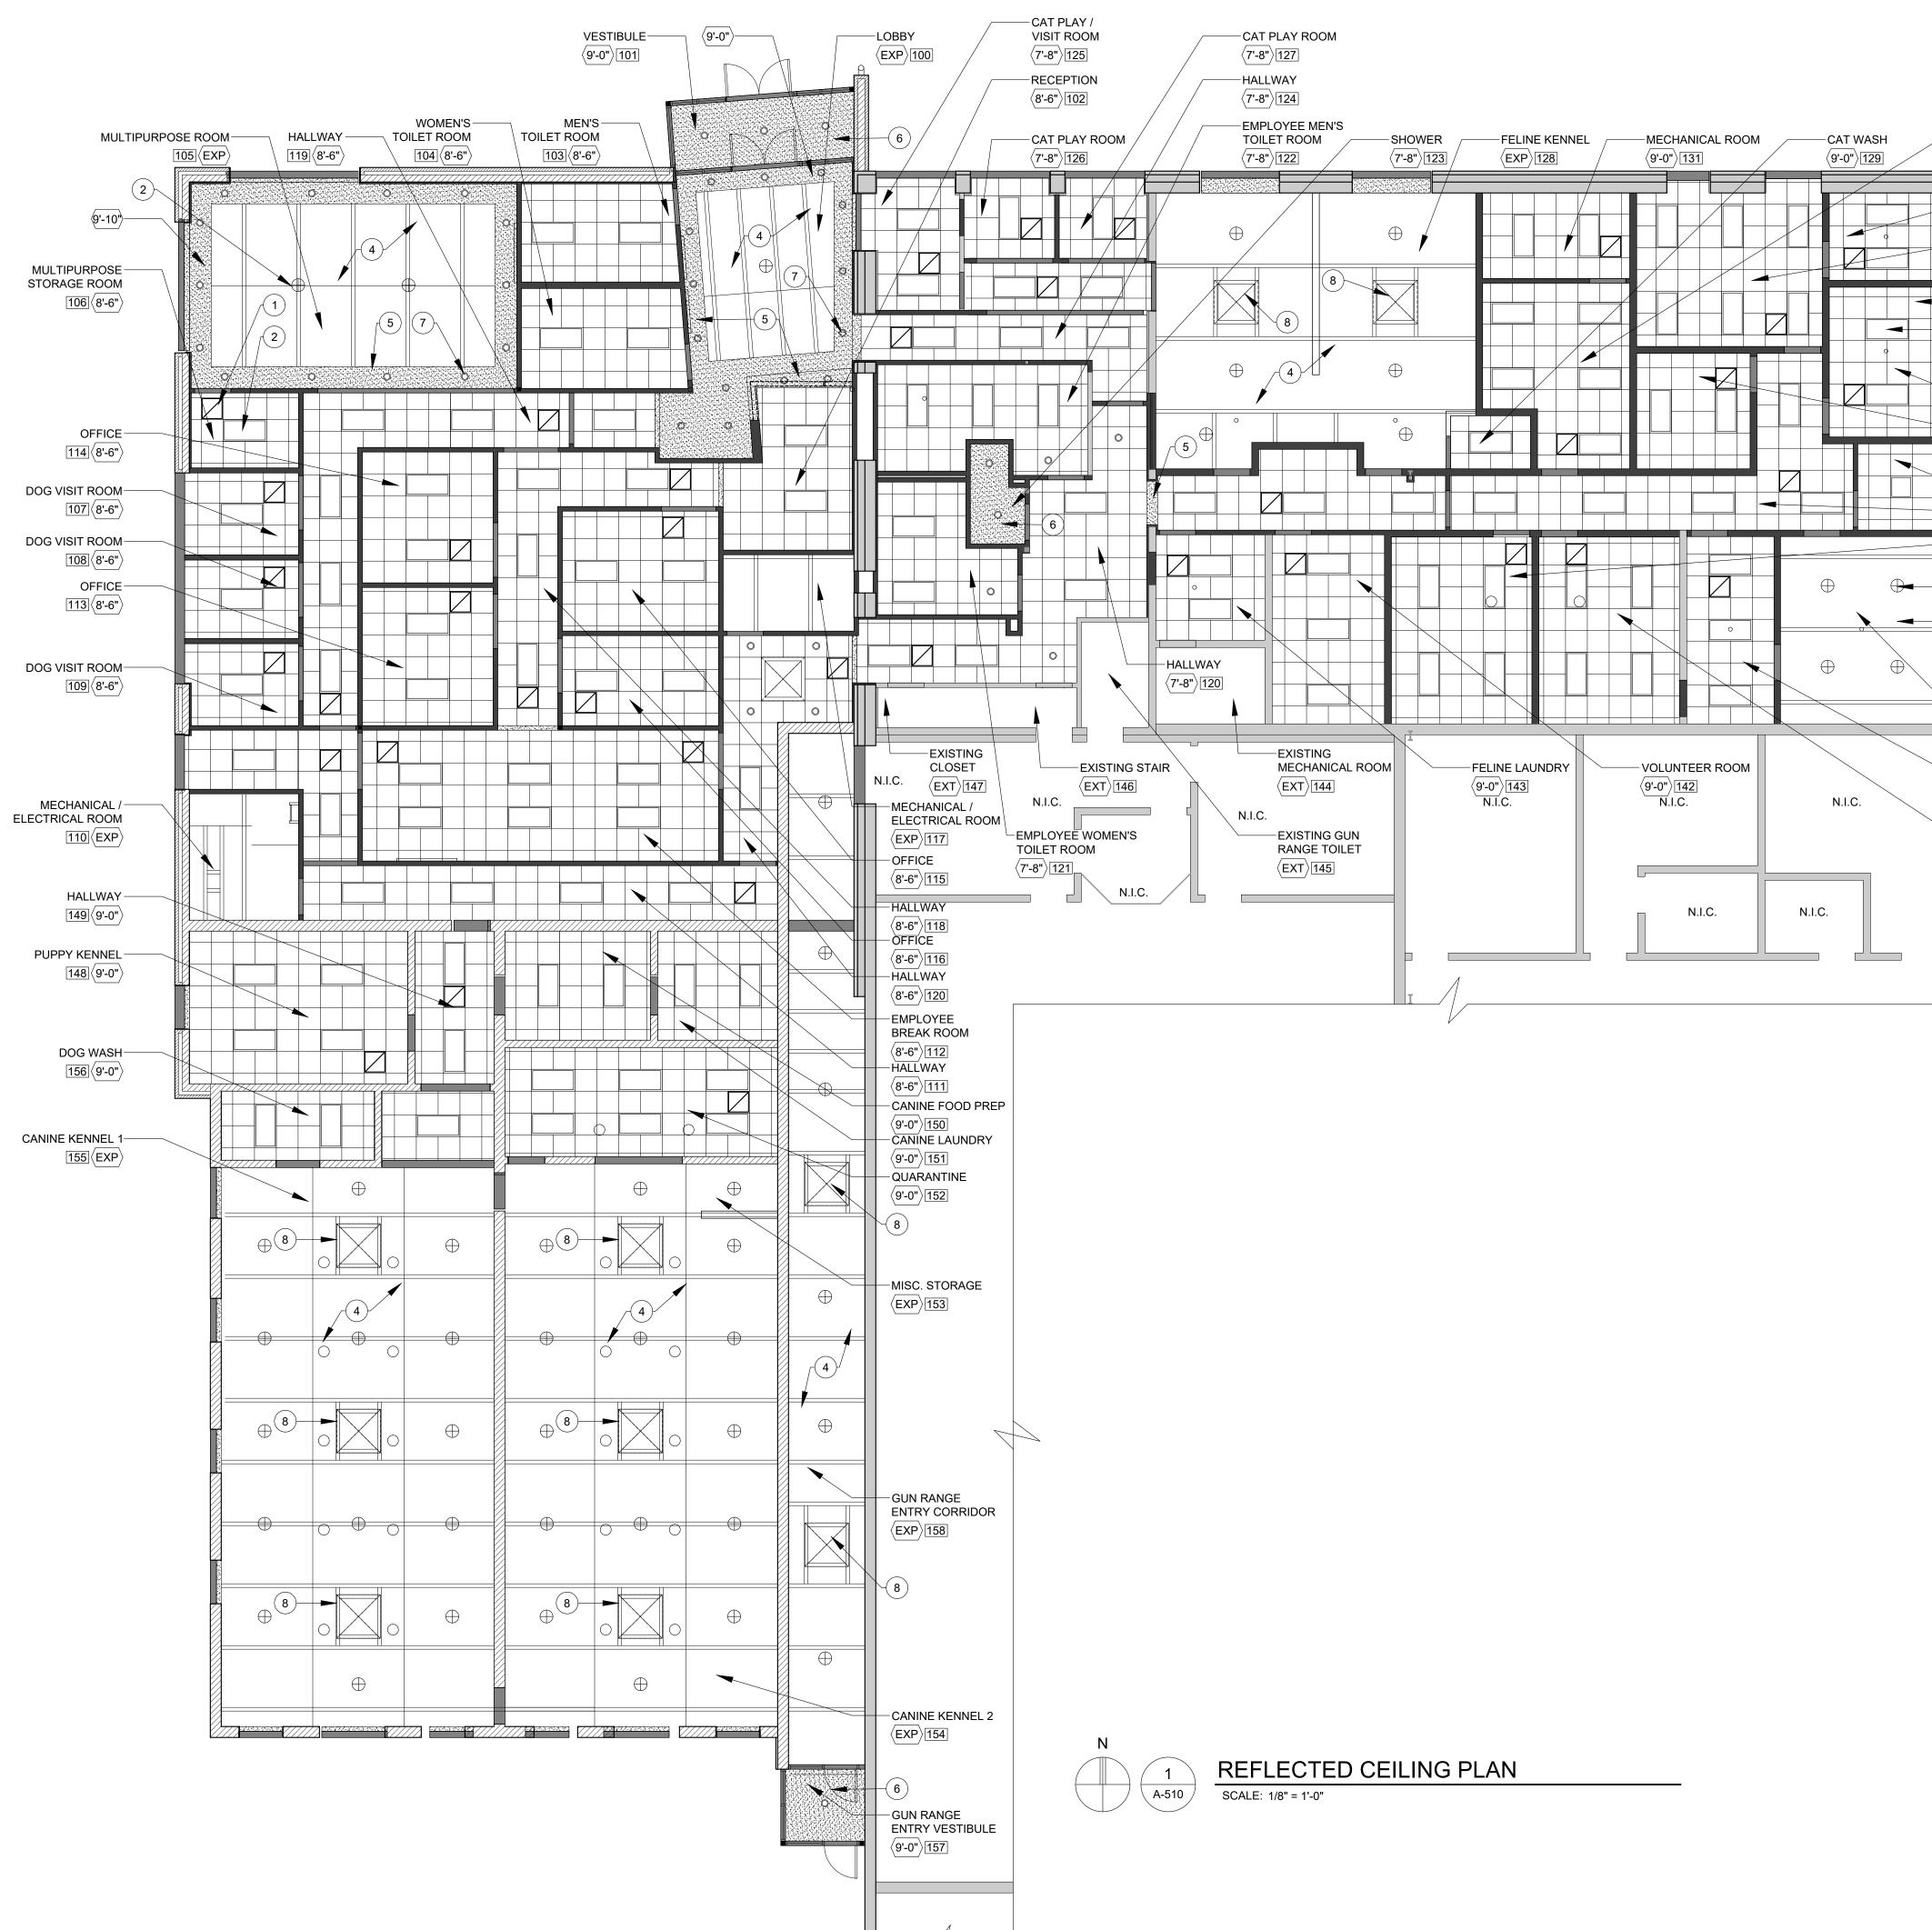

				UG -
	——MISC. STORAGE			Sidock Group
_	<pre></pre> (9'-0") 130	REFLEC	TED CEILING PLAN NOTES:	ARCHITECTS + ENGINEERS + CONSULTANTS
	CAT ISO. $\langle 9'-0" \rangle 133$ INTAKE CHECK-IN / GUEST VET $\langle 9'-0" \rangle 132$ 1 2	12x2 LAY-II22x4 LAY-II3PENDANT4EXPOSED5GYP. BOA	N CEILING SYSTEM (TYP.) N LIGHT FIXTURE (TYP.) MOUNTED LIGHT FIXTURE (TYP.) ROOF FRAMING STRUCTURE ABOVE (PAINTED) RD SOFFIT/DROP (PAINTED) RD CEILING (PAINTED)	Corporate Headquarters 45650 Grand River Ave. Novi, Michigan 48374 Ph: (248)349-4500 • Fax: (248)349-1429 Novi • Wyandotte • Muskegon Lansing • Gaylord • Sault Ste. Marie Williamsport, PA • Tampa, FL www.sidockgroup.com
	DOG ISO.	7 RECESSE 8 SKYLIGHT	D 'CAN' LIGHT FIXTURE.	
	CAT HOLD / CAT RECOVERY $\langle 9'-0" \rangle$ 136 ENTRY FOYER $\langle 9'-0" \rangle$ 135 HALLWAY $\langle 9'-0" \rangle$ 137 DOG RECOVERY $\langle 9'-0" \rangle$ 141	REFER TO	CTED CEILING PLAN LEGEND ELECTRICAL & MECHANICAL DRAWINGS FOR L INFORMATION	TAYLOR MADE FOR YOU
			CEILING GRID	^{Client:} City of Taylor 23555 Goddard Rd.
	DELIVERY / PICK		2'x4' LIGHT FIXTURE	Taylor, MI 48180
	$\frac{\text{UP / STORAGE}}{\left(\text{EXP}\right) 138}$		2'x2' HVAC SUPPLY DIFFUSER	
	EUTH. ROOM		2'x2' HVAC RETURN DIFFUSER	
] DOG HOLD]	0	RECESSED 'CAN' LIGHT	
			PENDANT MOUNTED LIGHT FIXTURE	Project: City of Taylor Animal Shelter
			DRYWALL CEILING	Remodel & Expansion
		EX	INDICATES CEILING / SOFFIT HEIGHT (EX = TO MATCH EXISTING HEIGHTS)	

25555 Northline Rd. Taylor, MI 48180

Date




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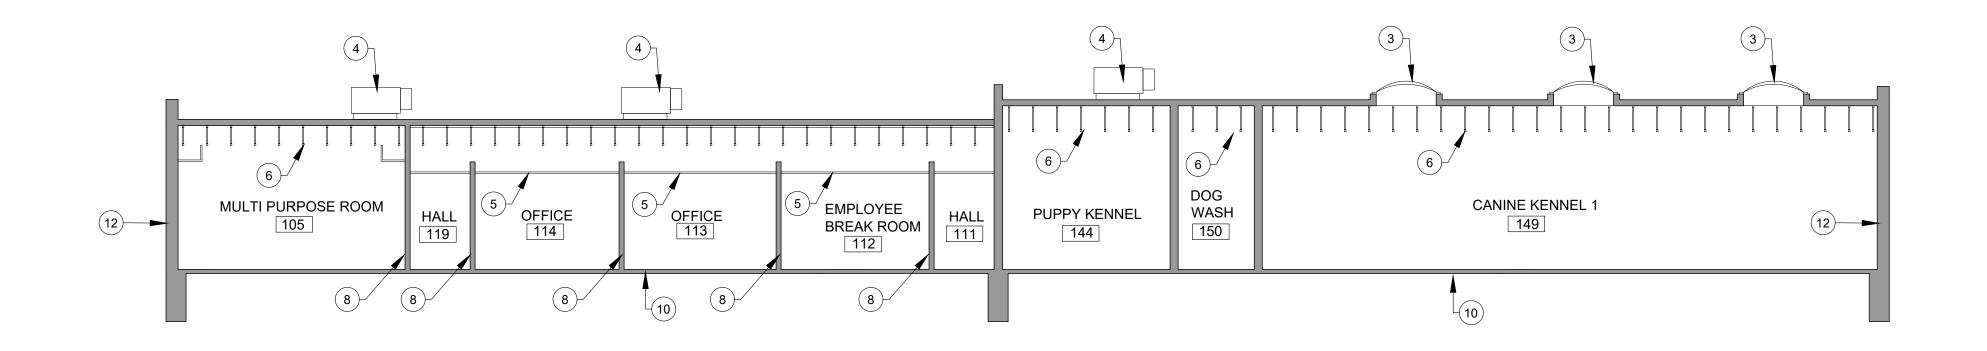
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Approved:	MR

Sheet Title: REFLECTED **CEILING PLAN**

22712.A Project Number: Sheet Number: A-510





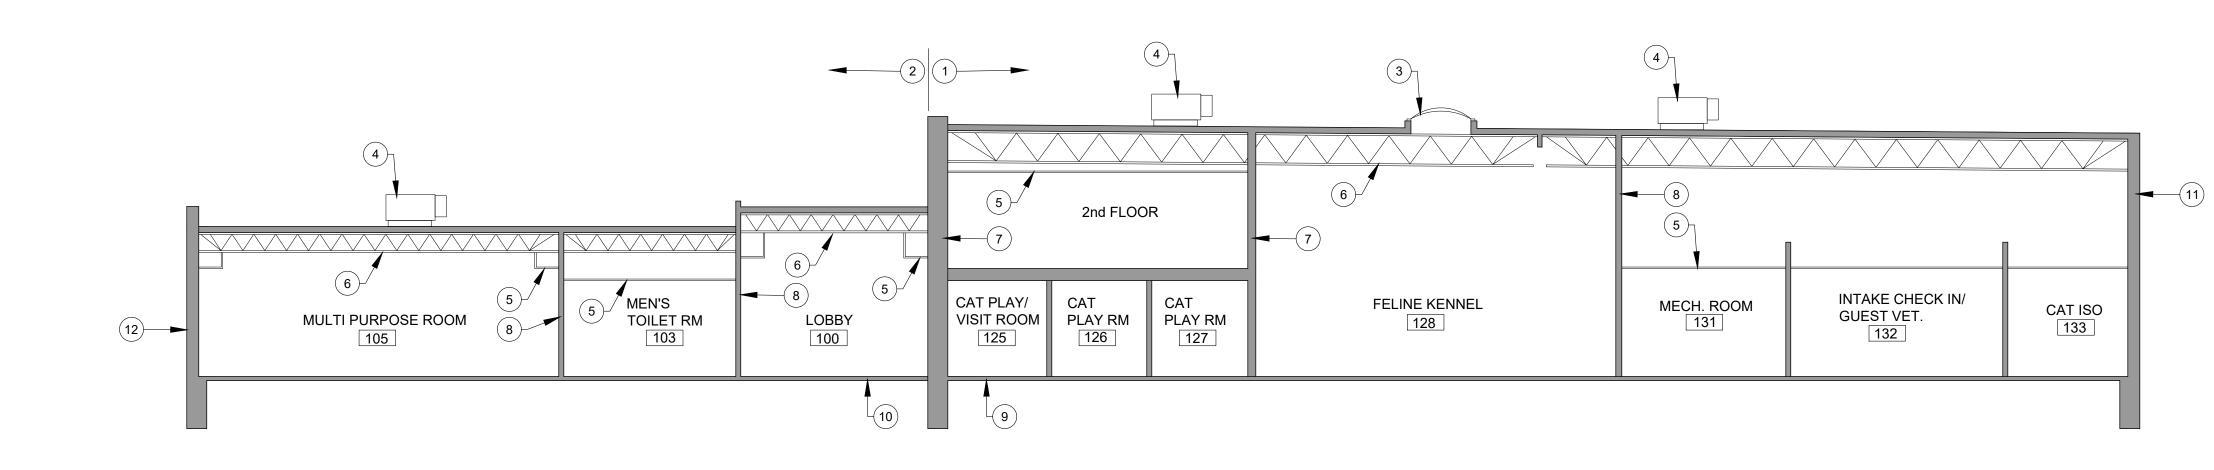






BUILDING SECTION SCALE: 1/8" = 1'-0"



BUILDING SECTION NOTES:

- (1) EXISTING BUILDING
- (2) NEW BUILDING ADDITION
- (3) SKYLIGHT
- (4) HVAC EQUIPMENT (RTU)
- (5) FINISH CEILING
- (6) EXPOSED CEILING
- (7) EXISTING MASONRY WALL
- (8) NEW INTERIOR WALL
- (9) EXISTING FLOOR SLAB
- (10) NEW FLOOR SLAB
- (11) EXISTING EXTERIOR WALL
- (12) NEW EXTERIOR WALL

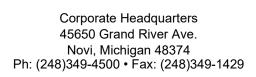


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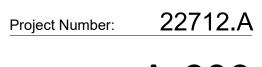
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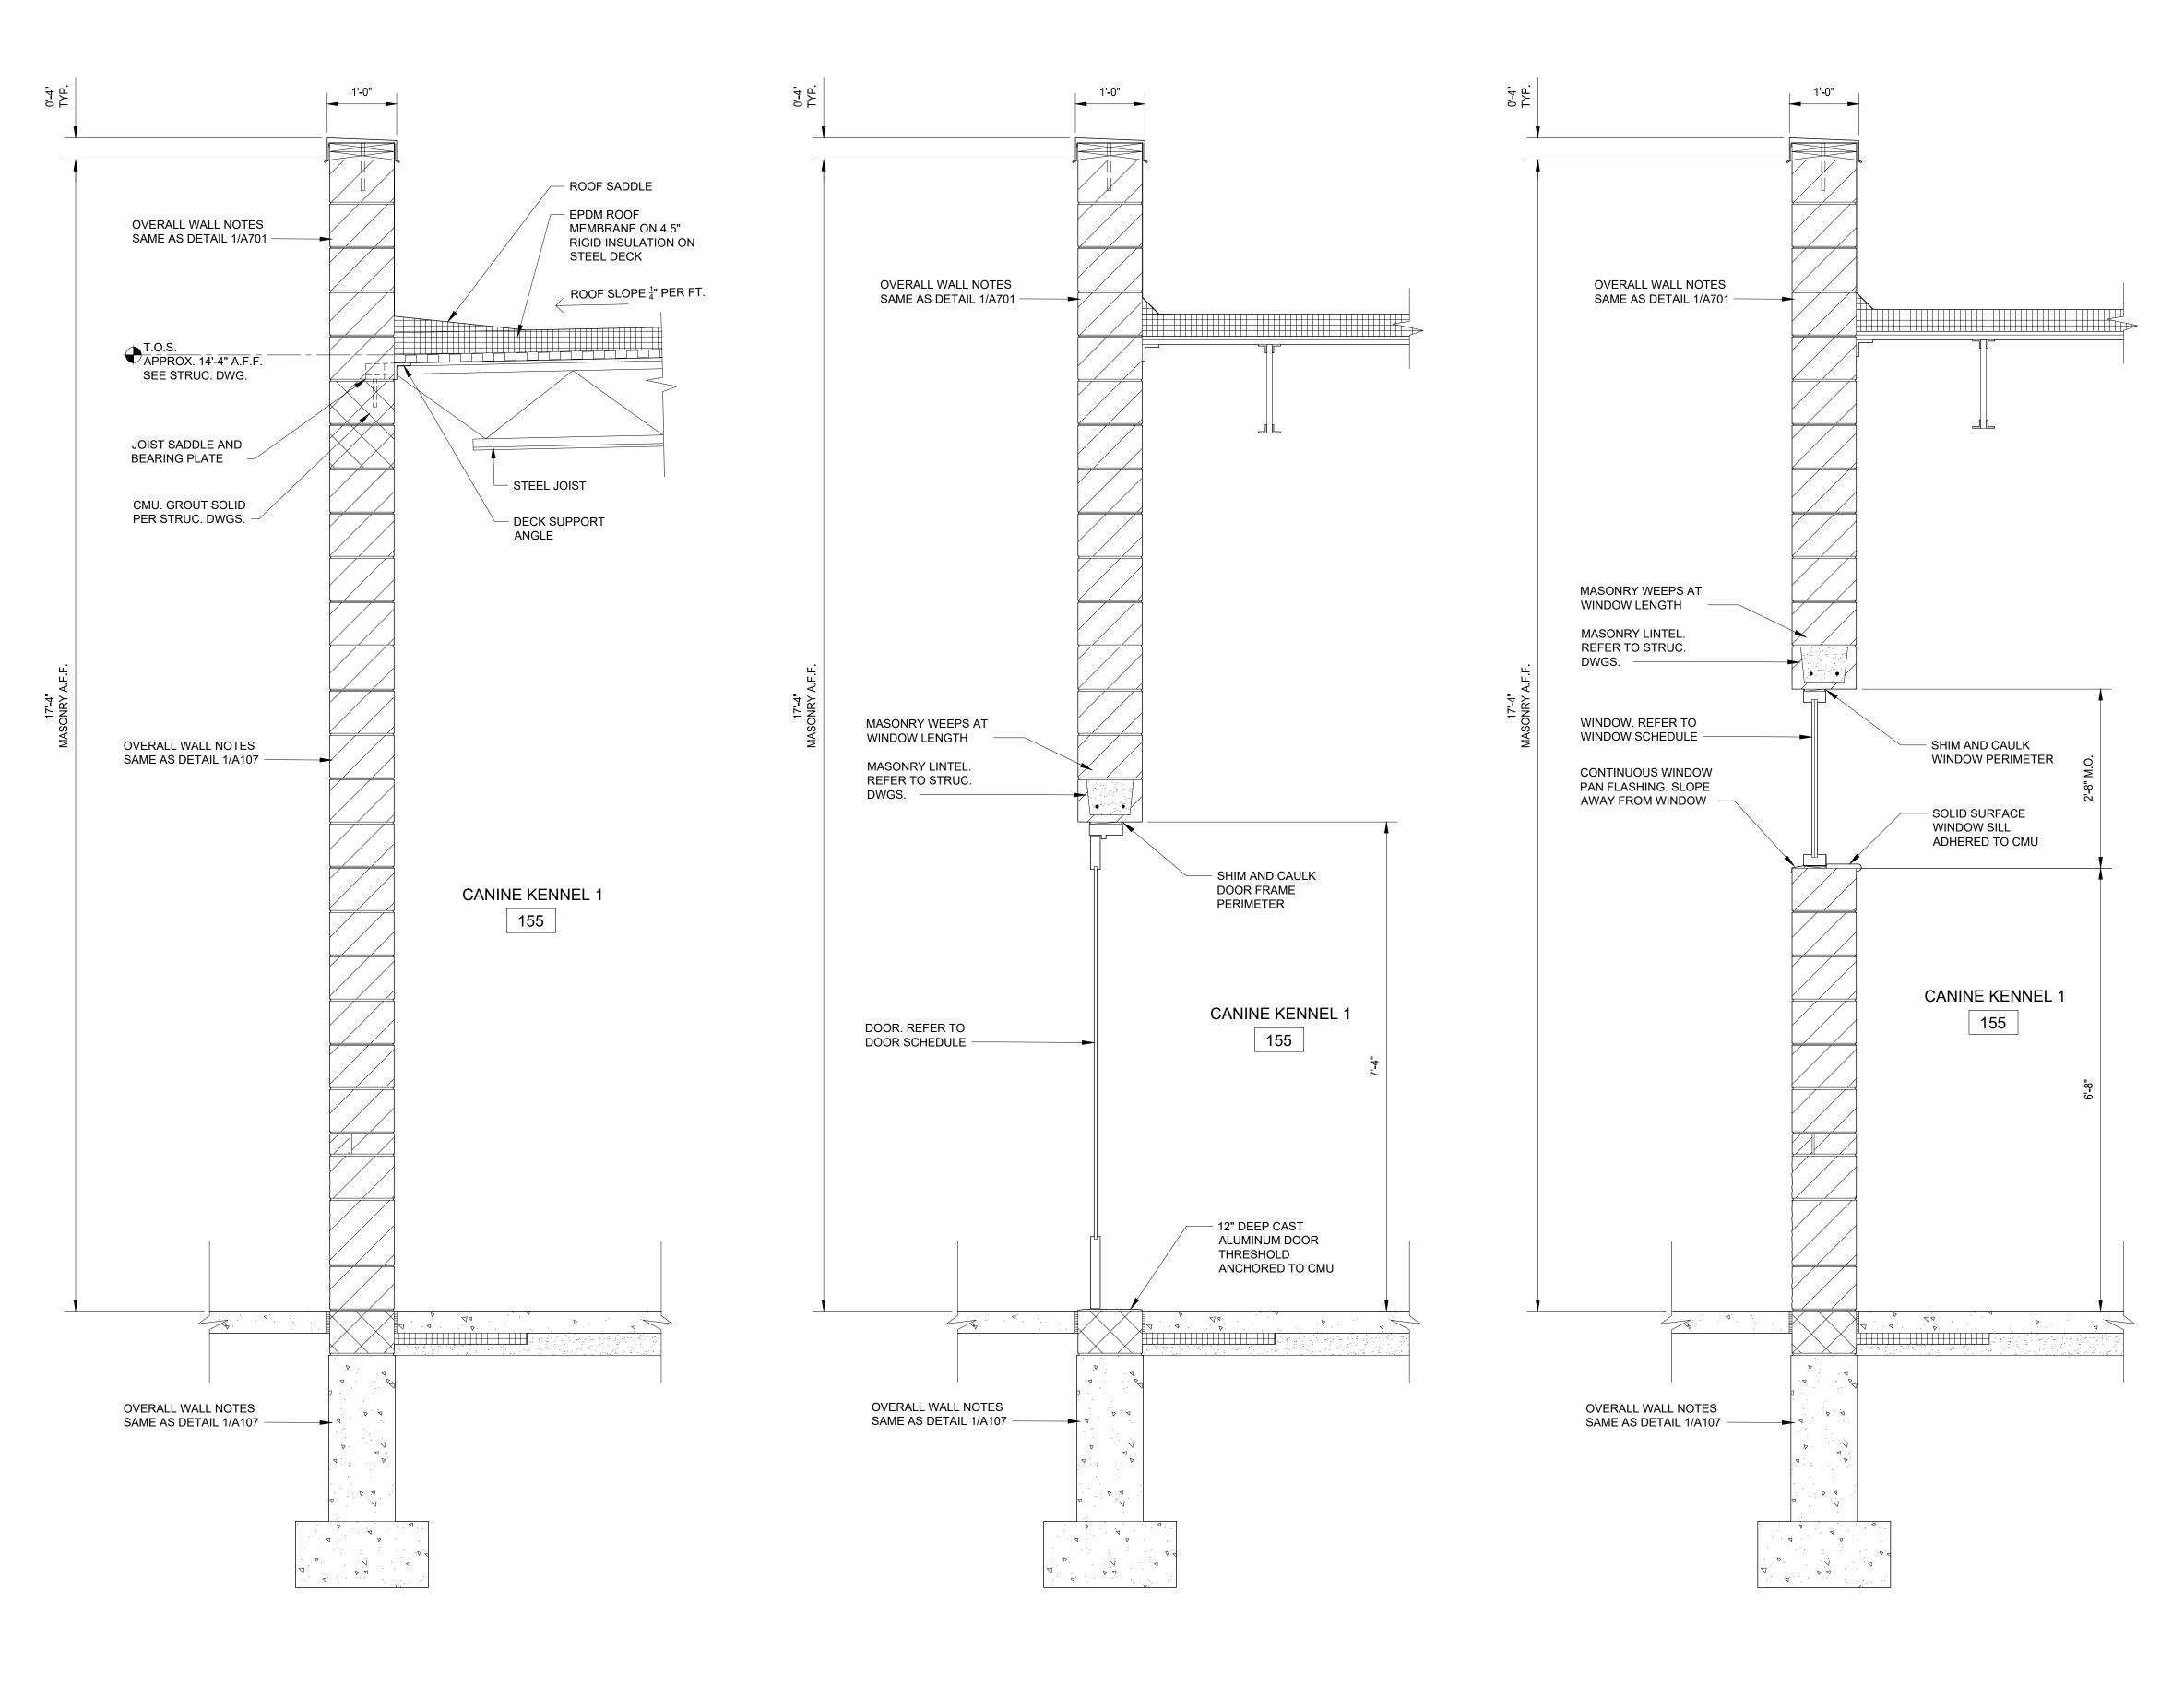
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Sheet Title: BUILDING SECTIONS



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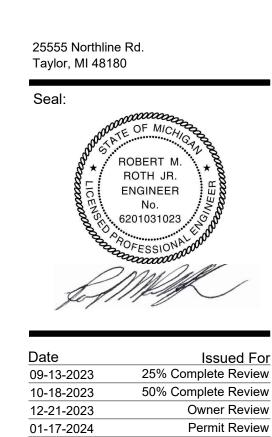
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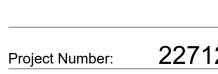
23555 Goddard Rd. Taylor, MI 48180

Remodel & Expansion

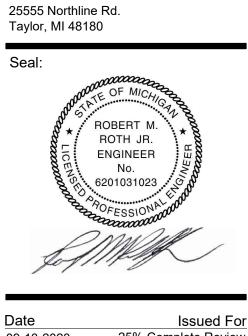


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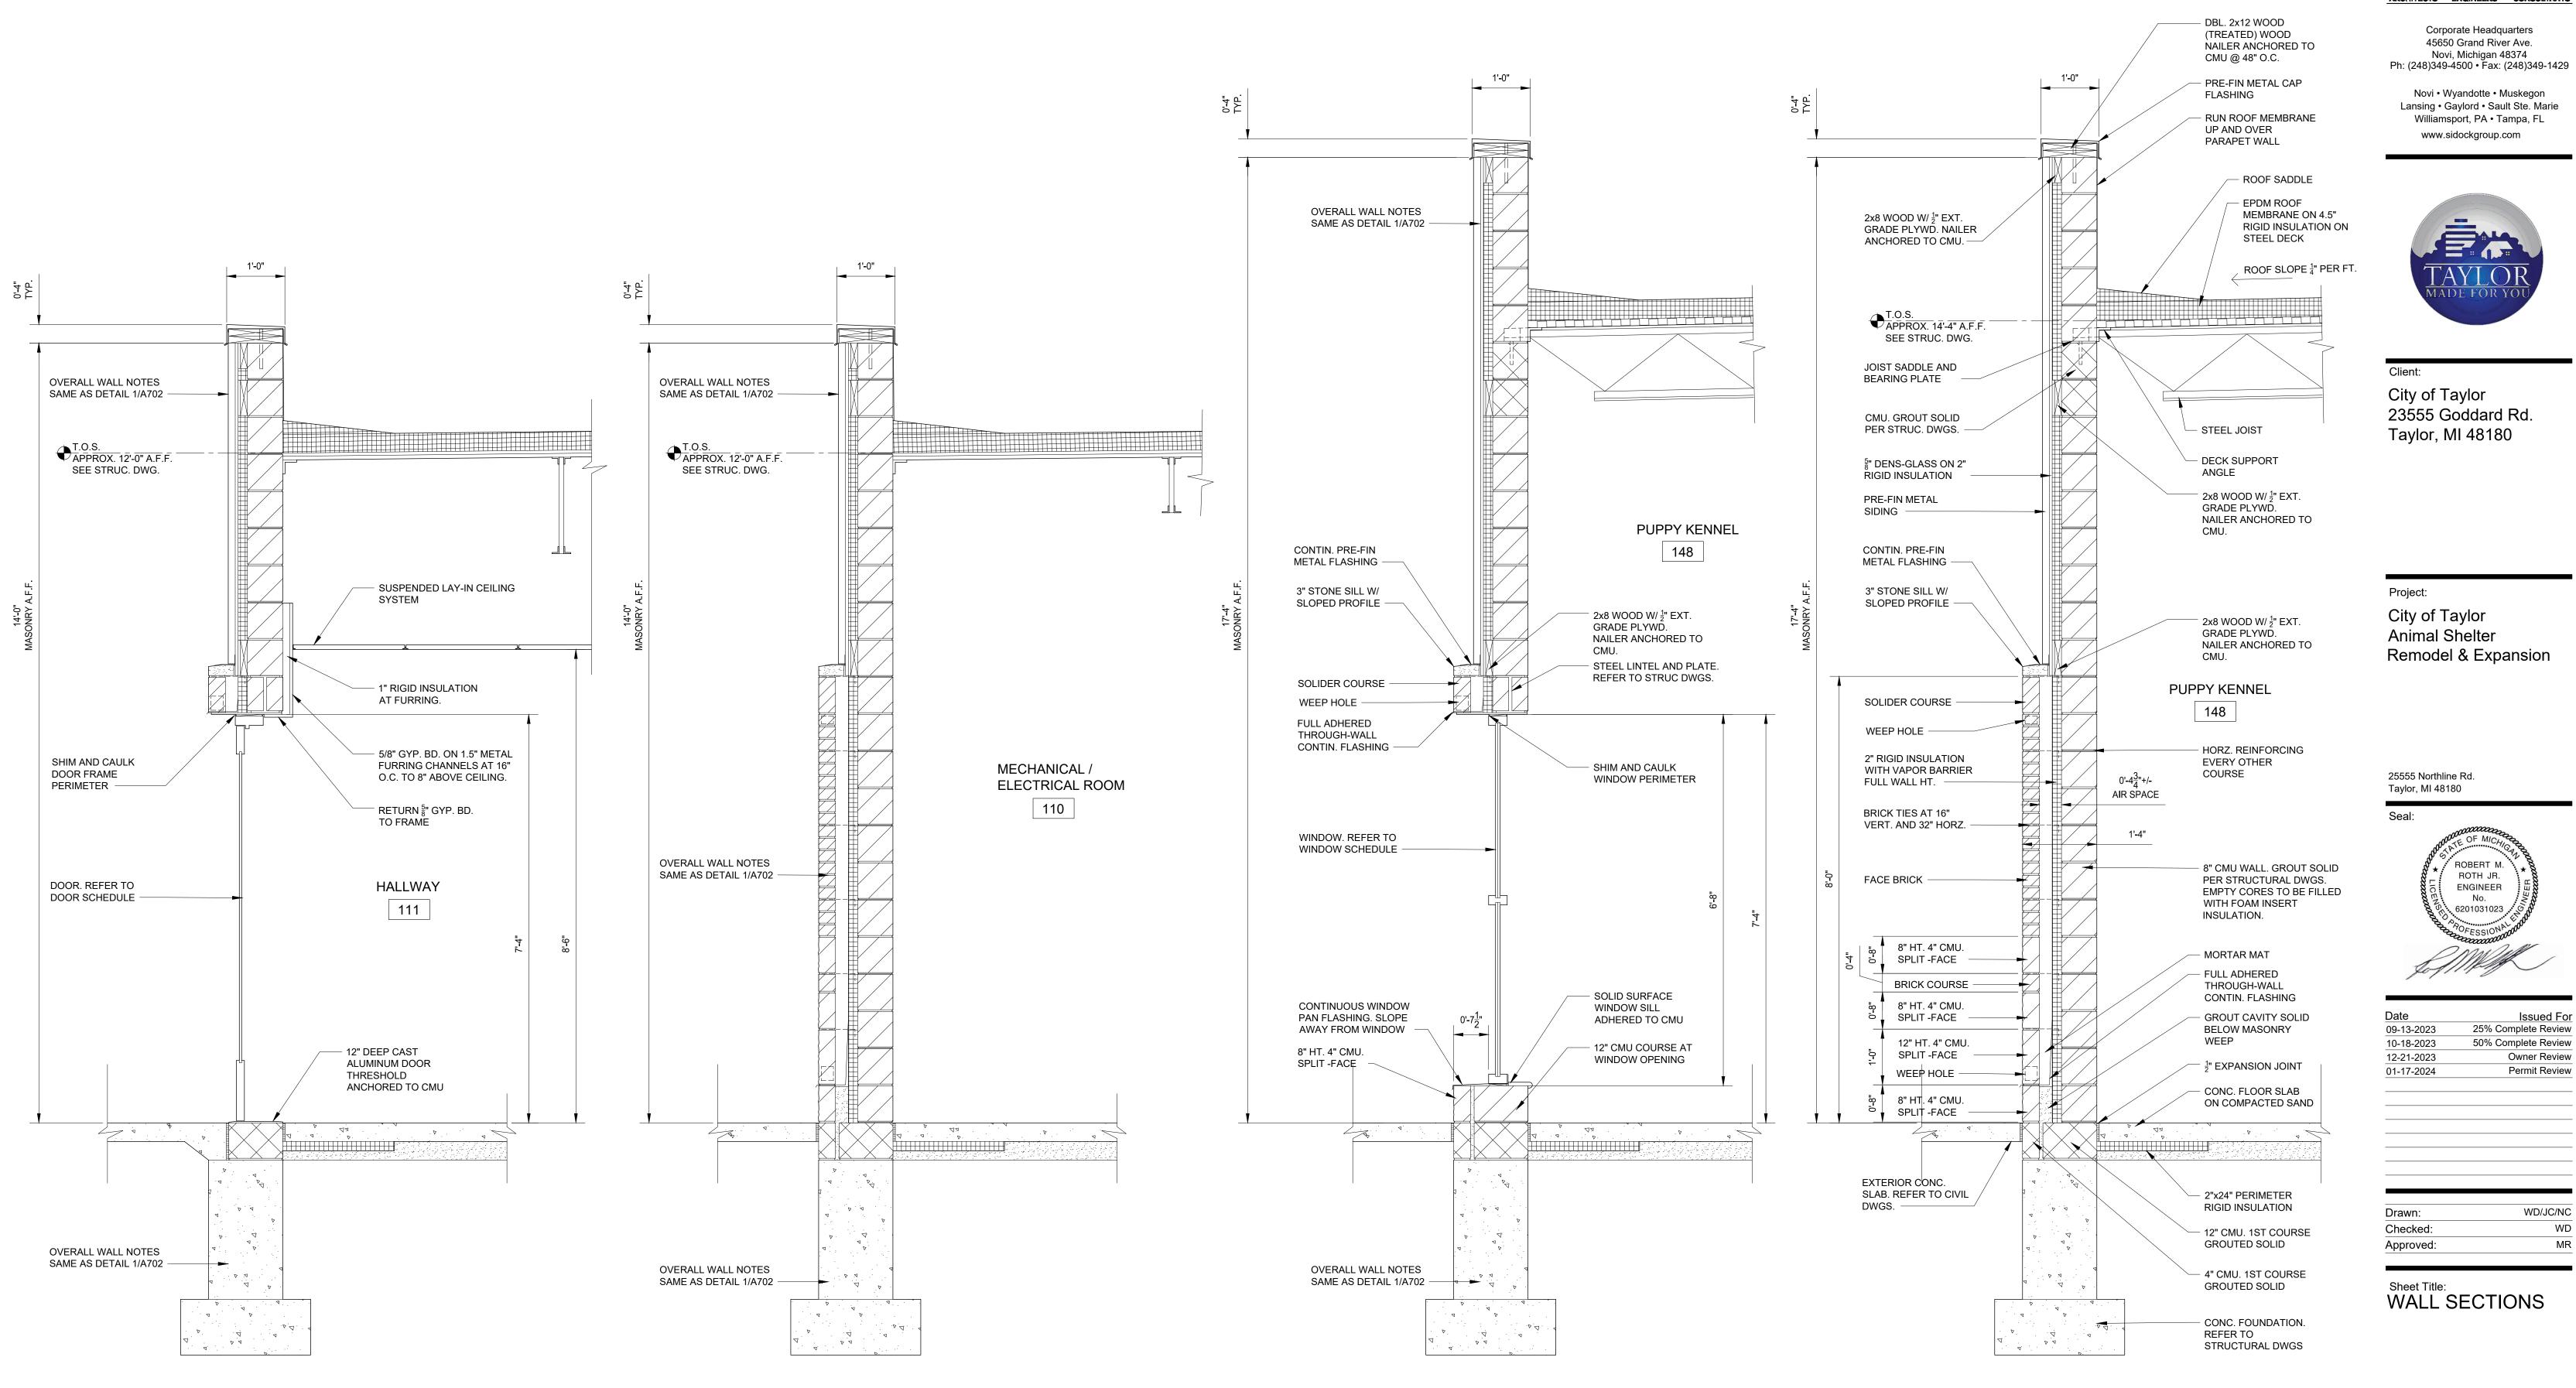
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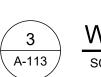




WALL SECTION SCALE: 3/4" = 1'-0"





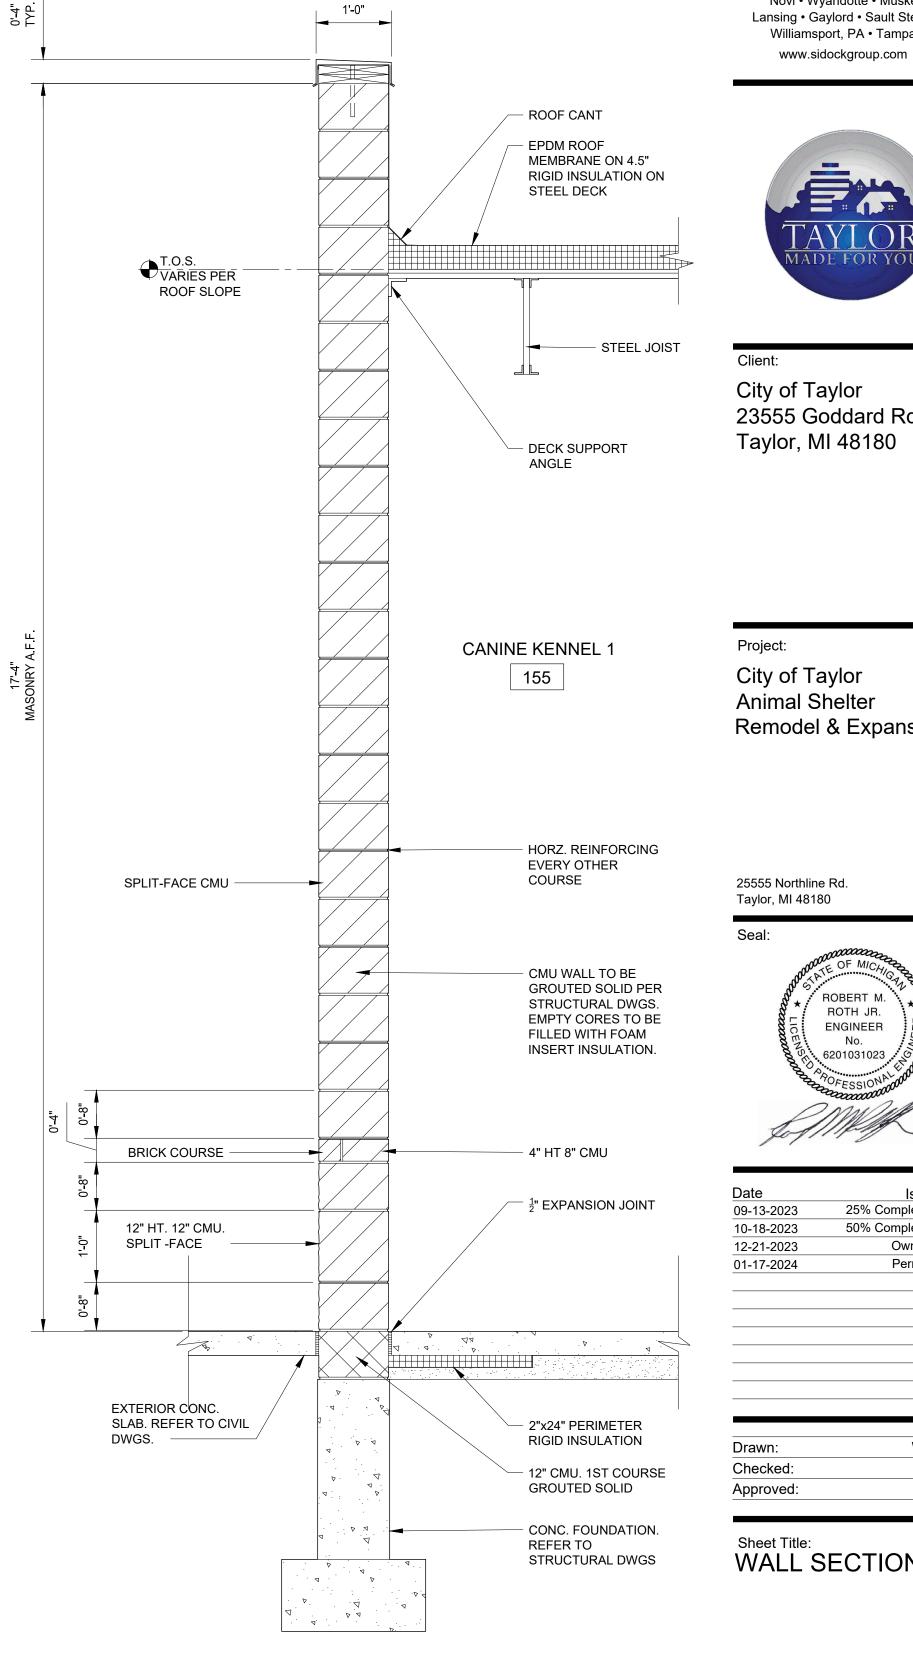



WALL SECTION

SCALE: 3/4" = 1'-0"



22712.A

A-702

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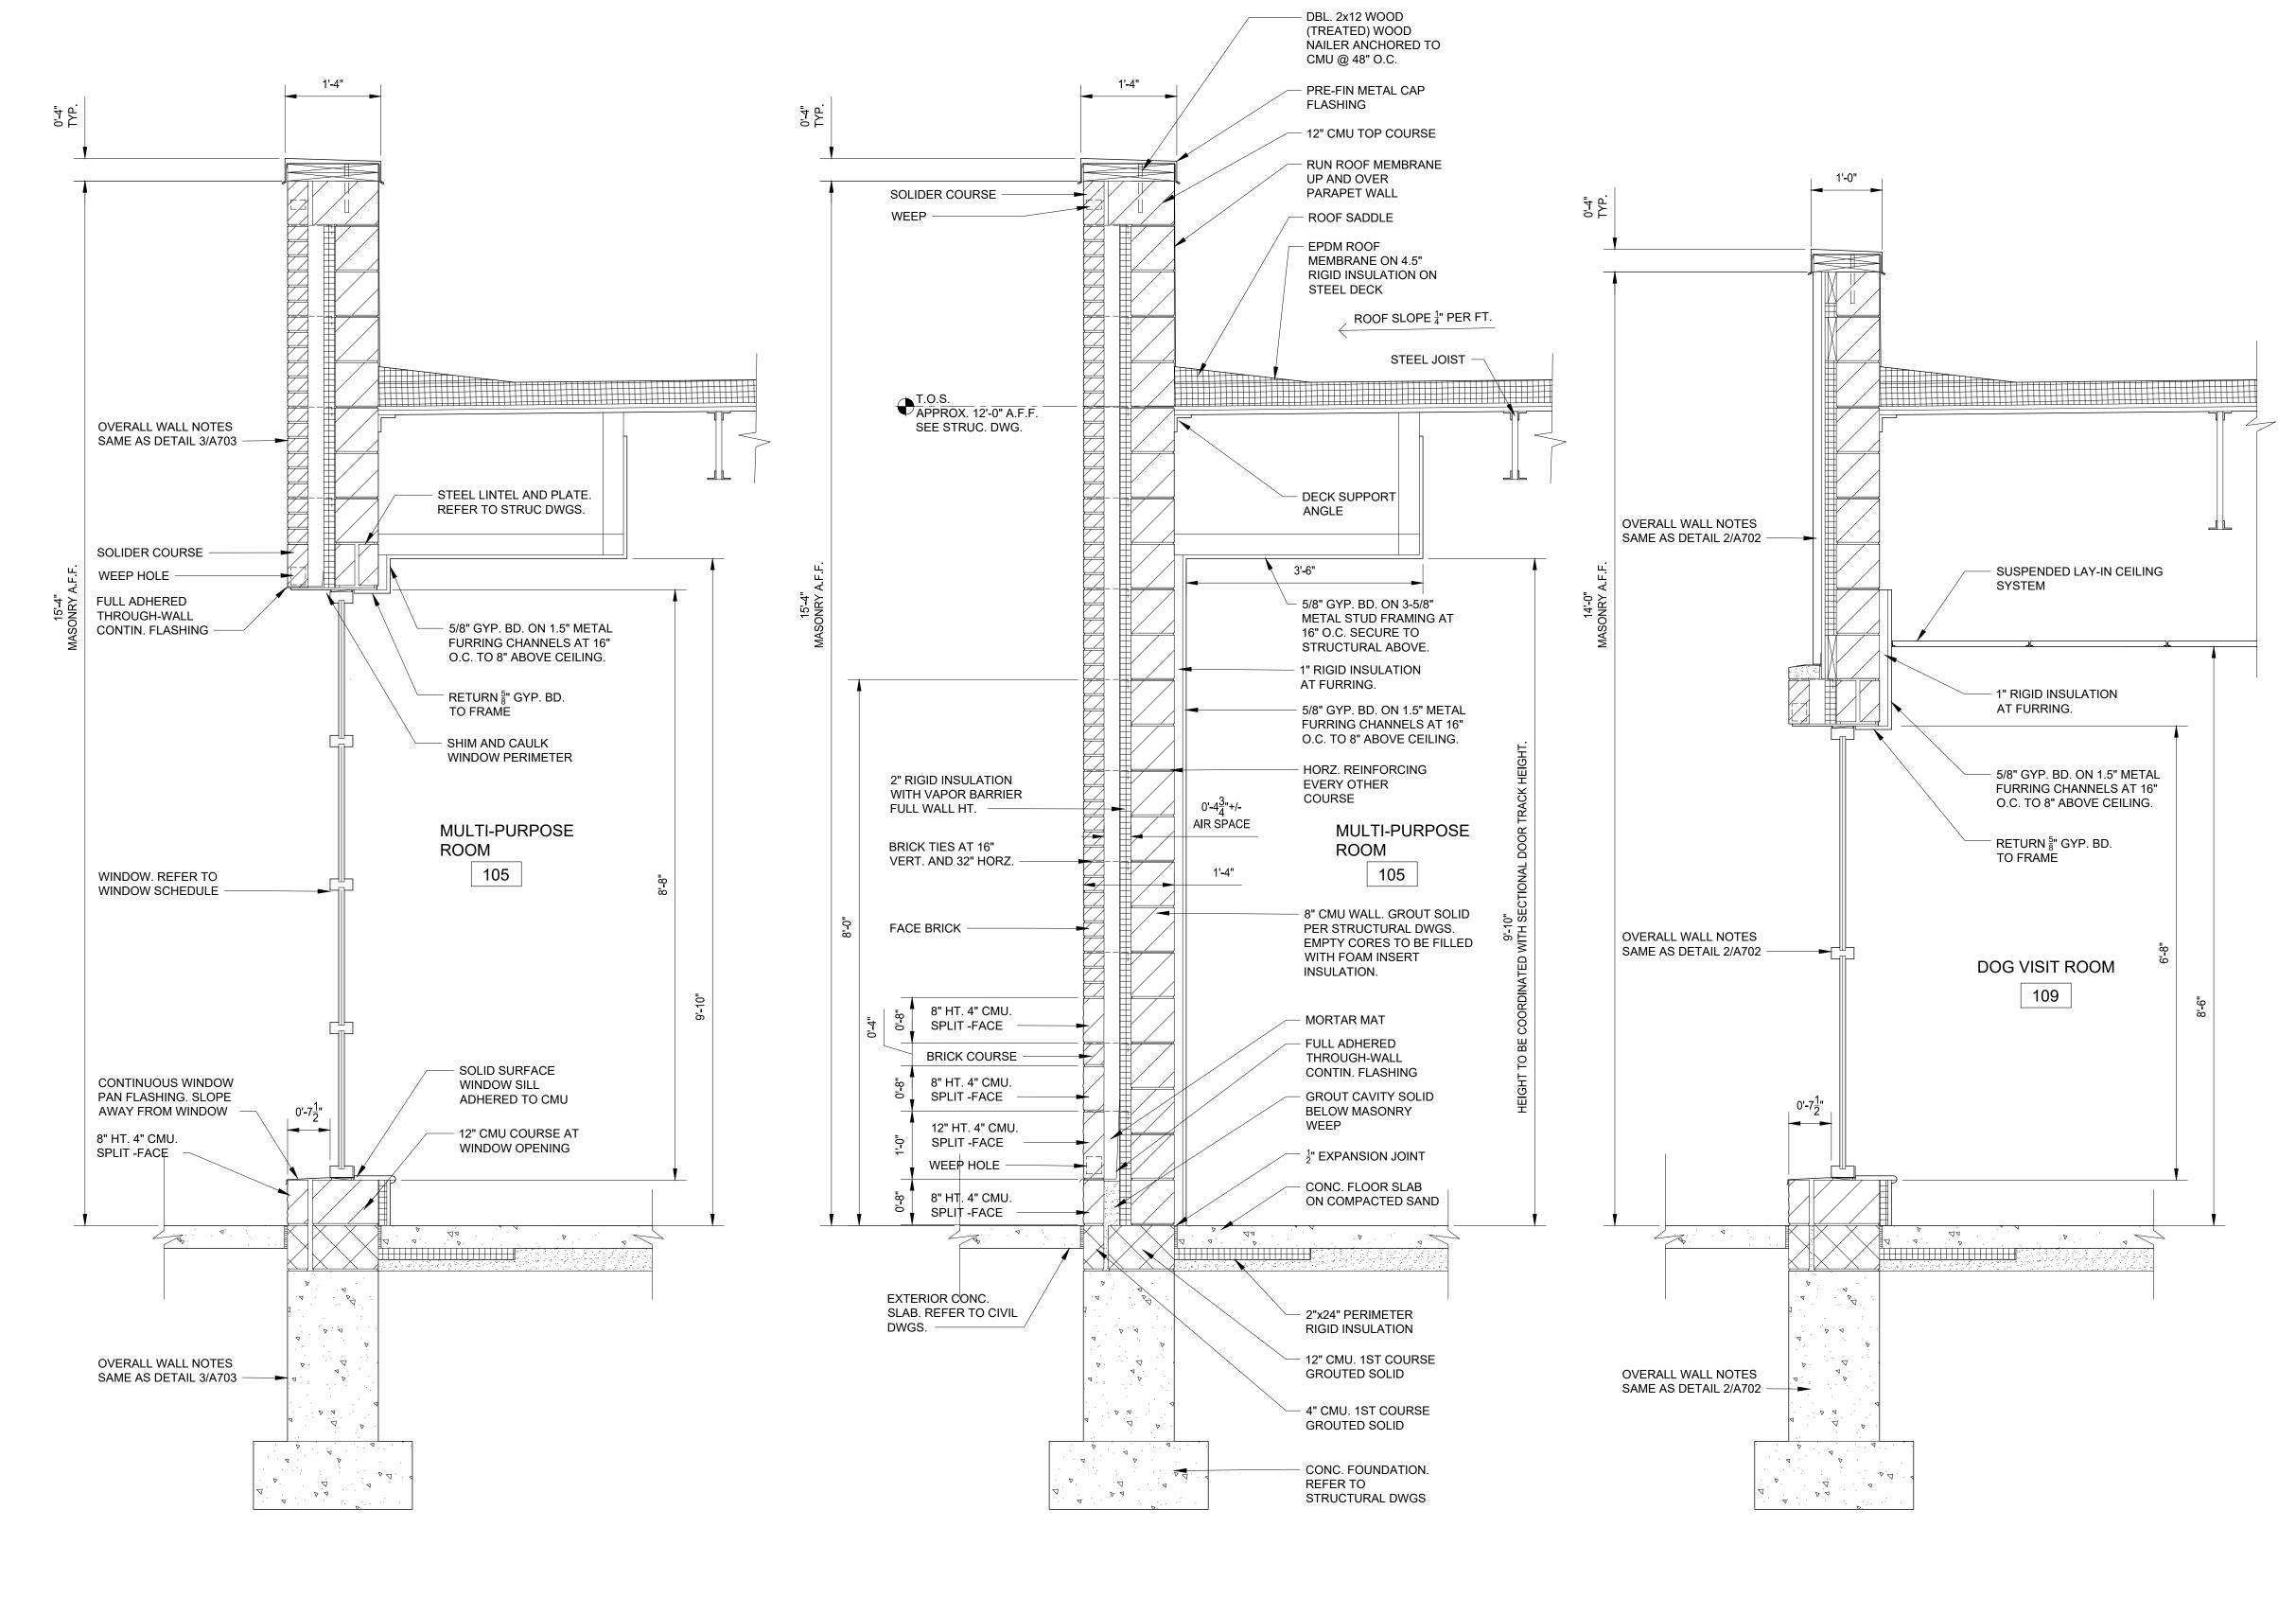
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Sheet Number:



WALL SECTION

SCALE: 3/4" = 1'-0"







WALL SECTION




WALL SECTION

SCALE: 3/4" = 1'-0"



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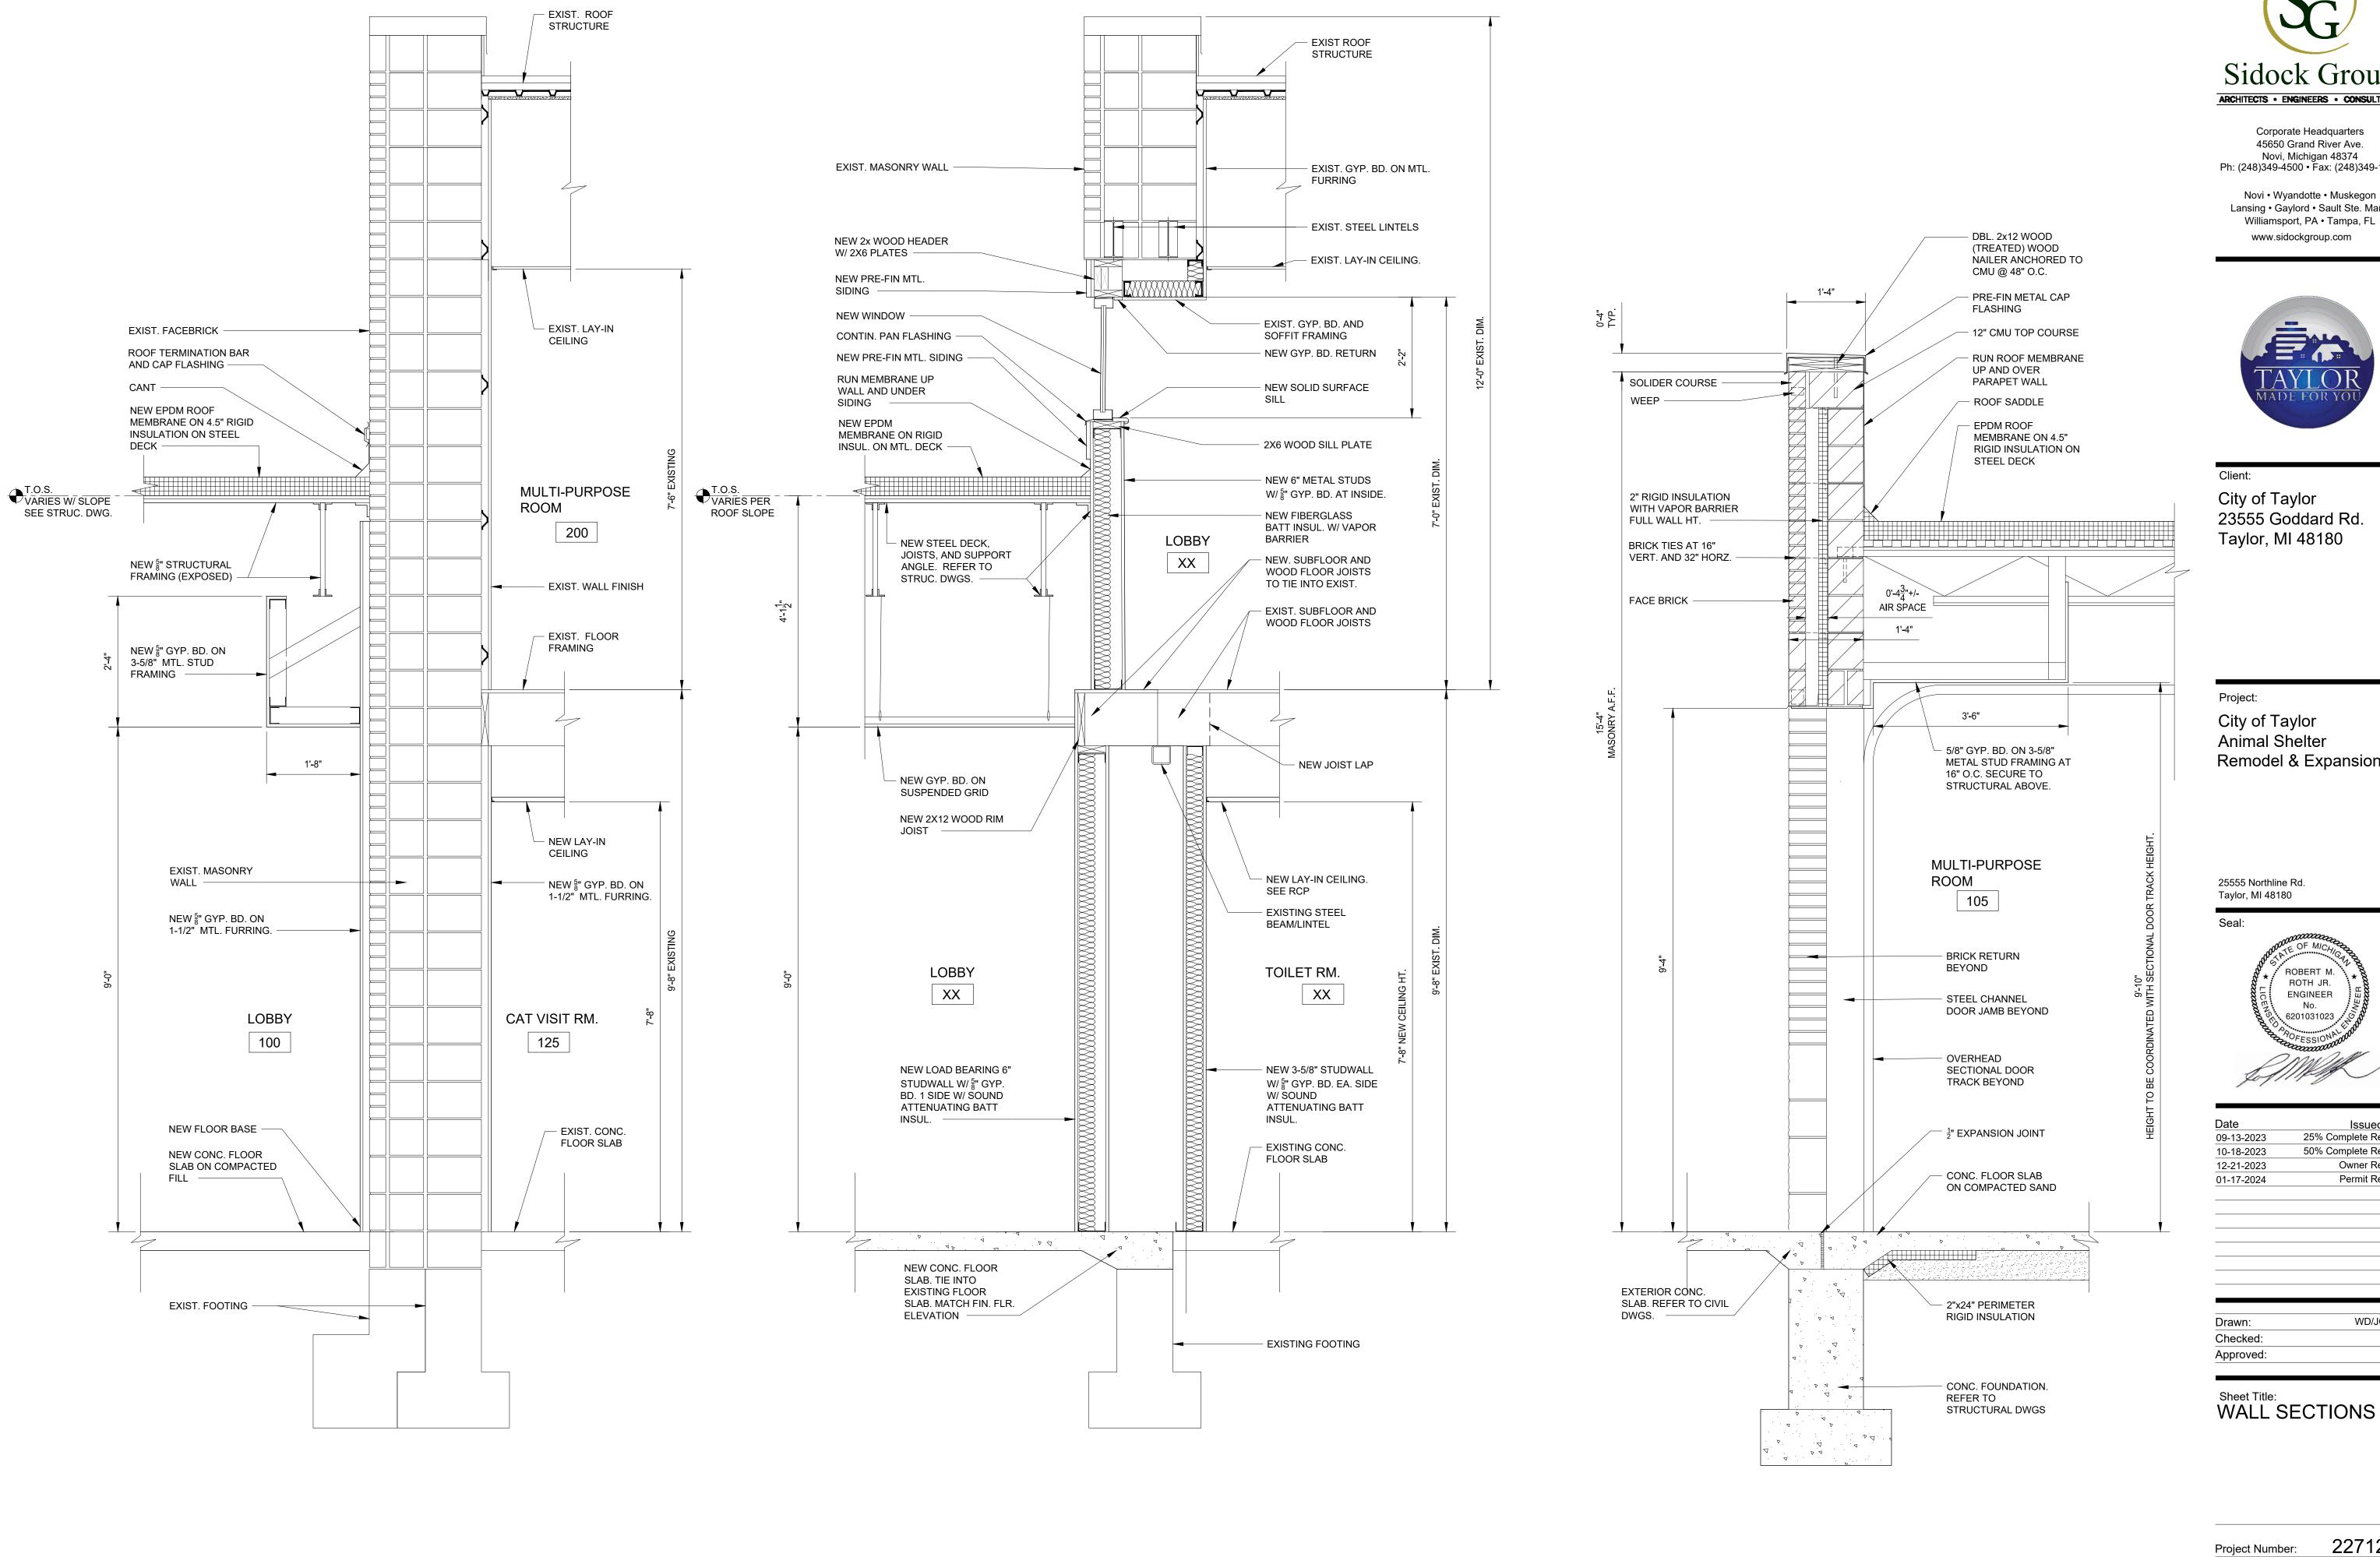


WALL SECTION SCALE: 3/4" = 1'-0"
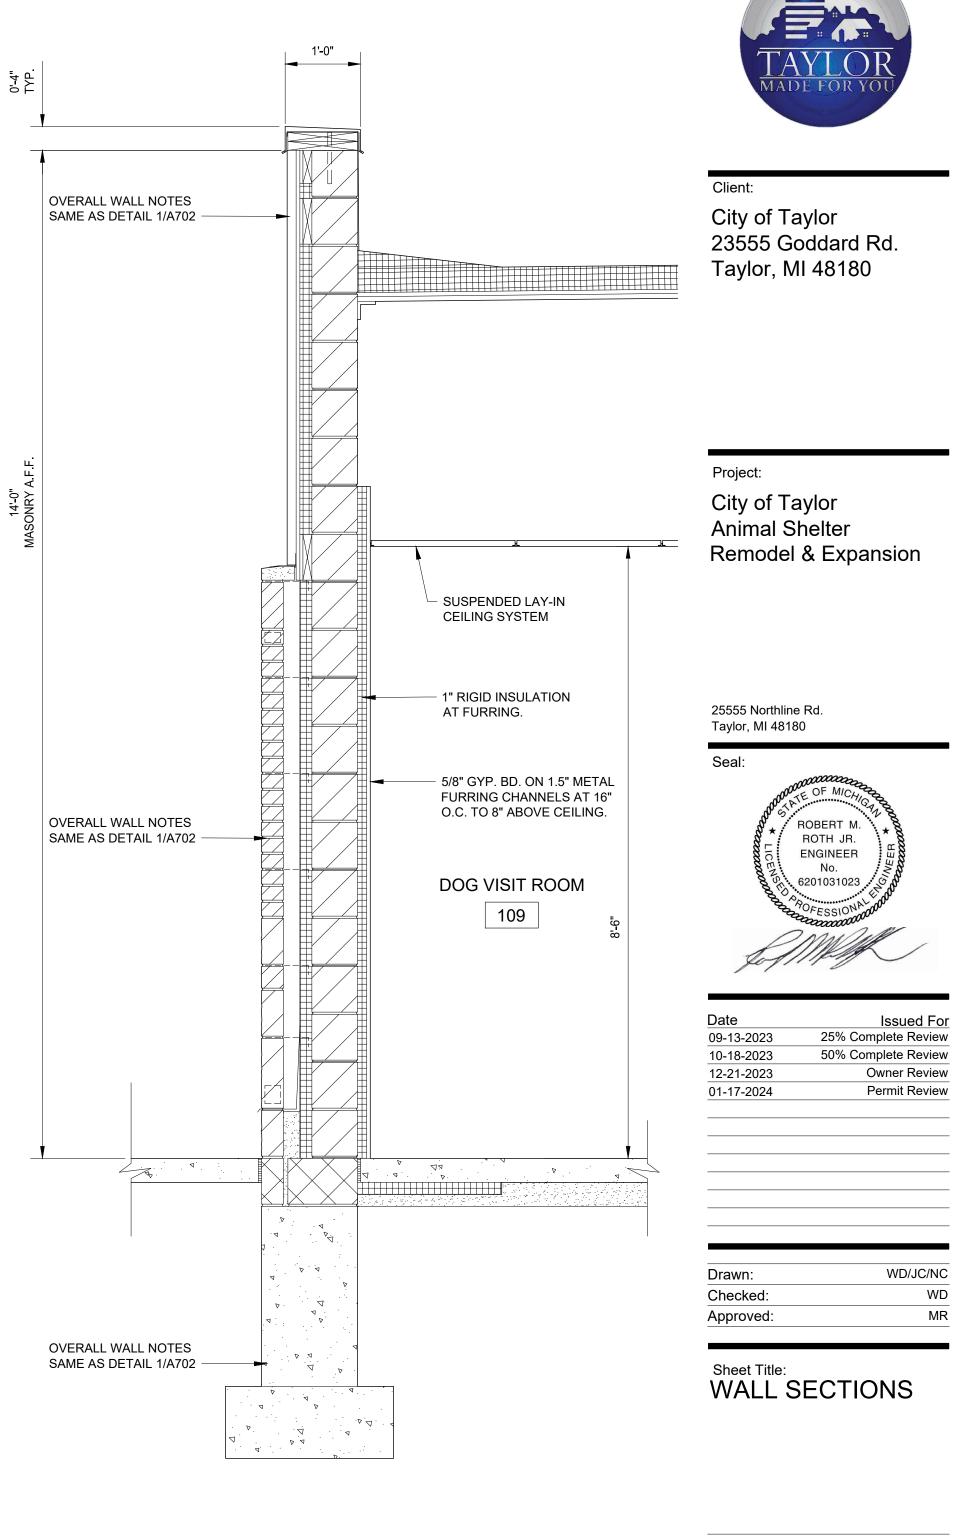
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Project Number:

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WALL SECTION

SCALE: 3/4" = 1'-0"






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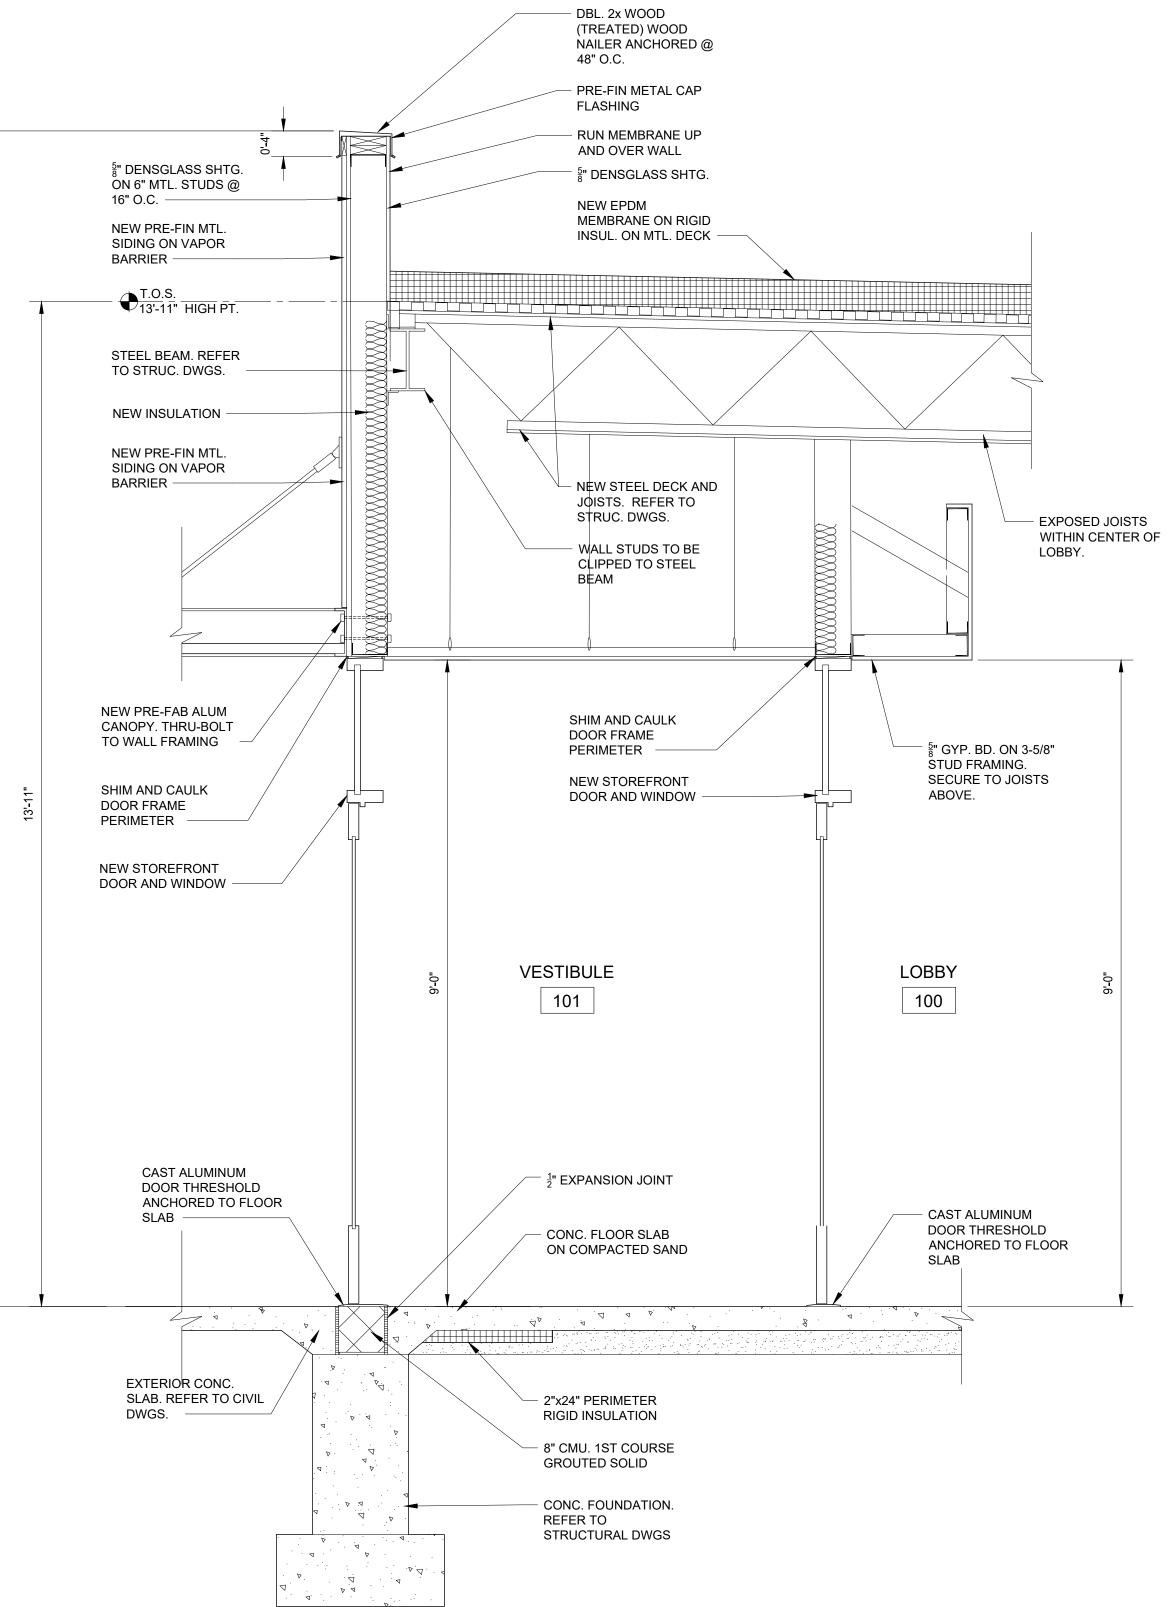
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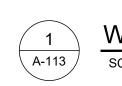
A-704

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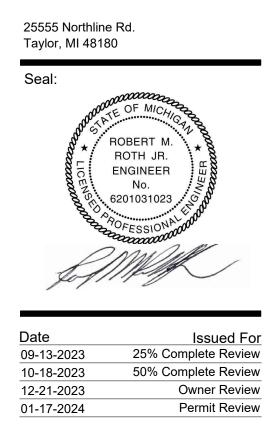


Client: City of Taylor 23555 Goddard Rd.

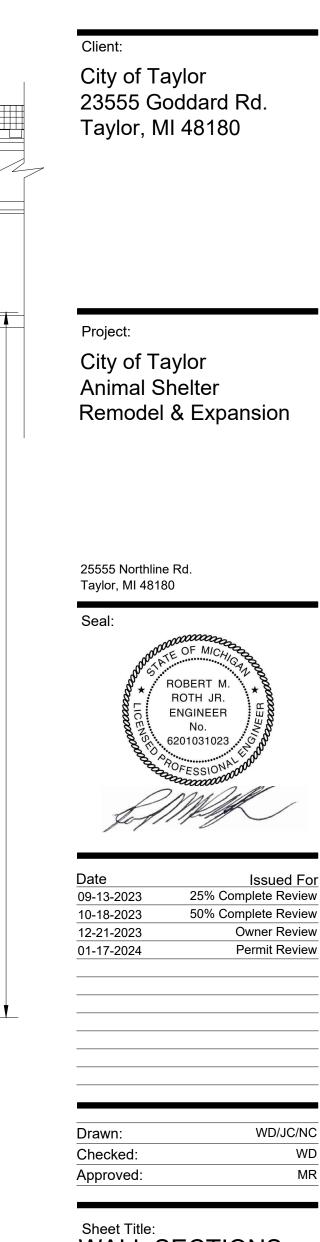Taylor, MI 48180

Project:

City of Taylor Animal Shelter Remodel & Expansion




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Checked:	WD
Approved:	MR






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WALL SECTION SCALE: 3/4" = 1'-0"



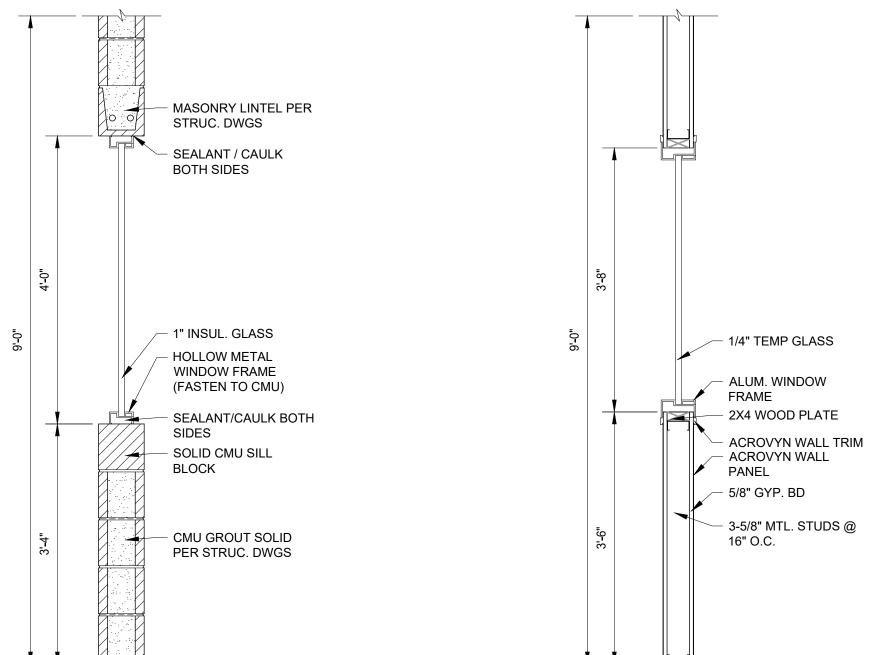

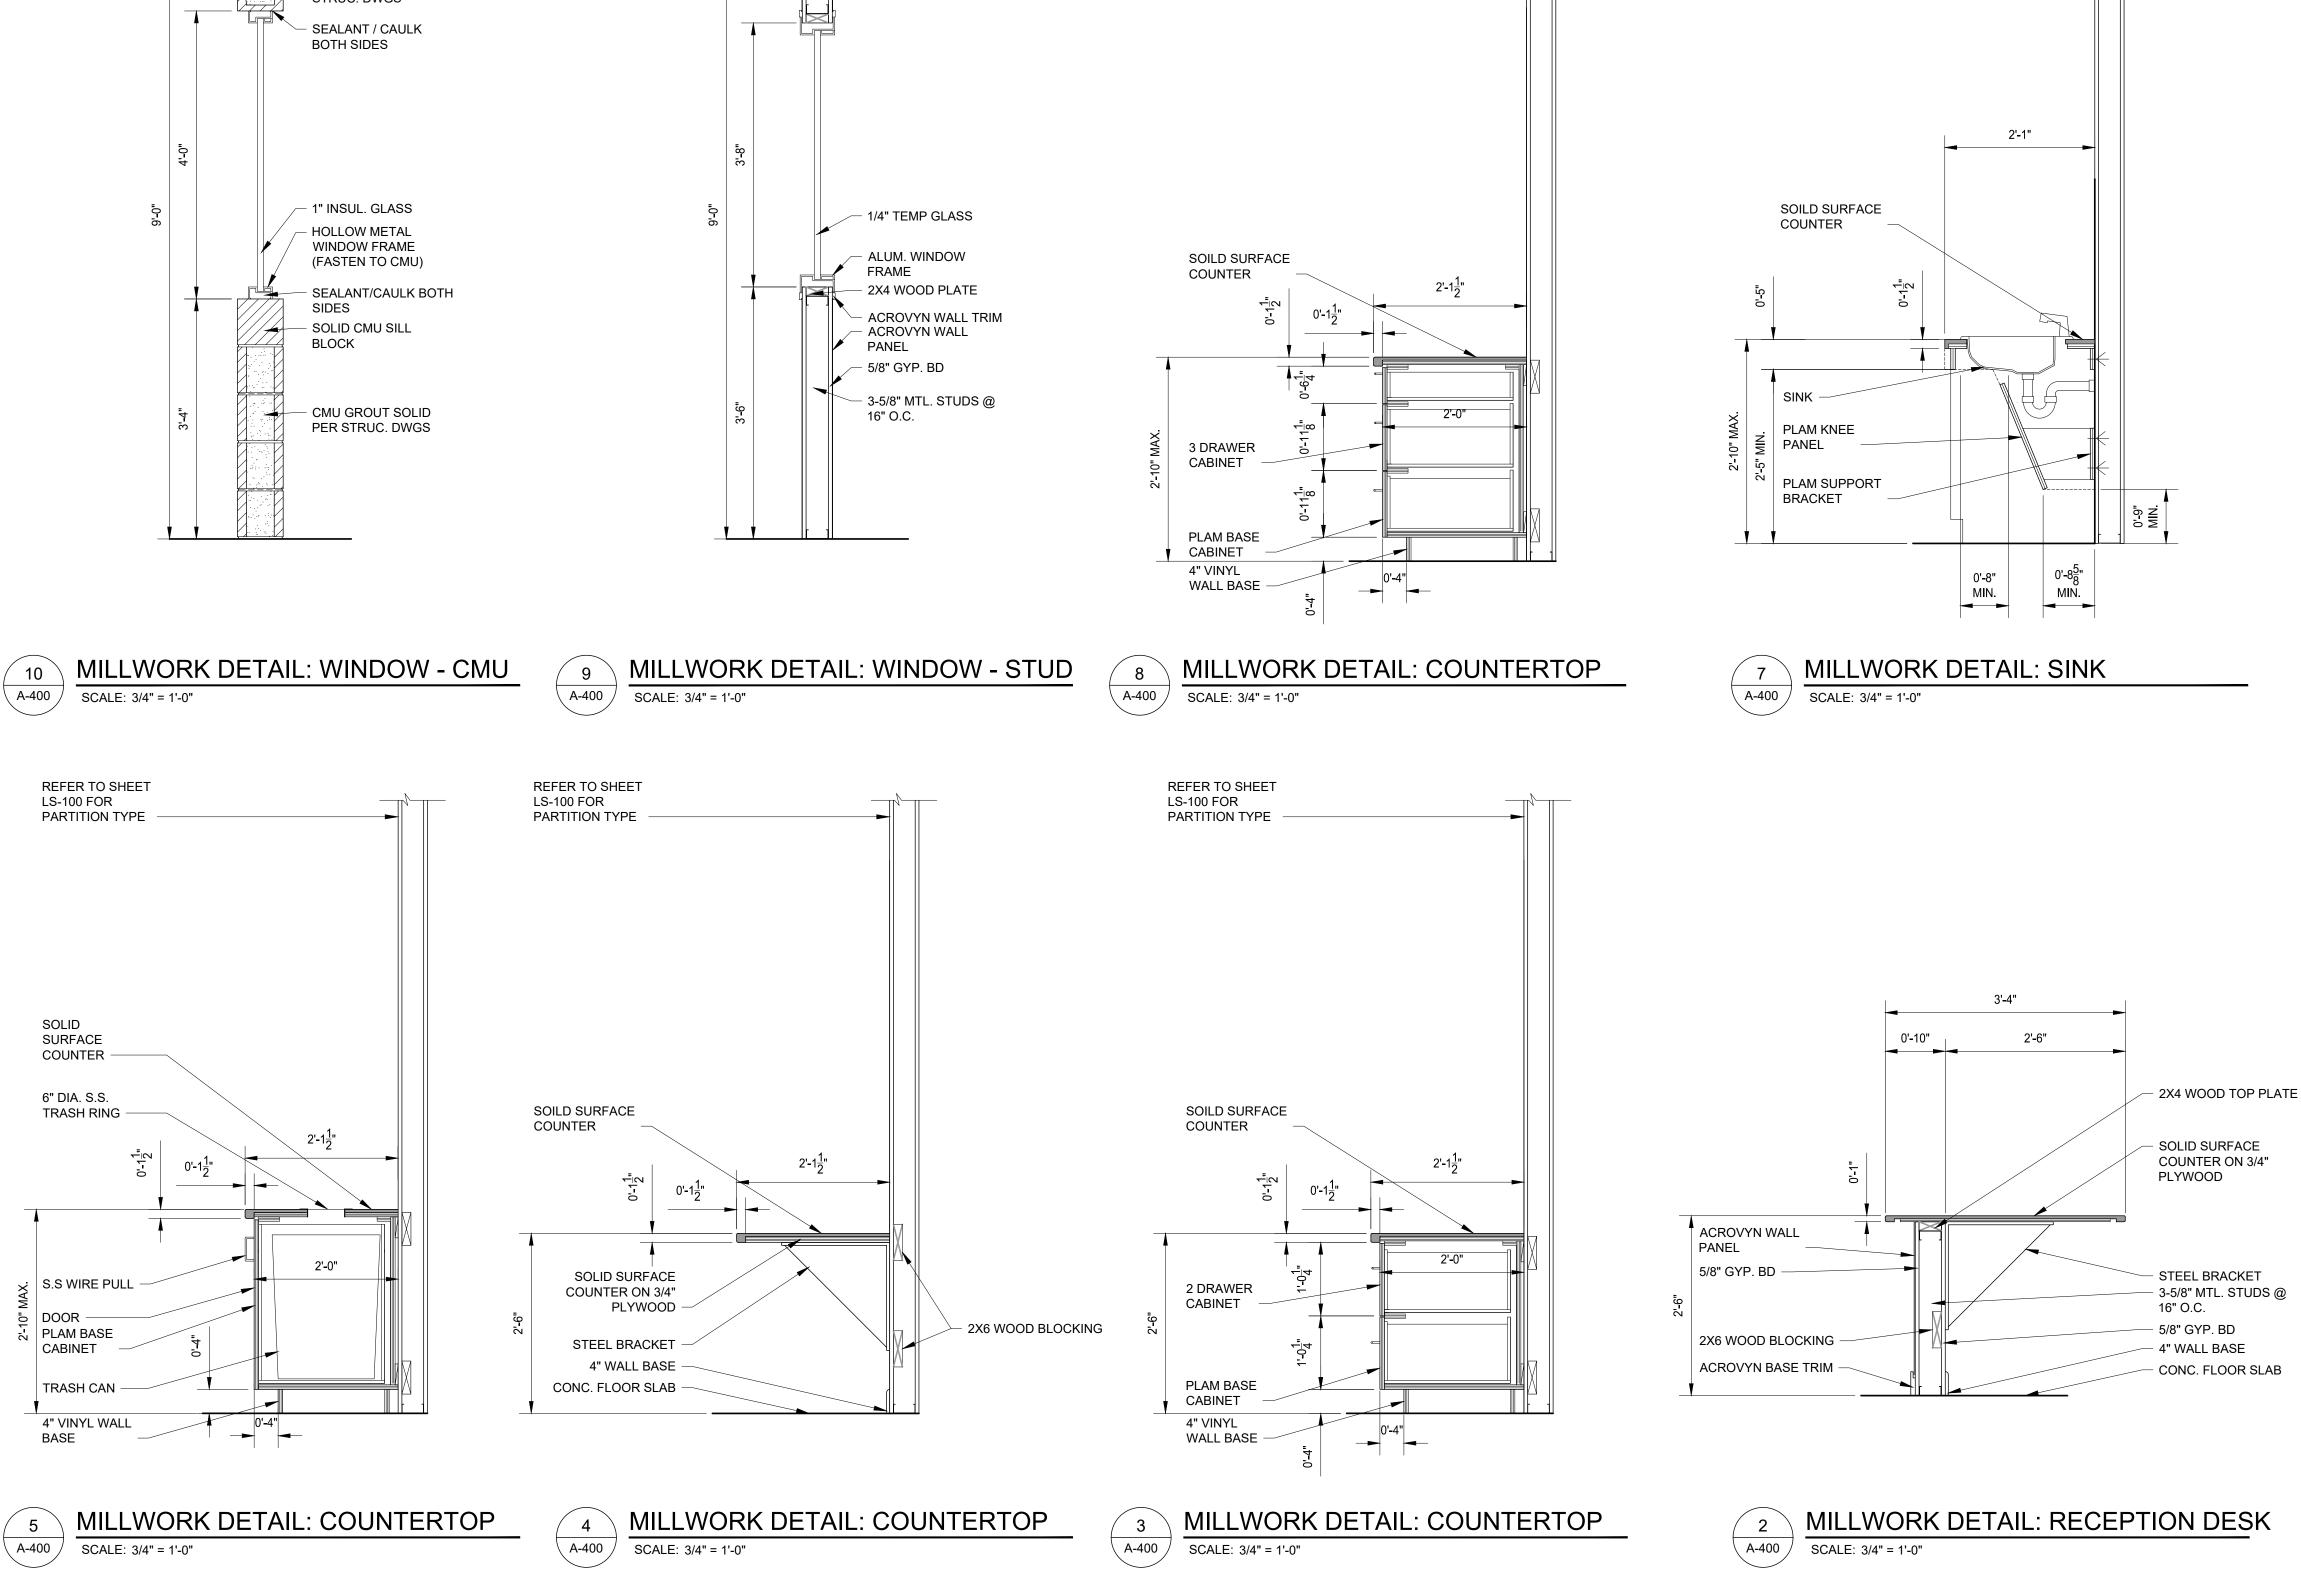REFER TO SHEET

LS-100 FOR PARTITION TYPE REFER TO SHEET

PARTITION TYPE

LS-100 FOR



Corporate Headquarters 45650 Grand River Ave. Novi, Michigan 48374 Ph: (248)349-4500 • Fax: (248)349-1429

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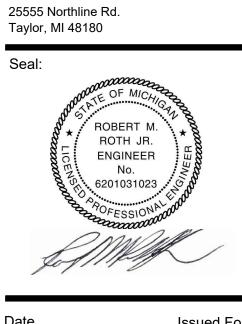
Key Plan:



Client: City of Taylor 23555 Goddard Rd. Taylor, MI 48180

Project:


City of Taylor Animal Shelter Remodel & Expansion



Date	Issued For
09-13-2023	25% Complete Review
10-18-2023	50% Complete Review
12-21-2023	Owner Review
01-17-2024	Permit Review

Drawn:	WD/JC/NC
Checked:	WD
Approved:	MR



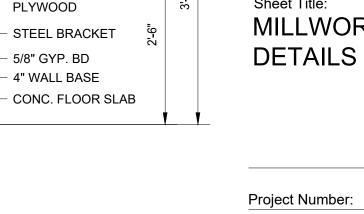

2X4 WOOD TOP PLATE

— 3-5/8" MTL. STUDS @ 告

SOLID SURFACE

COUNTER ON 3/4"

16" O.C.





REFER TO SHEET

PARTITION TYPE

LS-100 FOR

SOLID

SURFACE COUNTER

DRAWER

DOOR

PLAM BASE CABINET

WALL BASE -

SCALE: 3/4" = 1'-0"

2<u>1</u>+

0'-2"

5/8" GYP. BD -

PANEL

ACROVYN WALL

2X6 WOOD BLOCKING -

ACROVYN BASE TRIM -

4" VINYL

6

\ A-400 /

2<u>1</u>−

0'-1<u>1</u>"

0'-4"

MILLWORK DETAIL: COUNTERTOP

VARIES SEE PLAN

2'-6"

0'-2"

- PLAM COUNTERTOP ON 3/4" PLYWOOD


2'-1<u>7</u>"

2'-0"

A-800 Sheet Number:

22712.A

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1'-0"

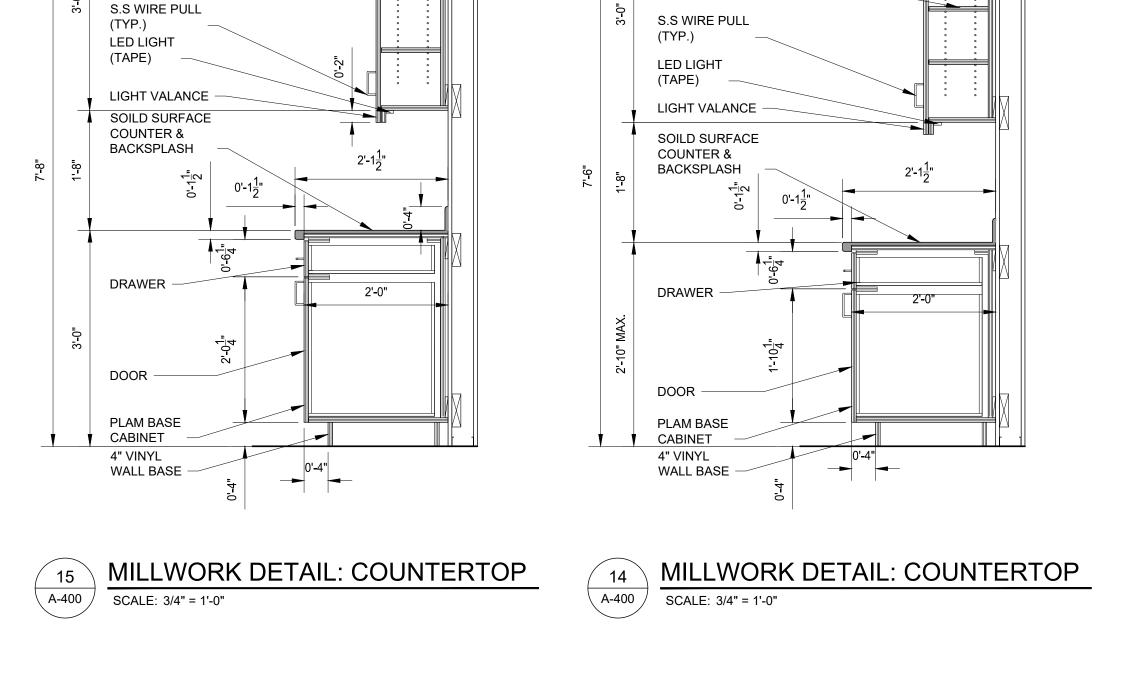REFER TO SHEET LS-100 FOR

PARTITION TYPE

1'-0"

PLAM FLAT

PLAM WALL

ADJUSTABLE

CABINET

SHELVES

CROWN

REFER TO SHEET LS-100 FOR

PARTITION TYPE

PLAM FLAT

CROWN

PLAM WALL


CABINET


SHELVES

ADJUSTABLE



13 MILLWORK DETAIL: COUNTERTOP SCALE: 3/4" = 1'-0"

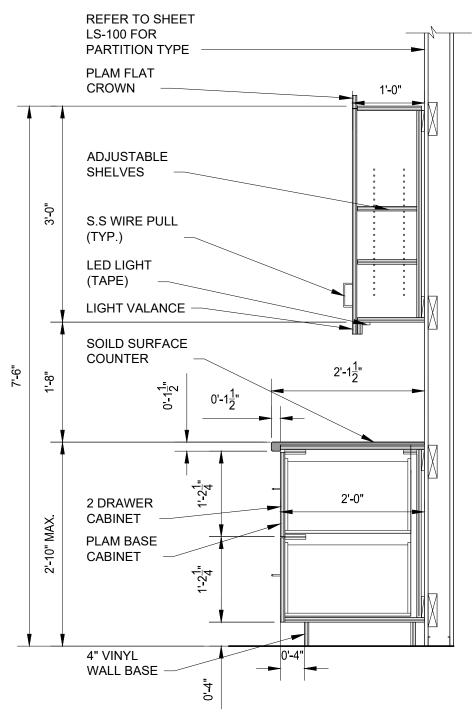

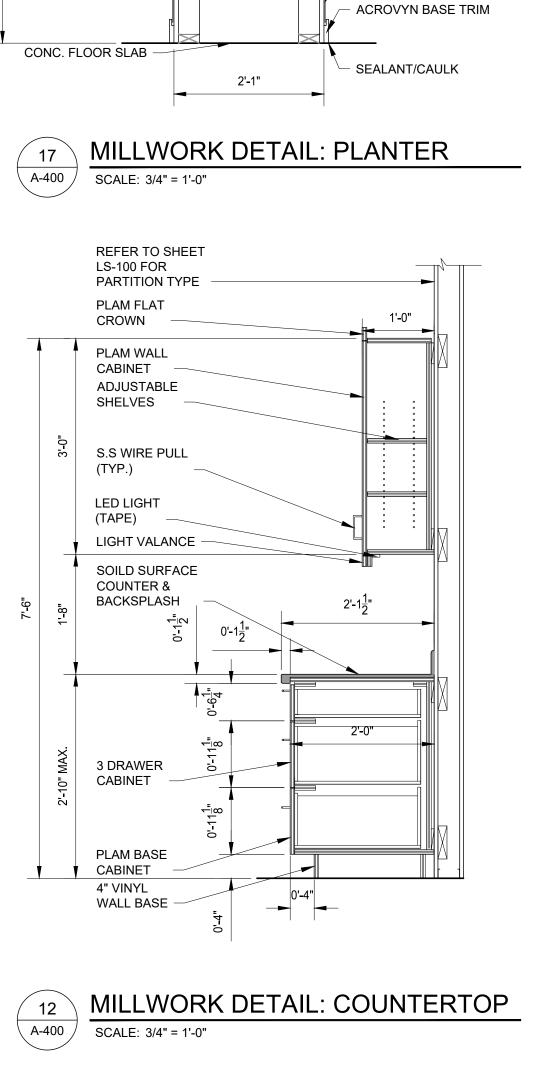

ACROVYN PANEL

SOLID SURFACE WALL

2X4 WOOD STUDS @

3/4" PLYWOOD SHTG

2X4 WOOD JOISTS @

ACROVYN PANEL

(BLACK)

CAP/SILL

16" O.C.

16" O.C.

0'-1<mark>1</mark>" TYP.

3/4" PLYWOOD SHTG



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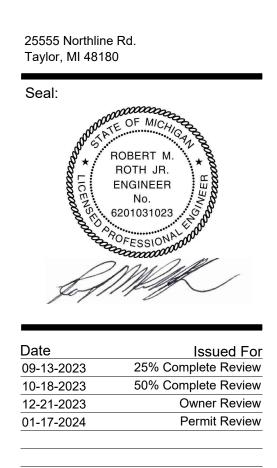
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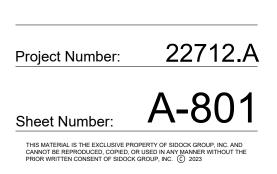
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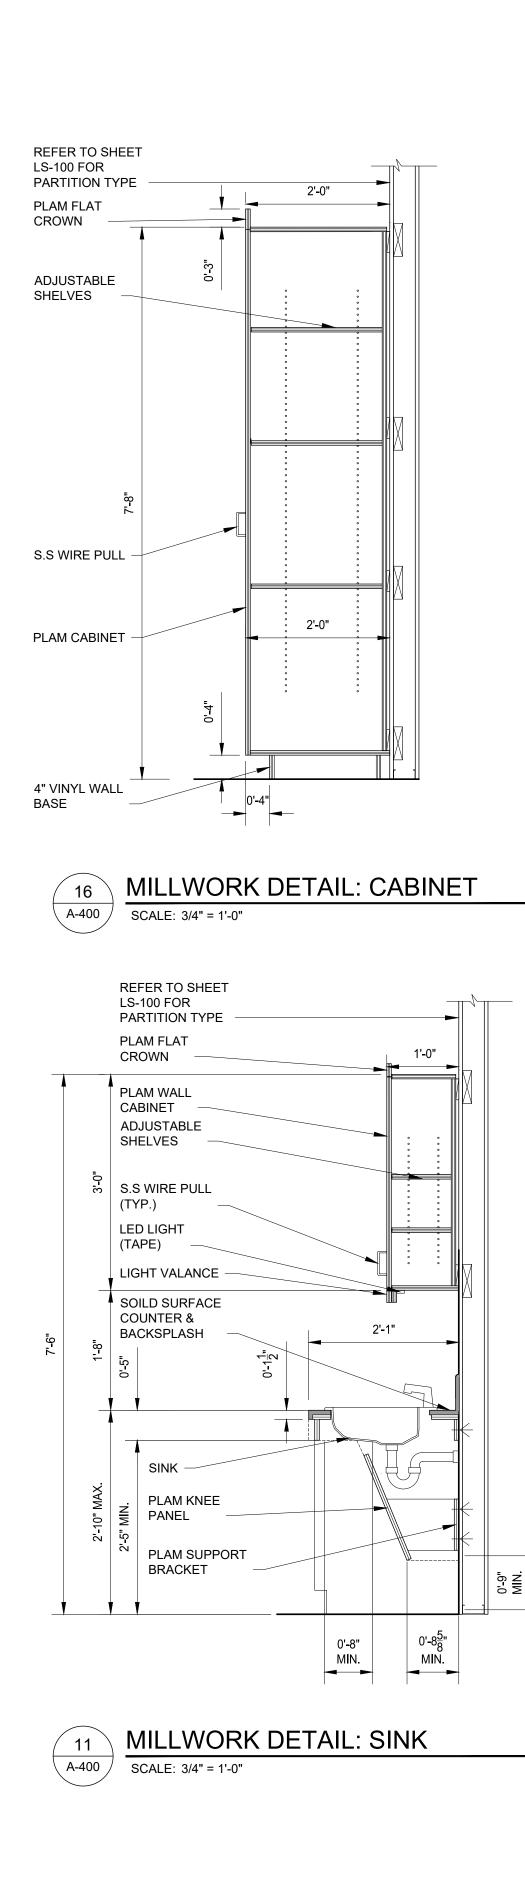
City of Taylor Animal Shelter Remodel & Expansion



Drawn:	WD/JC/NC
Checked:	WD
Approved:	MR

Sheet Title: MILLWORK DETAILS





PRIMARY PRODUCT SELECTIONS

OVERHEAD DOORS	RESTROOM ACCESSORIES	DECORATIVE ALUMINUM FENCE					DOOR SCHEDULE
PRODUCT: OVERHEAD SECTIONAL DOOR	PRODUCT: FLOOR-STANDING WASTE RECEPTACLE WITH OPEN TOP	PRODUCT: ALUMINUM FENCING			SIZE	DOOR	FRAME
MFR: OVERHEAD DOOR MODEL: THERMACORE SECTIONAL STEEL DOOR MODEL 593 COLOR: TBD (STANDARD COLOR SELECTION)	MFR: BOBRICK MODEL: B-2260 COLOR: SATIN FINISH STAINLESS STEEL	MFR: ALUMI-GUARD MODEL: FLAT TOP COMMERCIAL ASCOT 3 RAIL WITH RINGS COLOR: BLACK					SET SET
LOCATION: ROOM NUMBER: 138 DELIVERY / PICK UP / STORAGE	NOTES: 1.	NOTES: 1. CONTACT INFO: 877-258-6448 / info@alumi-guard.com				TYPE ELEV/ FINISH	VARE E TYPE E ELEV E FINIS
NOTES:1.REFER TO DOOR SCHEDULE FOR SIZES.2.REFER TO DOOR SCHEDULE FOR FIRE	PRODUCT: WELDED FRAME MIRROR		DOOR NO.	ROOM NAME		000R 000R	IARDV RAME RAME IRE R
RATINGS. 3. DOOR NUMBER 138B PRODUCT: OVERHEAD SECTIONAL DOOR	MFR: BOBRICK MODEL: B-290 2436	BRICK	100	LOBBY	5 II 6'-0" 7'-0	а <u>с</u> <u>с</u> <u>и</u> " ALUM 4 FPT NONE	I I I I I 1 ALUM J FPT NONE NO
MFR: OVERHEAD DOOR MODEL: EVERSENSE ALUMINUM GLASS DOOR MODEL 521S	COLOR: SATIN FINISH STAINLESS STEEL	PRODUCT: BRICK MFR: THE BELDEN BRICK SALES COMPANY	101	VESTIBULE	6'-0" 7'-0		1 ALUM I FPT NONE ALL
COLOR: TBD (STANDARD COLOR SELECTION) LOCATION: ROOM NUMBER: 105 MULTIPURPOSE ROOM	NOTES: 1.	MODEL: 26-HB FL COLOR: TO MATCH EXIST.	103 104	MEN'S TOILET ROOM WOMEN'S TOILET ROOM	3'-0" 7'-0 3'-0" 7'-0		7 HM B PT NONE NO 7 HM B PT NONE NO
NOTES: 1. REFER TO DOOR SCHEDULE FOR SIZES.	PRODUCT: AUTOMATIC WALL-MOUNTED FOAM SOAP DISPENSER MFR: BOBRICK	NOTES: 1. SIZE: 3-5/8" X 7-5/8" MOLDED	105A	MULTIPURPOSE ROOM	3'-0" 7'-0		6 HM K PT NONE ALL
2. REFER TO DOOR SCHEDULE FOR FIRE RATINGS.	MODEL: B-2013 COLOR: SATIN FINISH STAINLESS STEEL		105B 106	MULTIPURPOSE ROOM	12'-0" 10'-0		11 ALUM - FPT NONE ALU
3. DOOR NUMBER 105B	NOTES: 1.	EXTERIOR SIDING	107	DOG VISIT ROOM	3'-0" 7'-0 3'-0" 7'-0		2 HM B PT NONE ALL 2 HM D PT NONE ALL
ROOF HATCH	PRODUCT: SURFACE-MOUNTED TOILET TISSUE DISPENSER	PRODUCT: PRE-FIN METAL SIDING MFR: BERRIDGE	108	DOG VISIT ROOM	3'-0" 7'-0		2 HM D PT NONE ALL
PRODUCT: SINGLE POINT LATCH ROOF HATCH MFR: BABCOCKDAVIS	MFR: BOBRICK MODEL: B-76867 COLOR: SATIN FINISH STAINLESS STEEL	MODEL: RS-145 PANEL COLOR: ROYAL BLUE	109 110	DOG VISIT ROOM MECHANICAL / ELECTRICAL ROOM	3'-0" 7'-0 3'-0" 7'-0		2 HM D PT NONE ALL 4 HM B PT NONE ALL
MODEL: BW3636 COLOR: HIGH REFLECTANCE WHITE POWDER	NOTES: 1.	NOTES: 1. COLOR 1	111A	HALLWAY	3'-0" 7'-0		1 ALUM D FPT NONE ALL
COAT NOTES: 1. 36" X 36" SIZE. REFER TO PLANS FOR LOCATION.	PRODUCT: SURFACE-MOUNTED PAPER TOWEL DISPENSER WITH TOWELMATE	PRODUCT: PRE-FIN METAL SIDING	111B 112A	HALLWAY EMPLOYEE BREAK ROOM	3'-0" 7'-0		9 HM A PT NONE ALL
	MFR: BOBRICK MODEL: B-4262	MFR: BERRIDGE MODEL: FW-1025 PANEL	112A 112B	EMPLOYEE BREAK ROOM	3'-0" 7'-0 3'-0" 7'-0		6 HM E PT NONE NOI 6 HM E PT NONE ALL
SKYLIGHT	COLOR: SATIN FINISH STAINLESS STEEL	COLOR: ZINC GREY	113	OFFICE	3'-0" 7'-0		5 HM D PT NONE NO
PRODUCT: TRADITIONAL DOUBLE DOME, DECK MOUNT UNIT MFR: WASCO SKYLIGHTS	NOTES: 1.	NOTES: 1. COLOR 2	114 115	OFFICE OFFICE	<u> </u>		5 HM D PT NONE NOI 5 HM D PT NONE NOI
MODEL: CWD2 6060 COLOR: TBD (STANDARD COLOR SELECTION)	PRODUCT: STRAIGHT GRAB BAR MFR: BOBRICK	EXTERIOR SIGNAGE	116	OFFICE	3'-0" 7'-0		
NOTES: 1. REFER TO PLANS FOR LOCATION.	MODEL: B-6806 X 18", B-6806 X 30", B-6806 X 42" COLOR: SATIN FINISH STAINLESS STEEL	PRODUCT: (1) DIRECTIONAL PEDESTAL SIGN	117 118	MECHANICAL / ELECTRICAL ROOM	<u> </u>		
PRODUCT: SAFETY SCREEN MFR: WASCO SKYLIGHTS	NOTES: 1.	(3) WALL MOUNTED FLAT PLAQUE SIGNS(2) ADA POLE MOUNTED PARKING SIGNS	119A	HALLWAY	3'-0" 7'-0		
MODEL: CAEW COLOR: TBD (STANDARD COLOR SELECTION)	ROOFTOP / ROOF ACCESS LADDER	 (1) LARGE BACK-LIT 'CITY LOGO' WALL MOUNTED SIGN (2) SURFACE MOUNTED SIGNS AT EXISTING MASONRY MONUMENT SIGN BASE 	119B	HALLWAY	3'-0" 7'-0		
NOTES: 1. 4" X 4" HEAVY GAUGE GALVANIZED WELDED	PRODUCT: FIXED STEEL LADDER		120 121	HALLWAY EMPLOYEE WOMEN'S TOILET ROOM	3'-0" 7'-0 3'-0" 7'-0		6 HM B PT NONE ALU 7 HM B PT NONE ALU
WIRE SCREEN	MFR: FSIINDUSTRIES MODEL: WLFS0207-Y (WITH WALK-THRU)	NOTES: 1. GC SHALL SUPPLY & INSTALL ALL EXTERIOR SIGNAGE 2. GC TO INCLUDE AN ALLOWANCE OF \$14,000 WITHIN	122	EMPLOYEE MEN'S TOILET ROOM	3'-0" 7'-0		7 HM B PT NONE ALU
CANOPIES	COLOR: SAFETY YELLOW FINISH (ONLY OPTION) NOTES: 1. SEE PLANS FOR LOCATION.	BASE BID FOR SIGNS AS LISTED ABOVE.	123 124A	SHOWER	3'-0" 7'-0 3'-0" 7'-0		
PRODUCT: ARCHITECTURAL CANOPY	2. ROOFTOP LADDER	ARTIFICIAL TURF	124B	HALLWAY	3'-0" 7'-0		6 HM B PT NONE ALL
MFR: MAPES ARCHITECTURAL CANOPIES MODEL: LUMISHADE T6-6063	PRODUCT: FIXED STEEL LADDER MFR: FSIINDUSTRIES	PRODUCT: ARTIFICIAL TURF MFR: SPORT Z TURF	125 126	CAT PLAY / VISIT ROOM	3'-0" 7'-0		2 HM B PT NONE NO
COLOR: TBD (STANDARD COLOR SELECTION) NOTES: 1. CUSTOM SIZING. REFER TO PLANS FOR	MODEL: WLFS0111-Y (WITHOUT WALK-THRU) COLOR: SAFETY YELLOW FINISH (ONLY OPTION)	MODEL: TBD COLOR: TBD	120	CAT PLAY ROOM	3'-0" 7'-0 3'-0" 7'-0		2 HM M PT NONE NOI 2 HM M PT NONE NOI
LOCATION & SIZING.	NOTES: 1. SEE PLANS FOR LOCATION. 2. ROOF ACCESS LADDER	NOTES: 1. CONTACT INFO: 734-772-5335	128A		3'-0" 7'-0		
SHADE SAIL			128B 130	FELINE KENNEL MISC. STORAGE	3'-0" 7'-0 3'-0" 7'-0		9 HM B PT NONE ALU 4 HM B PT NONE NO
PRODUCT: 3-POINT SHADE SAIL MFR: LAWRENCE FABRIC & METAL STRUCTURES	KENNELS		131	MECHANICAL ROOM	3'-0" 7'-0		4 HM B PT NONE NO
MODEL: CUSTOM COMMERCIAL SHADE SAIL COLOR: TBD (STANDARD COLOR SELECTION)	PRODUCT: CANINE KENNELS MFR: MIDMARK CORP. MODEL: SANI-KENNEL		132A 132B	INTAKE CHECK IN / GUEST VET. INTAKE CHECK IN / GUEST VET.	3'-0" 7'-0 3'-0" 7'-0		1 ALUM E FPT NONE ALU 6 HM B PT NONE ALU
NOTES: 1. CONTACT INFO: (800) 527-3840 / (636)	MODEL: SANI-KENNEL COLOR: TBD (STANDARD COLOR SELECTION)		133	CAT ISO.	3'-0" 7'-0		
861-0100	NOTES: 1. STAINLESS STEEL FRAME AND GATE COMPONENTS 2. FRP WALL PANELS		134 135A	DOG ISO. ENTRY FOYER	3'-0" 7'-0 EXST EXS		9 HM B PT NONE ALL 1 EXST EXST PT EXST EX
HOSE REEL	 STAINLESS STEEL DIVIDER GATE KENNEL HEIGHT IS 6'-4" 		135B	ENTRY FOYER	3'-0" 7'-0		
PRODUCT: HOSE REEL MFR: REEL CRAFT	 SEE PLANS FOR LAYOUT PRODUCT PROVIDED BY OWNER 		136 137	CAT HOLD / CAT RECOVERY HALLWAY	3'-0" 7'-0		9 HM B PT NONE ALL
MODEL: GC83050 OLP COLOR: TBD (STANDARD COLOR SELECTION)	PRODUCT: FELINE KENNELS MFR: MIDMARK CORP.		137 138A	DELIVERY / PICK UP / STORAGE	3'-0" 7'-0 3'-0" 7'-0		2 HM B PT NONE NOI 4 HM B PT NONE ALL
NOTES: 1.	MFR: MIDMARK CORP. MODEL: RAINTREE CAT CONDO COLOR: TBD (STANDARD COLOR SELECTION)		138B	DELIVERY / PICK UP / STORAGE	10'-0" 14'-0		10 ALUM - FPT NONE ALU
PRE-FAB SHOWER	NOTES: 1. LAMINATE FINISH AVAILABLE IN SEVERAL COLORS /		139A 139B	EUTH. ROOM EUTH. ROOM	3'-0" 7'-0 3'-0" 7'-0		8 HM B PT NONE ALU 8 HM B PT NONE NO
PRODUCT: ADA TRANSFER SHOWER - FOUR PIECE 42" X 38"	WOODGRAIN PATTERNS 2. EACH CAGE HAS 2 ROOMS 1 IS A LITTER BOX		140	DOG HOLD	3'-0" 7'-0	" SC 3 PT NONE	9 HM B PT NONE ALL
MFR: BARRIER FREE ARCHITECTURALS INC. MODEL: 4LSS4238A5T	COMPARTMENT 3. DOOR FRONTS ARE AN OPEN AIR MESH TYPE DESIGN 4. SEE PLANS FOR LAYOUT		141	DOG RECOVERY VOLUNTEER ROOM	3'-0" 7'-0 3'-0" 7'-0		9 HM B PT NONE ALL 2 HM B PT NONE ALL
COLOR: SMOOTH WALL - WHITE	5. PRODUCT PROVIDED BY OWNER		143	FELINE LAUNDRY	3'-0" 7'-0		2 HM B PT NONE ALL
NOTES: 1.			148 152	PUPPY KENNEL QUARANTINE	3'-0" 7'-0		2 HM A PT NONE NOI 2 HM A PT NONE NOI
APPLIANCES			154A	CANINE KENNEL 2	3'-0" 7'-0 3'-0" 7'-0		3 HM A PT NONE NO
PRODUCT: (1) FULL SIZE REFRIGERATOR			154B	CANINE KENNEL 2	3'-0" 7'-0		3 HM A PT NONE NO
(2) BELOW COUNTER REFRIGERATORS (2) MICROWAVES			154C 155A	CANINE KENNEL 2 CANINE KENNEL 1	3'-0" 7'-0 6'-0" 7'-0		1 ALUM F FPT NONE ALU 3 HM A PT NONE NOI
(1) DISHWASHER (2) SETS OF WASHERS & DRYERS			155B	CANINE KENNEL 1	3'-0" 7'-0		1 ALUM C FPT NONE ALU
NOTES: 1. GC SHALL SUPPLY & INSTALL THE APPLIANCES ABOVE.			155C 157	CANINE KENNEL 1 GUN RANGE ENTRY VESTIBULE	3'-0" 7'-0 6'-0" 7'-0		1 ALUM F FPT NONE ALU 1 ALUM G FPT NONE ALU
2. GC TO INCLUDE AN ALLOWANCE OF \$14,000 WITHIN BASE BID.			158	GUN RANGE ENTRY CORRIDOR	6'-0" 7'-0		1 ALUM H FPT NONE ALL
3. FINAL PRODUCT SELCTIONS TO BE MADE BY ARCHITECT / OWNER AT A LATER DATE.			SCHEDULE LE	GEND			
ARTIFICIAL PLANTINGS				NISHED METAL DW METAL	D	OOR HARDWAR	ESEIS
PRODUCT: INTERIOR FAUX PLANTS			SF STRUC	NISHED ALUMINUM TURAL STEEL FRAME (BUILDING FRAME CO		T 1: HD HINGES	SET 2: SE 3 HD HINGES 3 H
MFR: COMMERCIAL SILK MODEL: TBD				CORE WOOD DOOR IEAD SECTIONAL DOOR	1 E 1 C	ENTRY LOCKSET W/ PANIC BAR DVERHEAD CLOSER	1 PASSAGE STYLE LOCKSET 1 N 1 OVERHEAD CLOSER 1 F
COLOR: TBD NOTES: 1. CONTACT INFO:			FPT FACTO ST STAINE	DRY PAINT ED	1 5	SET WEATHERSTRIP SWEEP	
9901 West 74th St. Minneapolis, MN 55344. USA			TRN ALUMI	NUM TILE TRANSITION STRIP (SCHLUTER P	RODUCT) ^{1 A}	ALUM. THRESHOLD	
Toll Free: 800-241-2718 Main: 952-934-7666						T 6:	SET 7: SE
Fax: 952-934-3807 info@commercialsilk.com					1 F	HD HINGES PRIVACY STYLE LOCKSET OVERHEAD CLOSER	3 HD HINGES 3 H 1 OVERHEAD CLOSER 1 C 1 PUSH PLATE 1 F
2. GC SHALL PROVIDE A \$2,500 ALLOWANCE WITHIN THEIR BASE BID TO SUPPLY & INSTALL ARTIFICIAL PLANTS WITHIN THE						PUSH SIDE KICK PLATE	1 PULL HANDLE RE 1 KICK PLATE PUSH SIDE 1 K
KENNEL PLANTER BOXES.							

THRESHOLD		DETAILS			
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	Η	AL	SILL	COMMENTS	
				ELECTRIC STRIKE	
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			NOTE:	SEE COMMENTS ON SCHED	ULE FOR ELECTRIC STRIKES
SET 3:			SET 4:		SET 5:
3 HD SPRING HINGES (DUAL SWING) 3		3 HD HIN 1 STORA		3 HD HINGES 1 CLASSROOM STYLE LOCKSET	
1 PULL HANDLE (SA SIDE)		1 OVERH	EAD CLOSER ATHERSTRIP	1 OVERHEAD STOP 1 ALUM. THRESHOLD	
			1 SWEEP		
				THRESHOLD	
SET 8:			SET 9:		SET 10:
1 OVEF	IINGES RHEAD CLOSE			GE STYLE LOCKSET	OVERHEAD DOOR HARDWARE. MOTOR OPERATED
I PRIV	ACY LOCKSET	W/ OCCUPANCY	1 OVERH 1 SET WE	EAD CLOSER ATHERSTRIP	
1 KICK PLATE PUSH SIDE		1 SWEEP		SET 11:	
			1 ALUM. THRESHOLD		OVERHEAD DOOR HARDWARE.



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Key Plan:



Client:
City of Taylor 23555 Goddard Rd.
Taylor, MI 48180

Project:

City of Taylor Animal Shelter Remodel & Expansion

25555 Northline R Taylor, MI 48180	d.
Seal:	OF MICHICA DBERT M. NOTH JR. NGINEER No. DI031023
Date	Issued For
09-13-2023	25% Complete Review


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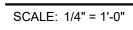
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Checked:	WD
Approved:	MR


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DOOR
SCHEDULE

Project Number: 22712.A

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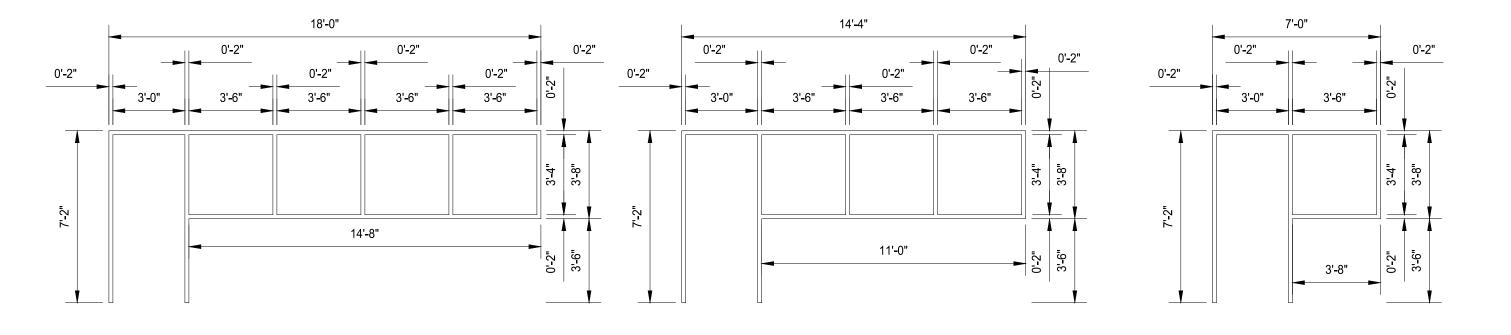





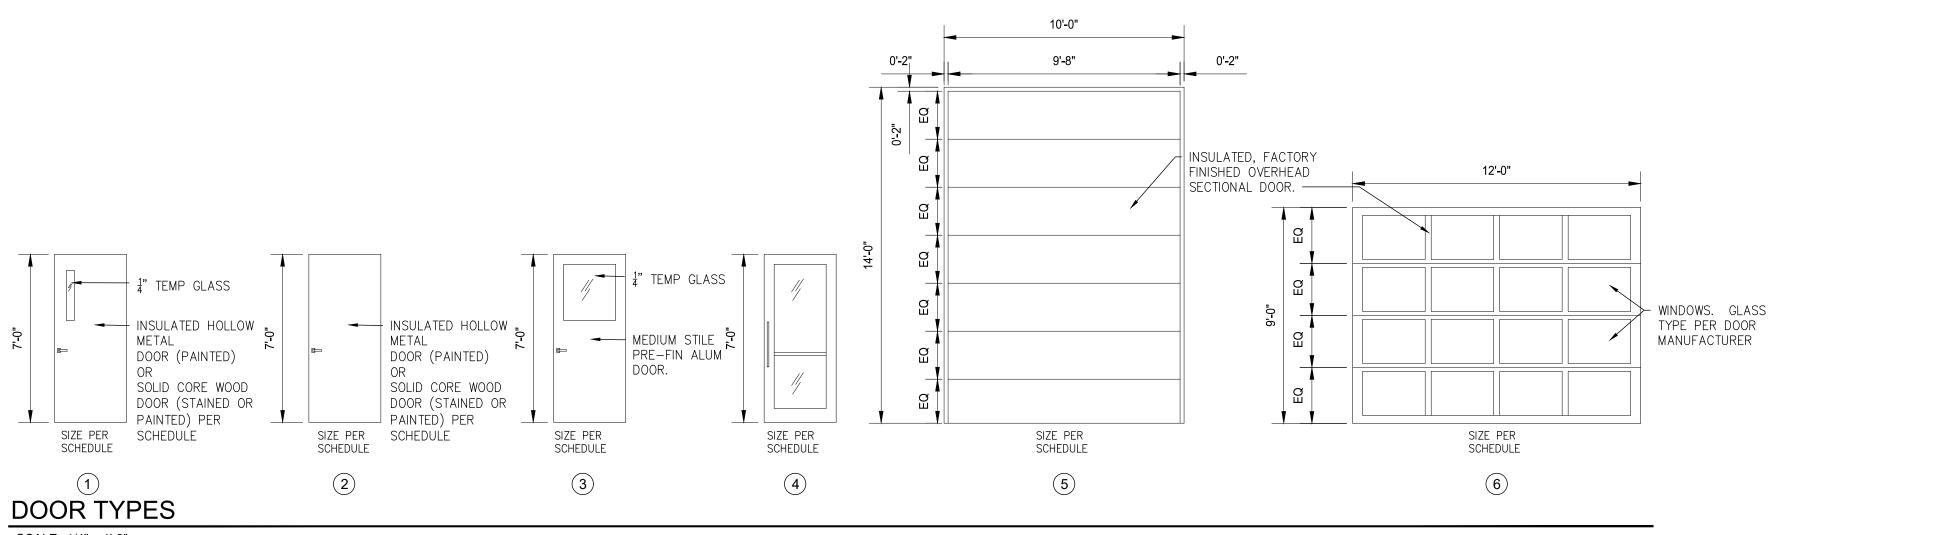

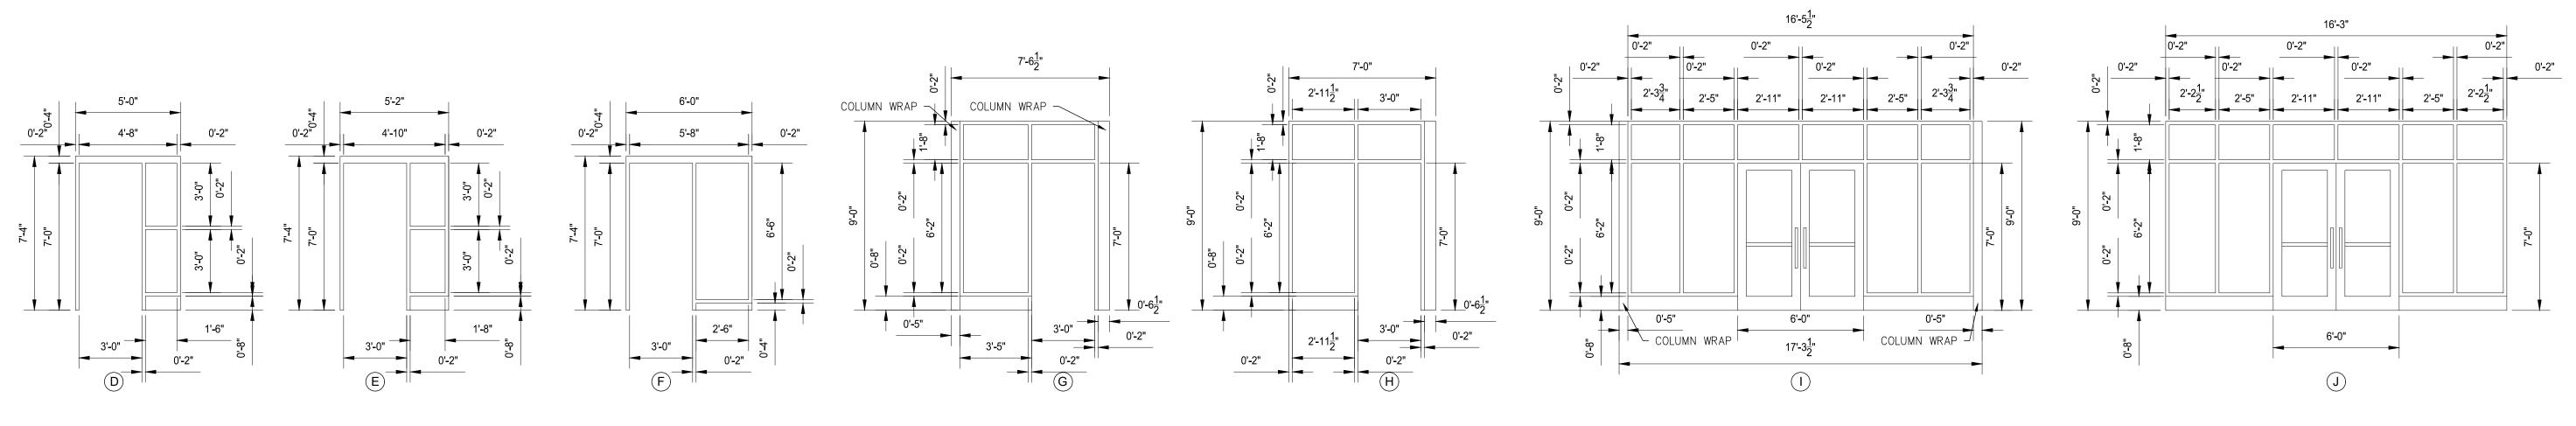


SCALE: 1/4" = 1'-0"




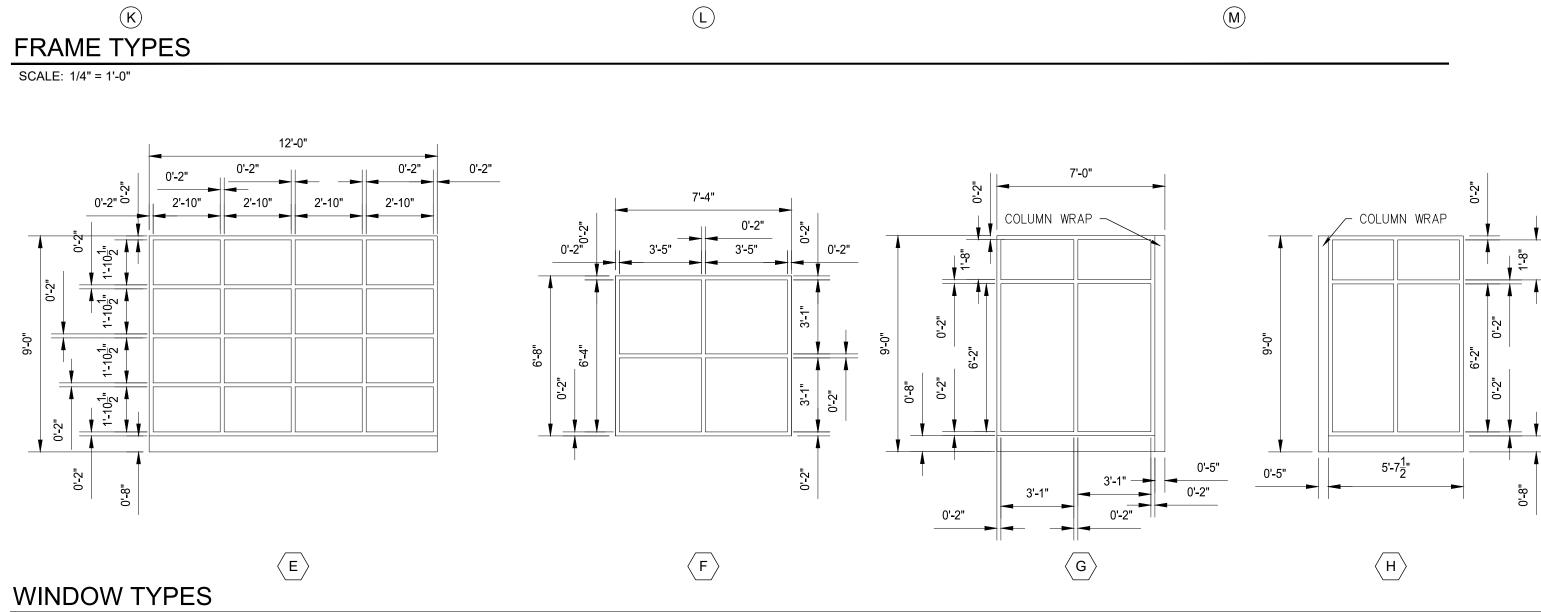



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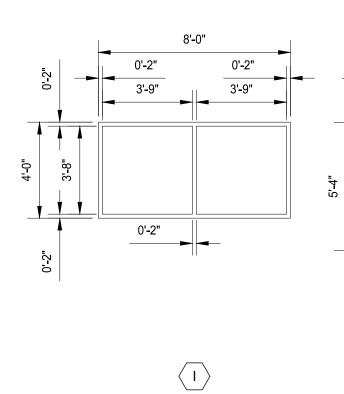

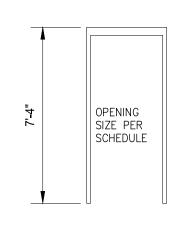
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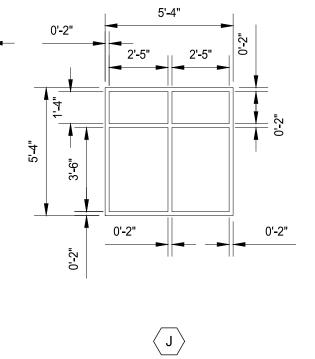





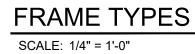


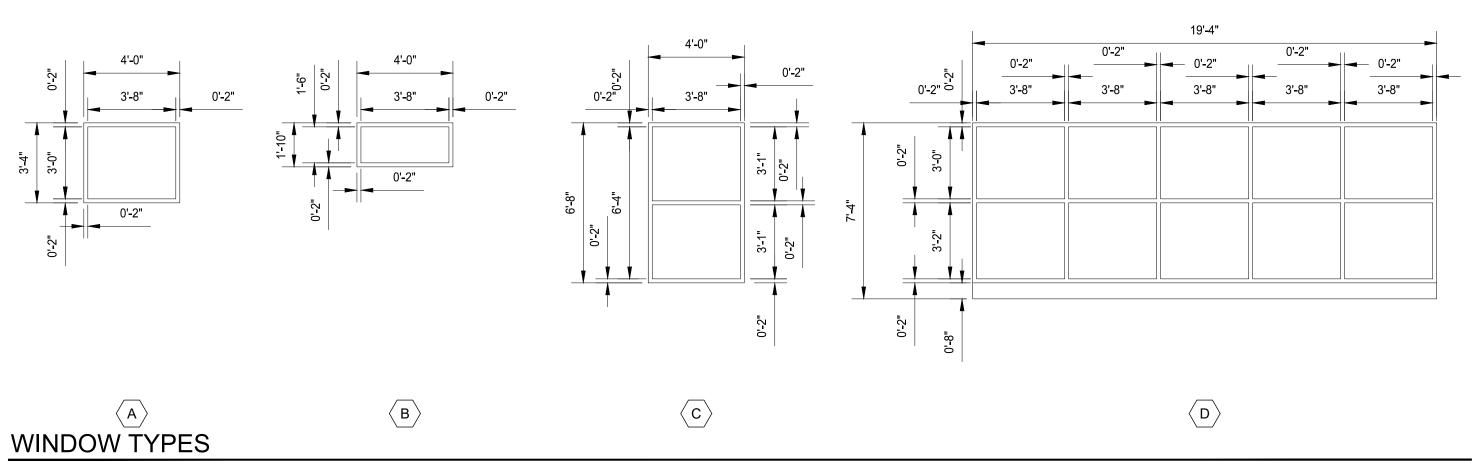

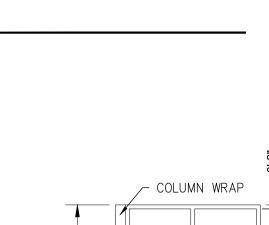
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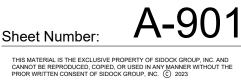
Project: City of Taylor Animal Shelter Remodel & Expansion


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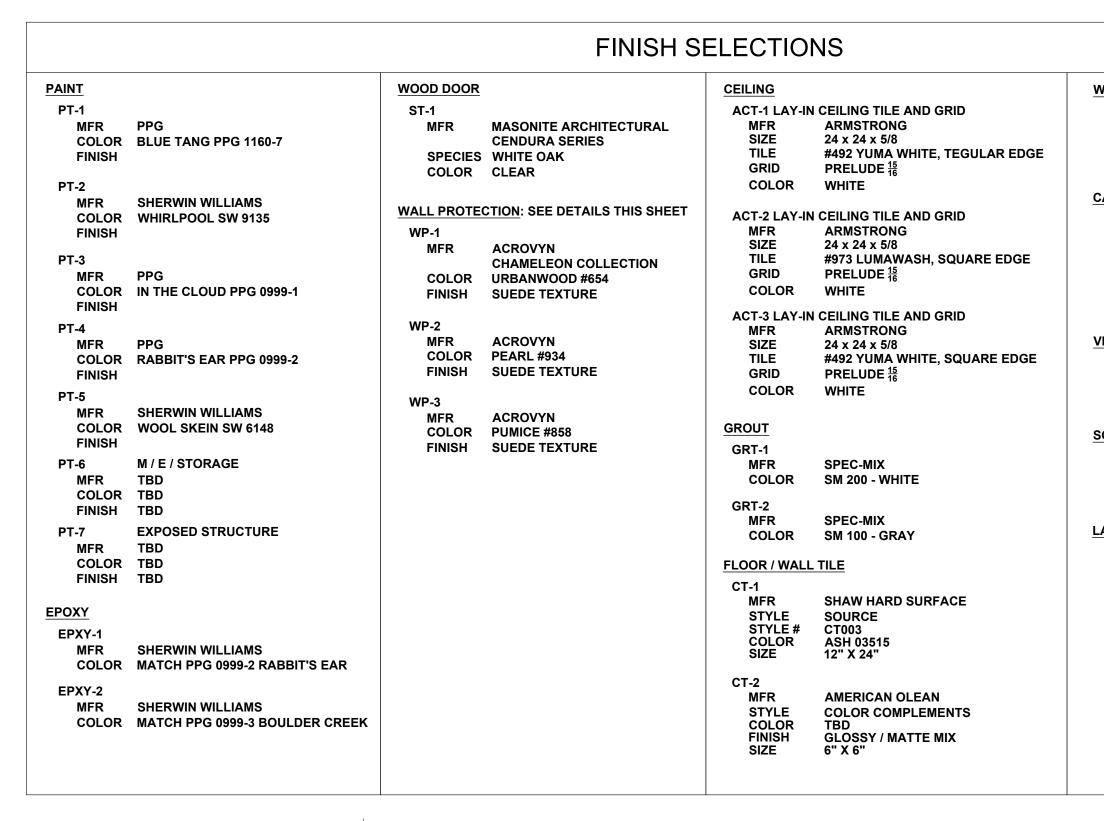
Drawn:	WD/JC/NC
Checked:	WD
Approved:	MR

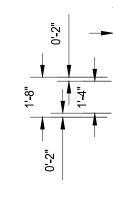


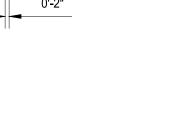
22712.A Project Number:

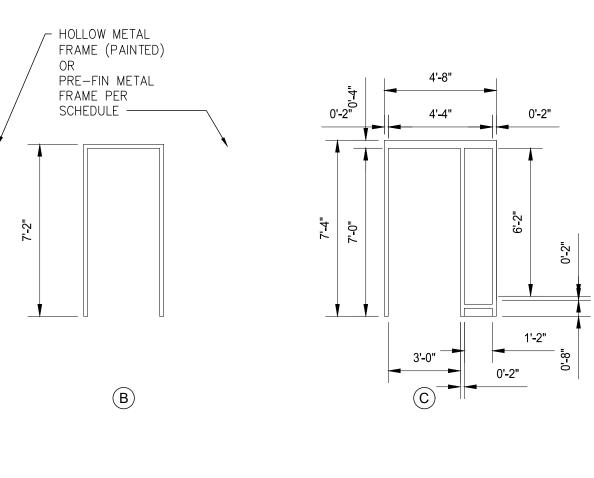



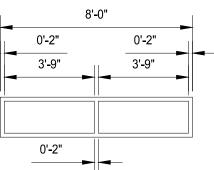

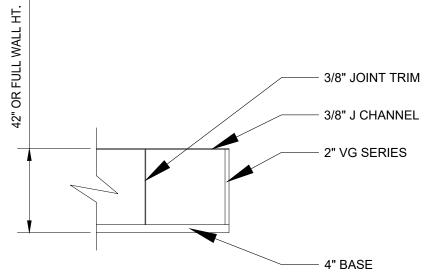

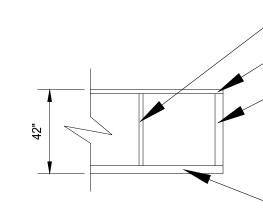

ACROVYN: WP-2, WP-3 (PANEL & TRIM)

ACROVYN: WP-1 (PANEL, TRIM, & BASE)

WALL PROTECTION DETAILS

SCALE: 1/4" = 1'-0"

WALL BASE							
RB-1 RUBBER V MFR COLOR	VALL BASE JOHNSONITE 48 GREY						
CARPET							
CPT-1 MFR PRODUCT STYLE COLOR	PATCRAFT CAMBER 10485 FOCUS 00450						
VINYL COMPOSIT	<u>E TILE</u>						
VCT-1 MFR COLOR	TARKETT VCT 1314 WHITE / GRAY						
SOLID SURFACE							
SS-1 MFR COLOR	CORIAN CARBON CONCRETE						
LAMINATE							
PL-1 MFR COLOR FINISH	FORMICA DOGBONE WHITE 5281-58 MATTE FINISH						
PL-2 MFR COLOR FINISH	WILSONART HARVEST MAPLE 7053-58 FINE VELVET FINISH						
	EDIATE TRIM @ SEAMS						
2" TOP TRIM							
	R TRIM (INSIDE & UTSIDE)						

— 4" BASE

			_		WALLS				NOTES
	ROOM NAME	FLOOR	BASE	N	S	E	W	CEILING	NOTES
FIRST FL	1					/		0	
100	LOBBY	CT-1/CT-2	CT-1/CT-2	PT-4	PT-4	PT-4	PT-4	STRC/PT-7	
101	VESTIBULE	CT-1	CT-1	- DT 4	- DT 4	- DT 4	- DT 4	PT-	
102 103	RECEPTION MEN'S TOILET ROOM	CPT-1 CT-1/CT-2	RB-1 CT-1/CT-2	PT-4 PT-4	PT-4 PT-4/CT-1/CT-2	PT-4 PT-4/CT-1	PT-4 PT-4/CT-1	ACT-1 ACT-1	
103	WOMEN'S TOILET ROOM	CT-1/CT-2		PT-4/CT-1/CT-2	PT-4	PT-4/CT-1	PT-4/CT-1	ACT-1	
104	MULTIPURPOSE ROOM	EPXY-1	-	PT-3/WP-1	PT-3/WP-1	PT-3/WP-1	PT-3/WP-1	STRC/PT-7	
106	MULTIPURPOSE STORAGE ROOM	EPXY-1	RB-1	PT-3/WP-2	PT-3/WP-2	PT-3/WP-2	PT-3/WP-2	ACT-1	
107	DOG VISIT ROOM	EPXY-1	RB-1	PT-3/WP-2	PT-3/WP-2	PT-3/WP-2	PT-3/WP-2	ACT-1	
108	DOG VISIT ROOM	EPXY-1	RB-1	PT-3/WP-2	PT-3/WP-2	PT-3/WP-2	PT-3/WP-2	ACT-1	
109	DOG VISIT ROOM	EPXY-1	RB-1	PT-3/WP-2	PT-3/WP-2	PT-3/WP-2	PT-3/WP-2	ACT-1	
110	MECHANICAL / ELECTRICAL ROOM	EPXY-1	RB-1	PT-6	PT-6	PT-6	PT-6	STRC/PT-1	
111	HALLWAY	VCT-1	RB-1	PT-4/WP-1	PT-4/WP-1	PT-4/WP-1	PT-4/WP-1	ACT-1	
112	EMPLOYEE BREAK ROOM	CT-1	RB-1	PT-1	PT-4	PT-4	PT-4	ACT-1	
113	OFFICE	CPT-1	RB-1	PT-4	PT-1	PT-4	PT-4	ACT-1	
114	OFFICE	CPT-1	RB-1	PT-4	PT-1	PT-4	PT-4	ACT-1	
115	OFFICE	CPT-1	RB-1	PT-4	PT-1	PT-4	PT-4	ACT-1	
116	OFFICE	CPT-1	RB-1	PT-4	PT-1	PT-4	PT-4	ACT-1	
117	MECHANICAL / ELECTRICAL ROOM	EPXY-1	RB-1	PT-6	PT-6	PT-6	PT-6	STRC/PT-7	
118	HALLWAY	CT-1	RB-1	PT-1	PT-4	PT-4	PT-4	ACT-1	
119	HALLWAY	VCT-1	-	PT-4/WP-1	PT-4/WP-1	PT-4/WP-1	PT-4/WP-1	ACT-1	
120	HALLWAY	VCT-1	RB-1	PT-4/WP-1	PT-4/WP-1	PT-4/WP-1	PT-4/WP-1	ACT-1	
121	EMPLOYEE WOMEN'S TOILET ROOM	CT-1/CT-2	CT-1/CT-2	PT-4/CT-1	PT-4/CT-1/CT-2	PT-4/CT-1	PT-4/CT-1	ACT-1	
122	EMPLOYEE MEN'S TOILET ROOM	CT-1/CT-2	CT-1/CT-2	PT-4/CT-1/CT-2	PT-4/CT-1	PT-4/CT-1	PT-4/CT-1	ACT-1	
123	SHOWER	CT-1	CT-1	PT-	PT-	PT-	PT-	PT-	
124	HALLWAY	CT-1/CT-2	CT-1/CT-2	PT-4	PT-4	PT-4	PT-4	ACT-1	
125	CAT PLAY / VISIT ROOM	EPXY-1	RB-1	PT-4/WP-2	PT-4/WP-2	PT-4/WP-2	PT-4/WP-2	ACT-1	
126	CAT PLAY ROOM	EPXY-1	RB-1	PT-4/WP-2	PT-4/WP-2	PT-4/WP-2	PT-4/WP-2	ACT-1	
127	CAT PLAY ROOM	EPXY-1	RB-1	PT-4/WP-2	PT-4/WP-2	PT-4/WP-2	PT-4/WP-2	ACT-1	
128	FELINE KENNEL	EPXY-1/EPXY-2	RB-1	PT-3/WP-2	PT-3/WP-2	PT-3/WP-2	PT-3/WP-2	STRC/PT-7	
129	CAT WASH	EPXY-1/EPXY-2	RB-1	PT-3/WP-2	PT-3/WP-2	PT-3/WP-2	PT-3/WP-2	ACT-2	
130	MISC. STORAGE	EPXY-1	RB-1	PT-6	PT-6	PT-6	PT-6	ACT-3	
131	MECHANICAL ROOM	EPXY-1	RB-1	PT-6	PT-6	PT-6	PT-6	ACT-3	
132	INTAKE CHECK IN / GUEST VET.	CT-1	-	PT-4/WP-1	PT-4/WP-1	PT-1/WP-1	PT-4/WP-1	ACT-1	
133	CAT ISO.	EPXY-1	-	WP-2	WP-2	WP-2	WP-2	ACT-2	
134	DOG ISO.	EPXY-1	-	WP-2	WP-2	WP-2	WP-2	ACT-2	
135	ENTRY FOYER	VCT-1	RB-1	PT-4/WP-1	PT-4/WP-1	PT-4/WP-1	PT-4/WP-1	ACT-1	
136	CAT HOLD / CAT RECOVERY	EPXY-1	-	WP-2	WP-2	WP-2	WP-2	ACT-2	
137	HALLWAY	VCT-1	RB-1	PT-4/WP-1	PT-4/WP-1	PT-4/WP-1	PT-4/WP-1	ACT-1	
138	DELIVERY / PICK UP / STORAGE	EPXY-1	-	PT-	PT-	PT-	PT-	STRC/PT-7	
139	EUTH. ROOM	VCT-1	RB-1	PT-4/WP-1	PT-4/WP-1	PT-4/WP-1	PT-4/WP-1	ACT-2	
140	DOG HOLD	EPXY-1	-	WP-2	WP-2	WP-2	WP-2	ACT-2	
141	DOG RECOVERY	EPXY-1	-	WP-2	WP-2	WP-2	WP-2	ACT-2	
142		VCT-1	RB-1	PT-4/WP-1	PT-4/WP-1	PT-4/WP-1	PT-4/WP-1	ACT-1	
143		EPXY-1	-	WP-2	WP-2	WP-2	WP-2	ACT-2	
144		EXST	EXST	EXST	EXST	EXST	EXST	EXST	
145	EXISTING GUN RANGE TOILET	EXST	EXST	EXST	EXST	EXST	EXST	EXST	
146		EXST	EXST	EXST	EXST	EXST	EXST	EXST	
147		EXST	EXST	EXST	EXST	EXST	EXST	EXST	
148		EPXY-2	-	PT-4	PT-4	PT-4	PT-4	ACT-2	
149		EPXY-2	-	PT-4	PT-4	PT-4	PT-4	ACT-3	
150		EPXY-2	-	PT-4	PT-4	PT-4	PT-4	ACT-3	
151		EPXY-2	-	PT-4	PT-4	PT-4	PT-4	ACT-3	
152		EPXY-2	-	PT-4	PT-4	PT-4	PT-4	ACT-2	
153	MISC. STORAGE	EPXY-2	-	PT-4	PT-4	PT-4	PT-4	STRC/PT-7	
154	CANINE KENNEL 2	EPXY-1/EPXY-2	-	PT-4	PT-4	PT-4	PT-4	STRC/PT-7	
155	CANINE KENNEL 1	EPXY-1/EPXY-2	-	PT-4	PT-4	PT-4	PT-4	STRC/PT-7	
156		EPXY-2	- CT 1	PT-4	PT-4	PT-4	PT-4	ACT-2	
157	GUN RANGE ENTRY VESTIBULE	CT-1	CT-1	PT-	PT-	PT-	PT-	STRC/PT-7	
158		CT-1	CT-1	PT-	PT-	PT-	PT-	STRC/PT-7	
SECOND F		EVAT	EV07	EVOT	EVAT	EVOT	EVOT	EVAT	
200	EXISTING MULTIPURPOSE ROOM	EXST	EXST	EXST	EXST	EXST	EXST	EXST	
201	EXISTING STORAGE ROOM	EXST	EXST	EXST	EXST	EXST	EXST	EXST	
202	EXISTING WOMEN'S TOILET ROOM	EXST	EXST	EXST	EXST	EXST	EXST	EXST	
	EXISTING MEN'S TOILET ROOM	EXST	EXST	EXST	EXST	EXST	EXST	EXST	

CPT CARPET VCT VINYL COMPOSITE TILE PC POLISHED CONCRETE FT FLOOR TILE WT WALL TILE PT PAINT

VB VINYL BASE WB WOOD BASE ACT ACOUSTICAL CEILING TILE

STRC EXPOSED STRUCTURE

NF NO FINISH SC SEALED CONCRETE



Corporate Headquarters 45650 Grand River Ave. Novi, Michigan 48374 Ph: (248)349-4500 • Fax: (248)349-1429

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Key Plan:




Client: City of Taylor

23555 Goddard Rd. Taylor, MI 48180

Project:

City of Taylor Animal Shelter Remodel & Expansion

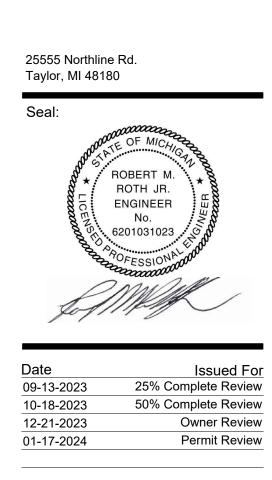

Drawn:	WD/JC/NC
Checked:	WD
Approved:	MR

Sheet Title: **ROOM FINISH** SCHEDULE

Project Number: 22712.A

Sheet Number: A-902

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GENERAL NOTES:

- A. THIS PLAN IS INTENDED TO ILLUSTRATE SPECIFIC FLOOR TILE PATTERNS, AND WALL MURAL LOCATIONS ONLY. REFER TO ROOM SCHEDULE FOR ALL FLOORING MATERIALS.
- B. PAINTED WALL MURALS WILL BE LARGE SILHOUETTES OF ANIMALS. PAINTING CONTRACTOR TO ACCOUNT FOR THESE WITHIN THE PAINTING SCOPE OF WORK. PAINTER TO CONSULT WITH ARCHITECT ON FINAL DESIGNS AND LOCATIONS PRIOR TO COMMENCEMENT OF WORK.

FLOOR PATTERN NOTES:

(1) FLOOR TILE PATTERN

- 2 FLOOR TILE WITHIN THIS ROOM TO BE ALIGNED WITH ANGLED TOILET ROOM WALL AS SHOWN.
- 3 FLOOR TILE TO BE RE-ALIGNED PERPENDICULAR TO HALLWAY WALLS AT THIS POINT.
- 4 SEE INTERIOR WALL ELEVATION FOR WIDTH DIMENSION OF THE SMALLER TILE.
- 5 AREA OF SECOND EPOXY FLOOR COATING COLOR WITHIN THIS ROOM.
- 6 LOCATION OF PAINTED WALL MURAL. SEE GENERAL NOTES 2 ON THIS SHEET.
- (7) WALK-OFF FLOOR MAT. MAT TO BE FLUSH WITH SURROUNDING FLOOR TILE AND SEPARATED WITH SCHLUTER EDGING.



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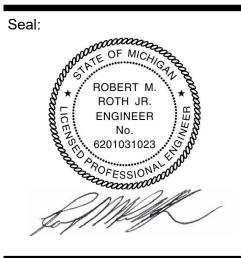


Client: City of Taylor 23555 Goddard Rd. Taylor, MI 48180

Project:

City of Taylor Animal Shelter Remodel & Expansion


25555 Northline Rd. Taylor, MI 48180



Date	Issued For
09-13-2023	25% Complete Review
10-18-2023	50% Complete Review
12-21-2023	Owner Review
01-17-2024	Permit Review

Drawn:	WD/JC/NC
Checked:	WD
Approved:	MR

Sheet Title: FLOOR PATTERN PLAN

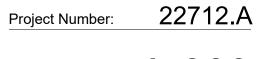

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GENERAL STRUCTURAL NOTES

1. ALL CONSTRUCTION SHALL COMPLY FULLY WITH THE APPLICABLE PROVISIONS OF MIOSHA, THE MICHIGAN BUILDING CODE, LATEST EDITION, AND THE LOCAL GOVERNING CODE, LATEST EDITIONS, AND ALL REQUIREMENTS SPECIFIED IN THE CODES SHALL BE ADHERED TO AS IF THEY WERE CALLED FOR OR SHOWN ON THE DRAWINGS. THIS SHALL NOT BE CONSTRUED TO MEAN THAT ANY REQUIREMENTS SET FORTH ON THE DRAWING MAY BE MODIFIED BECAUSE THEY ARE MORE STRINGENT THAN THE CODE REQUIREMENTS OR BECAUSE THEY ARE NOT SPECIFICALLY REQUIRED BY CODE.

PRE-ENGINEERED BUILDING DESIGN LOADS:

LIVE LOADS:	
ROOF LIVE LOAD	20 PSF
ROOF SNOW LOADS (WITH ADDITIONAL DRIFT & S	LIDING SNOW)
GROUND SNOW Pg	20 PSF
EXPOSURE FACTOR Ce	0.9
THERMAL FACTOR Ct	1.0
WIND DESIGN DATA	
BASIC WIND SPEED (3-SECOND GUST)	115 MPH
WIND EXPOSURE	В
INTERNAL PRESSURE COEFFICIENT	+/- 0.18
EARTHQUAKE DESIGN DATA	
SEISMIC IMPORTANCE FACTOR	1.0
MAPPED SPECTRAL RESPONSE ACCELERATIONS	
SHORT PERIOD (Ss)	0.01g
1-SECOND PERIOD (S1)	0.048g
SITE CLASS	D

- PRIOR TO SUBMITTING PROPOSAL. VERIFY ALL CONDITIONS GOVERNING OR AFFECTING THE STRUCTURAL WORK. OBTAIN AND VERIFY ALL DIMENSIONS TO ENSURE THE PROPER FIT AND LOCATION OF THE STRUCTURAL WORK, TAKE ADDITIONAL DIMENSIONS AS REQUIRED, REPORT TO THE ENGINEER ANY AND ALL CONDITIONS WHICH MAY INTERFERE WITH OR OTHERWISE AFFECT OR PREVENT THE PROPER EXECUTION AND COMPLETION OF THE WORK, FAMILIARIZE YOURSELF WITH THE ACTUAL CONDITIONS OF THE STRUCTURAL WORK, ACCESS TO THE SITE, AVAILABLE STORAGE SPACE, FACILITIES AND OBSTRUCTIONS THAT MAY BE ENCOUNTERED DURING THE PROGRESS OF WORK.
- 3. CONTRACTOR TO FURNISH ALL NECESSARY LABOR, MATERIAL, EQUIPMENT AND FACILITIES TO FURNISH, FABRICATE AND PERFORM THE REQUIRED STRUCTURAL WORK.
- 4. ALL WORK SHOWN ON THESE DRAWINGS MAY BE CHECKED BY AN INDEPENDENT TESTING AGENCY RETAINED BY OWNER TO ENSURE COMPLIANCE WITH THE REQUIREMENTS SHOWN ON THE DRAWINGS. THE CONTRACTOR SHALL PROVIDE ACCESS AS REQUIRED FOR TESTING PURPOSES.
- 5. CONTRACTOR SHALL MAKE ALL NECESSARY FIELD VISITS FOR INSPECTION, MEASUREMENTS AND VERIFICATION OF EXISTING CONDITION OF BUILDING.
- 6. THE GENERAL STRUCTURAL NOTES ARE INTENDED TO AUGMENT THE DRAWINGS AND SPECIFICATIONS. SHOULD CONFLICTS EXIST BETWEEN THE DRAWINGS, SPECIFICATION, AND/OR THE GENERAL STRUCTURAL NOTES, THE STRICTEST PROVISION AS DETERMINED BY THE ENGINEER SHALL GOVERN.
- 7. THE STRUCTURE IS DESIGNED TO BE SELF-SUPPORTING AND STABLE AFTER THE BUILDING IS FULLY COMPLETED. IT IS THE CONTRACTOR'S SOLE RESPONSIBILITY TO DETERMINE ERECTION PROCEDURE AND SEQUENCE, AND TO ENSURE THE SAFETY OF THE BUILDING AND ITS COMPONENT PARTS DURING ERECTION. THIS INCLUDES THE ADDITION OF TEMPORARY BRACING, GUYS AND/OR TIE-DOWNS AS NECESSARY. SUCH MATERIAL SHALL REMAIN THE CONTRACTOR'S PROPERTY AFTER COMPLETION OF THE PROJECT.
- 8. WORK THE STRUCTURAL DRAWINGS IN CONJUNCTION WITH THE ARCHITECTURAL, MECHANICAL, SITE AND ELECTRICAL DRAWINGS.

9. USE OF ENGINEERING DRAWINGS AS ERECTION DRAWINGS BY THE CONTRACTOR IS STRICTLY PROHIBITED. SITE PREPARATION

- 1. AT THE START OF EARTHWORK OPERATIONS, ALL SURFACE VEGETATION SHALL BE CLEARED AND THE EXISTING TOPSOIL AND ANY OTHER ORGANIC SOILS SHALL BE REMOVED IN THEIR ENTIRETY FROM BELOW THE PROPOSED BUILDING AND PAVEMENT AREAS. EXISTING RANDOM CONCRETE AND OTHER DEBRIS SHALL BE REMOVED FROM WITHIN THE BUILDING AREA.
- 2. THE SUB-GRADE SHOULD BE THOROUGHLY PROOF-ROLLED WITH A HEAVY RUBBER-TIRED VEHICLE SUCH AS A LOADED SCRAPER OR LOADED DUMP TRUCK. ANY AREAS THAT EXHIBIT EXCESSIVE PUMPING AND YIELDING DURING PROOF-ROLLING SHOULD BE STABILIZED BY AERATION, DRYING AND COMPACTION IF WEATHER CONDITIONS ARE FAVORABLE, OR REMOVAL AND REPLACEMENT WITH ENGINEERED FILL.
- 3. ALL EXCAVATIONS ARE SUBJECT TO THE APPROVAL OF THE OWNER'S REPRESENTATIVE, WHO SHALL BE CONSULTED WHEN POOR SOIL, WATER, OBSTRUCTIONS, PIPING, EXISTING FOOTINGS, EXCAVATIONS, ETC., ARE ENCOUNTERED.

FOOTINGS & FOUNDATIONS

- 1. CONTRACTOR SHALL VERIFY ALL CONDITIONS, INCLUDING UNDERGROUND UTILITIES. AND FIELD MEASUREMENTS AT JOB SITE AND REPORT ANY DISCREPANCIES TO THE ENGINEER.
- 2. PROVIDE ALL NECESSARY SHEETING, SHORING, BRACING, ETC. AS REQUIRED FOR EXCAVATIONS TO PROTECT SIDES OF EXCAVATIONS AND ADJACENT STRUCTURES.
- 3. CONTRACTOR SHALL COMPLY FULLY WITH THE REQUIREMENTS OF MIOSHA, OTHER REGULATORY AGENCIES AND THE OWNER'S SITE-SPECIFIC SAFETY PLAN AND REGULATIONS FOR SAFETY PROVISIONS.
- 4. BOTTOM OF FOOTING ELEVATIONS NOTED ON PLAN ARE MINIMUM ELEVATIONS. IN ALL CASES, FOOTINGS ARE TO BEAR ON UNDISTURBED NATURAL SOILS OR ENGINEERED FILL HAVING A MINIMUM GROSS ALLOWABLE BEARING CAPACITY OF 3000 PSF.
- 5. FOOTINGS SHALL BE CENTERED UNDER COLUMNS AND WALLS UNLESS SPECIFICALLY DETAILED OTHERWISE ON THE DRAWINGS.
- 6. NO FOOTINGS OR SLABS SHALL BE PLACED ON OR AGAINST SUB-GRADE CONTAINING FREE WATER, FROST OR ICE. SHOULD WATER OR FROST, HOWEVER SLIGHT, ENTER A FOOTING EXCAVATION AFTER SUB-GRADE APPROVAL, THE SUB-GRADE SHALL BE RE-INSPECTED BY THE TESTING LABORATORY AFTER REMOVAL OF WATER OR FROST.
- 7. THE CONTRACTOR SHALL PROVIDE ALL NECESSARY MEASURES TO PREVENT ANY FROST OR ICE FROM PENETRATING ANY FOOTING OR SLAB SUB-GRADE BEFORE AND AFTER PLACING OF CONCRETE UNTIL THE CONCRETE HAS REACHED ITS' DESIGN STRENGTH.
- 8. ALL FOUNDATION BEARING SOILS SHALL BE INSPECTED BY A QUALIFIED GEOTECHNICAL ENGINEER. THE TESTING SHALL INCLUDE, BUT NOT BE LIMITED TO, IDENTIFICATION OF SOILS AT AND BELOW THE FOUNDATION BEARING LEVEL, AND THE ALLOWABLE BEARING CAPACITY.
- 9. CONTRACTOR SHALL FURNISH ALL REQUIRED DEWATERING EQUIPMENT TO MAINTAIN A DRY EXCAVATION UNTIL BACKFILL IS COMPLETE.
- 10. THE FOUNDATION DESIGN IS BASED ON THE SOILS INVESTIGATION REPORT PREPARED BY PROFESSIONAL SERVICE INDUSTRIES, INC. DATED APRIL 26, 1993

BACKFILLING

- 1. MATERIAL FOR BACKFILL OR ENGINEERED FILL REQUIRED TO ACHIEVE DESIGN GRADES SHOULD CONSIST OF NON-ORGANIC SOILS. THE ON-SITE SOILS THAT ARE FREE OF ORGANIC MATTER AND DEBRIS MAY BE USED FOR ENGINEERED FILL WITH ENGINEER'S APPROVAL.
- 2. BACKFILL MATERIAL SHALL BE COMPACTED TO 95% OF ITS' MAXIMUM DENSITY AS DETERMINED BY THE MODIFIED PROCTOR METHODS (ASTM D1557), IN LIFTS NOT EXCEEDING 12-INCHES IN LOOSE THICKNESS.
- 3. FROZEN MATERIAL SHALL NOT BE USED AS FILL, NOR SHALL FILL BE PLACED ON FROZEN SUB-GRADE.
- 4. DO NOT PLACE BACKFILL AGAINST FOUNDATION WALLS UNTIL BASEMENT FLOOR LEVEL AND FIRST FLOOR LEVEL SLABS ARE IN PLACE AND HAVE REACHED 75% OF THEIR SPECIFIED DESIGN STRENGTH. SHORE AND BRACE WALLS AS REQUIRED IF BACKFILLING OPERATIONS ARE TO BE CARRIED OUT PRIOR TO PLACEMENT OF FLOOR SLABS.
- 5. PLACE BACKFILL AGAINST BOTH SIDES OF GRADE BEAMS AND FOUNDATIONS AT EQUAL ELEVATIONS OF FILL, EXCEPT AS SHOWN ON THE DRAWINGS.
- 6. CRUSHED SLAG USED AS BACKFILL SHALL BE AGED, ENVIRONMENTALLY-SAFE PROCESSED BLAST FURNACE SLAG.

CAST-IN-PLACE CONCRETE

- 1. ALL CONCRETE WORK SHALL CONFORM TO THE REQUIREMENTS OF ACI 301- LATEST REVISION, "SPECIFICATIONS FOR STRUCTURAL CONCRETE FOR BUILDING", EXCEPT AS MODIFIED BY STRUCTURAL REQUIREMENTS NOTED ON THE DRAWINGS.
- 2. ALL CONCRETE SHALL HAVE A MINIMUM 28-DAY COMPRESSIVE STRENGTH (f 'c) OF 4000 psi.
- 3. ALL EXTERIOR CONCRETE INCLUDING WALLS SHALL BE AIR-ENTRAINED 5% +/- 1%.
- 4. ALL EXTERIOR CONCRETE EXPOSED TO WEATHER SHALL HAVE A MAXIMUM WATER TO CEMENT RATIO OF (W/C) 0.45.
- 5. UNLESS NOTED OTHERWISE, MINIMUM CONCRETE COVER SHALL BE CONCRETE CAST AGAINST EARTH CONCRETE EXPOSED TO EARTH OR WEATHER CONCRETE NOT EXPOSED TO EARTH OR WEATHER
- 6. ALL REINFORCING SHALL BE DEFORMED BARS CONFORMING TO ASTM A615 GRADE 60 (fy = 60,000 psi)
- 7. WELDED WIRE FABRIC SHALL BE FURNISHED IN FLAT SHEETS AND SHALL CONFORM TO ASTM A185 (FY = 75 KSI) AND HAVE A MINIMUM SIDE AND END LAP OF 8 INCHES.
- 8. THE CONTRACTOR SHALL SUBMIT THE CONCRETE MIX DESIGN(S) TO THE ENGINEER FOR REVIEW. PROPORTION MIX DESIGNS AS DEFINED IN ACI 301 SECTION 4. THE SUBMITTAL SHALL INCLUDE AS A MINIMUM CEMENT TYPE AND SOURCE, CEMENT CUBE STRENGTH, AGGREGATE GRADATIONS, WATER TESTS, AD-MIXTURE CATALOG INFORMATION AND CYLINDER STRENGTH TEST RESULTS FOR THE CONCRETE. THE MIX DESIGN HISTORICAL RESULTS SHALL ALSO BE SUBMITTED IF APPROPRIATE.
- 9. ALL REINFORCEMENT TO BE DETAILED, FABRICATED AND ERECTED ACCORDING TO THE ACI STANDARDS: "DETAILS AND DETAILING OF CONCRETE REINFORCEMENT", ACI 315 - LATEST REVISION AND "MANUAL OF ENGINEERING AND PLACING DRAWINGS FOR REINFORCED CONCRETE STRUCTURES", ACI 315R - LATEST EDITION.
- 10. THE CONTRACTOR SHALL PREPARE AND SUBMIT REINFORCEMENT SHOP DRAWINGS TO THE ENGINEER FOR REVIEW PRIOR TO FABRICATION. THE SHOP DRAWINGS SHALL CLEARLY SHOW ALL REINFORCEMENT LENGTHS AND BENDS, LOCATIONS OF ALL BARS, VIBRATION AND CONSTRUCTION JOINTS. THE DRAWINGS SHALL ALSO INDICATE ALL OPENINGS, SLEEVES, CURBS AND CONCRETE DIMENSIONS IN ACCORDANCE WITH ACI 315.
- 11. LAPS, ANCHORAGES AND SPLICES SHALL COMPLY WITH THE REQUIREMENTS OF ACI 318-LATEST EDITION, CHAPTER 25. LOCATIONS AND SPLICES SHALL BE IN ACCORDANCE WITH THE CONSTRUCTION JOINT LOCATIONS, DETAILS AND AS SHOWN ON THE REINFORCING STEEL SHOP DRAWINGS.
- 12. PROVIDE DOWELS OF SAME SIZE AND SPACING AS VERTICAL REINFORCEMENT AT ALL COLUMNS AND WALLS.
- 13. UNLESS OTHERWISE SHOWN OR NOTED, AS A MINIMUM, PROVIDE TWO #5 BARS (ONE EACH FACE) AROUND UNFRAMED OPENINGS IN SLABS AND WALLS. PLACE BARS PARALLEL TO SIDES OF OPENINGS AND EXTEND THEM 24 INCHES BEYOND CORNERS.
- 14. HORIZONTAL WALL REINFORCEMENT SHALL BE CONTINUOUS WITH LAPS COMPLYING WITH THE REQUIREMENTS OF ACI 318-LATEST EDITION CHAPTER 25. UNLESS DETAILED OTHERWISE. CORNER BARS SHALL BE PROVIDED AT ALL CHANGE IN WALL DIRECTIONS AND SHALL BE OF THE SAME SIZE AND SPACING AS THE HORIZONTAL STEEL. EACH CORNER BAR LEG TO PROVIDE A LAP COMPLYING WITH THE REQUIREMENTS OF ACI 318-LATEST EDITION CHAPTER 25. SPLICE UNLESS DETAILED OTHERWISE. EXTEND ALL HORIZONTAL WALLS REINFORCING THROUGH PIERS.
- 15. ALL CONSTRUCTION JOINTS SHALL BE FURNISHED WITH KEYWAY CENTERED ON MEMBERS. WHERE THE SIZE OF KEY IS NOT SHOWN ON THE DRAWINGS, THE KEY DEPTH SHALL BE 10% OF THE CROSS SECTION DIMENSION OF THE MEMBER - MINIMUM 3/4".
- 16. ANCHOR BOLTS (FURNISHED BY STRUCTURAL STEEL CONTRACTOR) SHALL BE SET USING A TEMPLATE TO WITHIN 1/8" TOLERANCE IN ANY PLAN DIRECTION IN PIERS, FOOTINGS AND FOUNDATION WALLS, WITH THE MINIMUM PROJECTION AND EMBEDMENT LENGTHS AS INDICATED ON THE DRAWINGS.
- 17. PROVIDE 3/4" CHAMFER STRIP AT ALL EXPOSED CORNERS OF CONCRETE WALLS AND PIERS.
- 18. LOCATE ALL SLEEVES, OPENINGS, EMBEDDED ITEMS, ETC., AS INDICATED ON THE DRAWINGS. THE CONCRETE CONTRACTOR SHALL CHECK WITH ALL OTHER TRADES TO MAKE SURE THE SLEEVES. OPENINGS AND EMBEDDED ITEMS THAT ARE TO BE PROVIDED AND SET BY THEM ARE IN PLACE PRIOR TO PLACING OF CONCRETE IN THE AREA INVOLVED.
- 19. ALL INTERIOR SLABS ON GRADE SHALL BE PLACED ON A VAPOR BARRIER WITH A MINIMUM OF 4-INCHES CLEAN SAND. MINIMUM REINFORCEMENT SHALL BE IN ACCORDANCE WITH ENGINEERING DATA REPORT CRSI NUMBER 37, "REINFORCING STEEL IN SLAB ON GRADE" OR AS DETAILED. ALL EXTERIOR SLABS ON GRADE SHALL BE PLACED ON A MINIMUM OF 4-INCHES CLEAN SAND. MINIMUM REINFORCEMENT SHALL BE IN ACCORDANCE WITH ACI 318 SECTION 24.4 - SHRINKAGE AND TEMPERATURE REINFORCEMENT, OR AS DETAILED.
- 20. CONTRACTORS SHALL OBTAIN APPROVAL FROM THE ENGINEER, PRIOR TO PLACING OPENINGS OR SLEEVES, NOT SHOWN ON THE DRAWINGS, THROUGH ANY STRUCTURAL MEMBERS, ROOF, WALLS OR FOUNDATIONS. REVIEW ARCHITECTURAL, MECHANICAL AND ELECTRICAL DRAWINGS FOR BASES, OPENINGS, SLEEVES, ANCHORS, INSERTS, CONDUITS, RECESSES AND OTHER DEVICES IN CONCRETE WORK BEFORE CASTING CONCRETE.
- 21. PROVIDE POCKETS OR RECESSES IN CONCRETE WORK FOR STEEL COLUMNS AND BEAMS AS REQUIRED AND / OR AS CALLED FOR IN THE SPECIFICATIONS EVEN IF NOT SHOWN ON THE DRAWINGS. PROVIDE CONCRETE FILL AFTER STEEL ERECTION TO SEAL OPENINGS.
- 22. REFER TO ARCHITECTURAL DRAWINGS FOR SLAB RECESSES AND/OR FLOOR FINISH MATERIALS.
- 23. WELDING OF REINFORCING STEEL IS PROHIBITED UNLESS SPECIFICALLY DETAILED. WELDING SHALL CONFORM TO AWS D1.4 SPECIFICATION, LATEST EDITION.
- 24. CONCRETE CONTRACTOR SHALL INCLUDE IN HIS ESTIMATE ADDITIONAL CONCRETE QUANTITY AS REQUIRED TO COMPENSATE FOR DEFLECTIONS OF METAL DECK AND TO PROVIDE A LEVEL CONCRETE SURFACE. REFER TO STRUCTURAL STEEL AND METAL DECK NOTES FOR ADDITIONAL CONSIDERATIONS.
- 25. THE CONCRETE SHALL BE THOROUGHLY COMPACTED BY VIBRATION SUPPLEMENTED BY SPADING, PUDDLING OR AGITATION, TO PREVENT HONEYCOMBING AND TO ENSURE THE ELIMINATION OF VOIDS. VIBRATION MUST BE DIRECT ACTION IN THE CONCRETE AND NOT AGAINST FORMS OR REINFORCEMENT. HONEYCOMBING, VOIDS AND LARGE AIR POCKETS WILL NOT BE ACCEPTABLE.
- 26. LOCATIONS OF CONTRACTION JOINTS ARE SHOWN ON THE PLAN DRAWING. THE JOINTS SHOWN MAY SERVE AS CONSTRUCTION JOINTS IF CONVENIENT FOR THE CONSTRUCTION SEQUENCE. THE LOCATION OF ANY ADDITIONAL CONSTRUCTION JOINTS PROPOSED BY THE CONTRACTOR SHALL BE SUBJECT TO APPROVAL BY THE ENGINEER. ALL CONCRETE SLABS AND WALLS WITH CONSTRUCTION JOINTS SHALL BE PLACED PER ACI 302.1R.
- 27. THE USE OF WATER-SOLUBLE CHLORIDE ION SHALL NOT BE USED UNLESS APPROVED BY THE ENGINEER. AS AN ALTERNATIVE TO THE ABOVE, THE CONTRACTOR MAY SUBMIT A CONCRETE MIX DESIGN FOR APPROVAL TWO WEEKS PRIOR TO PLACING ANY CONCRETE. THE ALTERNATE MIX DESIGN SHALL BE REVIEWED FOR CONFORMANCE TO '02 UBC.

STRUCTURAL STEEL

- 1. STRUCTURAL STEEL SHALL CONFORM TO THE FOLLOWING ASTM SPECIFICATION: * WIDE FLANGE AND WT SHAPES - A992
 - * HSS RECT. A500 GRADE C (fy = 46 KSI) * HSS ROUND - A500 GRADE C (fy = 42 KSI)
 - * PIPE A53 GRADE B (fy = 35 KSI)
 - * HP SHAPES A572 GR. 50 * ALL OTHER SHAPES AND PLATES - A36
- 2. THE FABRICATOR/ERECTOR SHALL SUBMIT TO THE ENGINEER FOR REVIEW, ENGINEERED AND CHECKED DRAWINGS SHOWING SHOP FABRICATION DETAILS, FIELD ASSEMBLY DETAILS AND ERECTION DIAGRAMS FOR ALL STRUCTURAL STEEL.
- 3. BEAM CONNECTIONS SHALL BE STANDARD TWO ANGLE WEB CONNECTIONS CAPABLE OF SUPPORTING 50% OF THE ALLOWABLE UNIFORM LOAD FROM THE ALLOWABLE LOADS ON BEAM TABLES IN THE AISC CODE, UNLESS SPECIFICALLY NOTED ON THE DRAWINGS.
- 4. ALL CONNECTIONS NOT SPECIFICALLY DETAILED, SHALL BE DESIGNED AND DETAILED BY THE FABRICATOR. DETAILING SHALL BE PERFORMED USING RATIONAL ENGINEERING DESIGN AND STANDARD PRACTICE IN ACCORDANCE WITH THE CONTRACT DOCUMENTS. THE GENERAL DETAILS SHOWN ON THE DRAWINGS ARE APPROXIMATE ONLY AND DO NOT INDICATE THE REQUIRED NUMBER OF BOLTS OR WELD SIZES, UNLESS SPECIFICALLY NOTED.
- 5. ALL CONNECTIONS SHALL BE SHOP WELDED IN ACCORDANCE WITH LATEST AWS SPECIFICATION USING E70XX ELECTRODES AND FIELD BOLTED WITH ASTM A325 OR A490 BOLTS. ALL A325 AND A490 BOLTS ARE TO BE INSTALLED IN ACCORDANCE WITH THE LATEST "SPECIFICATION FOR STRUCTURAL JOINTS USING HIGH STRENGTH BOLTS."

3-INCHES 2-INCHES 3/4-INCHES

STRUCTURAL STEEL (CONT.)

- 6. EXCEPT AS NOTED ON THE DRAWINGS, STRUCTURAL STEEL BOLTS SHALL BE ASTM A325, 3/4" DIAMETER. ALL VERTICAL BOLTS ARE TO BE INSTALLED "HEAD UP" UNLESS SPECIFICALLY NOTED. IF A BOLT CANNOT BE INSTALLED "HEAD UP", THE THREAD IS TO BE "SPOILED" AFTER THE BOLT HAS BEEN PROPERLY TIGHTENED AND THEN INSPECTED BY THE TESTING AGENCY.
- 7. HIGH STRENGTH BOLT INSTALLATION SHALL CONFORM TO THE REQUIREMENTS OF AISC AND THE "SPECIFICATION FOR STRUCTURAL JOINTS USING HIGH STRENGTH BOLTS." PROVIDE FULLY PRETENSIONED JOINTS AT CONNECTIONS OF BRACING, WHERE BOLTS ARE IN TENSION, ARE SUBJECT TO LOAD REVERSALS OR FATIGUE, AND AT MOMENT CONNECTIONS. PROVIDE SLIP-CRITICAL JOINTS AT CONNECTIONS SUBJECT TO FATIGUE AND LOAD REVERSALS, OVERSIZED HOLES, SLOTTED HOLES AND WHERE SLIP AT THE FAYING SURFACES WOULD BE DETRIMENTAL TO THE PERFORMANCE OF THE STRUCTURE. ALL OTHER CONNECTIONS MAY HAVE SNUG-TIGHTENED CONNECTIONS UNLESS OTHERWISE NOTED.
- 8. ALL SIMPLE SHEAR CONNECTIONS SHALL BE CAPABLE OF END ROTATION PER THE REQUIREMENTS OF THE AISC 360 SECTION J1.2.
- 9. ALL ANCHOR RODS SHALL CONFORM TO ASTM F1554 GR. 36.
- 10. CONTRACTOR SHALL REFERENCE ARCHITECTURAL DRAWINGS FOR MISC. SHAPES AND PLATES WHICH SHALL BE SHOP-WELDED TO THE STRUCTURAL FRAMING SECTIONS TO MINIMIZE FIELD WELDING.
- 11. ALL FLOOR AND ROOF OPENINGS, UNLESS OTHERWISE NOTED, ARE TO BE FRAMED WITH L5X3X1/4 (LLV). VERIFY SIZE AND LOCATION OF ALL OPENINGS WITH THE TRADE INVOLVED.
- 12. PROVIDE L4X4X1/4 SEATS AT COLUMN WEBS, WHERE REQUIRED FOR SUPPORT OF ROOF AND FLOOR DECKS.
- 13. ALL BEAMS SHALL BE FABRICATED WITH THE NATURAL CAMBER UP. PROVIDE CAMBERS AS INDICATED ON THE DRAWINGS.
- 14. ALL STIFFENER PLATES AND BEARING STIFFENERS ARE TO BE PROVIDED IN PAIRS.
- 15. SHEAR CONNECTORS SHALL BE MANUFACTURED BY NELSON STUD WELDING, DIV, OR ENGINEER APPROVED SUBSTITUTE, AND WELDED PER MANUFACTURER'S WRITTEN INSTRUCTIONS.
- 16. ALL STEEL TO RECEIVE ONE SHOP COAT OF PAINT. OMIT PAINT AT HOLES FOR SLIP CRITICAL-TYPE CONNECTIONS, AT STRUCTURAL STEEL TO BE FIREPROOFED, ENCASED OR IN CONTACT WITH CONCRETE, AND ON TOP FLANGE OF BEAMS RECEIVING SHEAR CONNECTORS.
- 17. THE CONTRACTOR SHALL BE RESPONSIBLE FOR THE CONTROL OF ALL ERECTION PROCEDURES AND SEQUENCES WITH RELATION TO TEMPERATURE DIFFERENTIALS, ESPECIALLY WITH RESPECT TO STRUCTURAL STEEL FRAMING INTO CONCRETE WALLS, BEAMS OR COLUMNS.
- 18. PROVIDE TEMPORARY BRACING AS REQUIRED TO ENSURE STABILITY OF THE STRUCTURE UNDER FULL DESIGN LOADS UNTIL THE PERMANENT BRACING IS IN PLACE. CONTRACTOR SHALL PROVIDE NECESSARY SHORING WHERE REQUIRED DURING CONSTRUCTION.
- 19. SHOP AND FIELD TESTING OF WELDS AND OR BOLTS SHALL BE AS FOLLOWS:
- A. ALL WELDS SHALL BE VISUALLY INSPECTED. 5% AT RANDOM SHALL BE MEASURED.
- B. FILLET WELDS FOR BEAM AND GIRDER SHEAR CONNECTION PLATES (10% AT RANDOM) SHALL BE CHECKED BY MAGNETIC PARTICLE IN ACCORDANCE WITH ASTM E709 FOR FINAL PASS ONLY. C. ULTRASONICALLY TEST 100% OF ALL FULL-PENETRATION WELDS IN ACCORDANCE WITH AWS D1.1 -
- SECTION, PART 'F', "ULTRASONIC TESTING (UT) OF GROOVE WELDS".
- D. CHECK BY CALIBRATED TORQUE WRENCH, 25% OF BOLTS IN EACH FULLY PRETENSIONED CONNECTION JOINT OR SLIP-CRITICAL CONNECTION JOINT, BUT NOT LESS THAN TWO (2) BOLTS PER CONNECTION. ULTRASONICALLY TEST 100 % OF ALL PARTIAL-PENETRATION COLUMN SPLICE WELDS IN ACCORDANCE
- WITH AWS D1.1 SECTION, PART 'F', "ULTRASONIC TESTING (UT) OF GROOVE WELDS". CHECK 100% OF CONTINUITY PLATE FILLET WELDS BY MAGNETIC PARTICLE ON LAST LAYERS IN
- ACCORDANCE WITH ASTM E709. G. THE OWNER'S TESTING AGENCY SHALL PERFORM ALL SHOP AND FIELD INSPECTION AND TESTING AS OUTLINED ABOVE.
- H. THE STRUCTURAL STEEL FABRICATOR AND ERECTOR SHALL SCHEDULE ALL WORK TO ALLOW THE ABOVE TESTING REQUIREMENTS TO BE COMPLETED.
- 20. STRUCTURAL STEEL SHALL NOT BE ALTERED IN THE FIELD FROM THAT SHOWN ON THE DESIGN DRAWINGS. MISMATCHED HOLES SHALL BE REAMED TO LARGER DIAMETER AND PROPERLY SIZED BOLTS AND WASHERS USED FOR FINAL HOLE SIZE. CUTTING, BURNING OR WELDING NOT SHOWN ON DESIGN DRAWINGS SHALL NOT BE PERFORMED WITHOUT THE PRIOR WRITTEN APPROVAL OF THE ENGINEER.
- 21. ALL STRUCTURAL STEEL SHALL BE DETAILED, SHOP PRIME PAINTED OR HOT-DIPPED GALVANIZED, PIECE MARKED, FURNISHED, FABRICATED AND ERECTED ACCORDING TO THE AISC "SPECIFICATIONS FOR STRUCTURAL STEEL BUILDINGS", LATEST EDITION AND TO THE AISC "CODE OF STANDARD PRACTICE". HOT DIP GALVANIZED FINISH FOR ALL STEEL MEMBERS EXPOSED TO THE WEATHER.
- 22. NON-SHRINK GROUT SHALL CONFORM TO "CORPS OF ENGINEERS SPECIFICATION FOR NON-SHRINK GROUT", CRD-C 621-LATEST EDITION. GROUT SHALL BE PREMIXED, NON-SHRINK, NON-CATALYZED NATURAL AGGREGATE GROUT FOR: (1) COLUMN LEVELING PLATES, WHICH ARE NOT BOLTED DOWN BEFORE COLUMN ERECTION, (2) ITEMS SET INTO CONCRETE BLOCKOUTS, DEPRESSIONS, OR TOPPINGS, AND (3) OTHER STRUCTURAL LOAD BEARING APPLICATIONS. THE SEVEN-DAY COMPRESSIVE FOR THE SPECIFIED CONSISTENCY SHALL BE AT LEAST, 7,000 PSI PLASTIC, 6,000 PSI FLOWABLE, AND 5,000 PSI FLUID CONSISTENCY.

FABRICATION AND ERECTION

- 1. ALL STRUCTURAL STEEL SHALL BE DETAILED, FABRICATED AND ERECTED IN ACCORDANCE WITH AISC 303-10 "CODE OF STANDARD PRACTICE FOR STEEL BUILDINGS AND BRIDGES".
- 2. ALL HOLES SHALL BE DRILLED OR PUNCHED. NO BURNING OF HOLES WILL BE PERMITTED. SLOTTED HOLES MUST HAVE STRAIGHT AND SMOOTH SIDES.
- 3. HOLES SHALL BE SIZED SUCH THAT THEY ARE $\frac{1}{16}$ LARGER IN DIAMETER THAN THE SPECIFIED FASTENER.
- 4. ALL STRUCTURAL MATERIAL INCLUDING BEAMS, ANGLES AND PLATES TO BE FIELD MEASURED AND FIELD FABRICATED.
- 5. IN PLANNING THE METHOD OF ERECTION AND DISTRIBUTION OF MATERIAL BEFORE AND DURING ERECTION. THE CONTRACTOR SHALL MAKE FULL ALLOWANCE FOR ANY OBSTRUCTIONS ENCOUNTERED WHICH MAY RESULT FROM WORK PERFORMED BY OTHER TRADES, AS WELL AS THE OPERATIONS OF THE OWNER.
- 6. IT SHALL BE UNDERSTOOD THAT THERE WILL BE NO EXTRA CHARGE BY THE CONTRACTOR ON ACCOUNT OF ANY OBSTRUCTIONS NOW ON THE SITE OF THE BUILDING.
- 7. FURNISH AND INSTALL ANY AND ALL NECESSARY TEMPORARY BRACING TO SQUARE AND PLUMB UP ALL WORK, AS REQUIRED, BEFORE BOLTING OR WELDING.
- 8. IN CASES WHERE MEMBERS DO NOT FIT OR HOLES DO NOT MATCH, THE HOLES SHALL BE REAMED OUT AND THE NEXT LARGER SIZE BOLT INSERTED. IF THE CONNECTION REQUIRES NEW HOLES, THEN NEW HOLES SHALL BE DRILLED. NO SUCH CORRECTIONS SHALL BE MADE WITHOUT PRIOR APPROVAL OF THE OWNER'S RESIDENT ENGINEER. BURNING OF HOLES IS STRICTLY PROHIBITED.
- 9. THE CONTRACTOR SHALL BE RESPONSIBLE FOR ALL DAMAGE CAUSED BY THE ERECTION OF STRUCTURAL STEEL AS HEREIN SPECIFIED. THE CONTRACTOR SHALL REIMBURSE THE OWNER ACTUAL COST OF REPAIR AND OR REPLACEMENT.
- 10. THE CONTRACTOR SHALL BE RESPONSIBLE TO REMOVE/DEMOLISH AND PROPERLY DISPOSE OF EXISTING STEEL, AS REQUIRED FOR THE INSTALLATION OF NEW STEEL.
- 11. CONTRACTOR IS RESPONSIBLE TO DESIGN, PROVIDE AND INSTALL NECESSARY SHORING DURING DEMOLITION AND REPLACEMENT OF STRUCTURAL STEEL. THE SHORING PLAN SHALL BE DESIGNED AND SEALED BY A PROFESSIONAL ENGINEER REGISTERED IN THE STATE OF MICHIGAN.
- 12. TEMPORARILY SUPPORT ALL EXISTING UTILITIES IN WORK AREA AS REQUIRED TO COMPLETE SCOPE-OF-WORK ITEMS
- 13. PRIOR TO THE COMPLETION OF THE SCOPE OF WORK, INSTALL PERMANENT SUPPORTS TO ALL EXISTING UTILITIES AFFECTED BY WORK AREA AS REQUIRED TO THE SATISFACTION OF THE OWNER.

HANDLING OF STEEL

- 1. WHEN THE STRUCTURAL STEEL IS DELIVERED, IT SHALL BE STACKED OFF THE GROUND. CARE SHALL BE TAKEN IN HANDLING AND STACKING THE MEMBERS TO PREVENT BUCKLING, KINKING OR DISTORTION. RAIL AND CARRIER SHIPMENTS SHALL HAVE SUFFICIENT AND SATISFACTORY DUNNAGE TO PREVENT DAMAGE IN TRANSIT.
- 2. MEMBERS WHICH ARE BENT IN FABRICATION OR IN HANDLING SHALL BE STRAIGHTENED OR REPLACED BEFORE ERECTION.
- 3. ALL DIRT, MUD AND DEBRIS SHALL BE CLEANED FROM STEEL BEFORE ERECTION.

HIGH STRENGTH BOLTS

- WELDING

- 2) SUBMERGED ARC. 4) FLUX-CORED ARC.
- ERECTORS OPTION.

- PERSONNEL.

OPEN WEB JOISTS

OWNER.

PLAN.

METAL DECK

1. HIGH STRENGTH BOLTS, NUTS AND WASHERS SHALL CONFORM TO ASTM DESIGNATION A325 AND SHALL BE USED IN ACCORDANCE WITH "SPECIFICATION FOR STRUCTURAL JOINTS USING HIGH-STRENGTH BOLTS" LATEST REVISION, BY THE RESEARCH COUNCIL ON STRUCTURAL CONNECTIONS.

2. ALL BOLTED CONNECTIONS SHALL USE ONLY STANDARD HOLES; EXCEPT SHORT SLOTS, OVERSIZED HOLES AND LONG SLOTS SHALL BE USED WHERE SPECIFICALLY SHOWN OR CALLED OUT ON THE DESIGN DRAWINGS OR MENTIONED HEREIN. OVERSIZED HOLES, AND SHORT AND LONG SLOTS MUST BE TREATED AS SLIP-CRITICAL TYPE CONNECTIONS. HARDENED WASHERS SHALL BE INSTALLED OVER ALL OVERSIZED HOLES AND SHORT SLOTS IN AN OUTER PLY. A PLATE WASHER OR A CONTINUOUS BAR IS REQUIRED FOR ALL LONG SLOTTED HOLES USED IN AN OUTER PLY.

3. THE TIGHTENING MECHANISM USED SHALL BE THE TURN-OF-THE-NUT METHOD. CONTACT SURFACE SHALL NOT BE PAINTED. IN EACH JOINT OR GROUP OF BOLTS 10% (BUT NOT LESS THAN TWO (2) BOLTS) SELECTED AT RANDOM AND NOT IN UNIFORM PATTERN SHALL BE CHECKED. THIS SHALL BE DONE IN THE PRESENCE OF THE OWNER'S DESIGNATED REPRESENTATIVE. IF BOLTING IS FOUND TO BE INADEQUATE UNDER TEST, ALL BOLTS IN THE DEFECTIVE GROUP SHALL BE CHECKED AT THE CONTRACTOR'S EXPENSE.

1. WELDING SHALL BE IN ACCORDANCE WITH THE AMERICAN WELDING SOCIETY AWS D1.1 - LATEST ADOPTION "STRUCTURAL WELDING CODE-STEEL".

2. FILLER METAL FOR WELDING SHALL BE IN ACCORDANCE WITH SECTION 3, TABLE 3.1., OF THE AWS D1.1 "STRUCTURAL WELDING CODE - STEEL".

3. ALL WELDED JOINTS SHALL BE MADE USING PRE-QUALIFIED WELDS OR QUALIFIED PER SECTION 4 OF THE AWS D1.1 "STRUCTURAL WELDING CODE - STEEL". ALL QUALIFIED JOINTS ARE LIMITED TO THOSE MADE BY THE FOLLOWING WELDING PROCEDURES:

1) MANUAL SHIELDED METAL ARC.

3) GAS METAL ARC (EXCEPT SHORT CIRCUITING TRANSFER).

4. ALL FIELD WELDING SHALL BE PERFORMED USING THE MANUAL SHIELDED METAL ARC PROCESS OR FCAW @

5. WELDS, INCLUDING TACK WELDS, SHALL BE MADE ONLY BY WELDERS AND WELDING OPERATORS WHO HAVE BEEN PREVIOUSLY QUALIFIED BY TESTS AS PRESCRIBED BY THE AWS D1.1 "STRUCTURAL WELDING CODE -STEEL" AND HAVE CURRENT PAPERS FOR THE TYPE OF JOINT, POSITION AND PROCESS TO BE WELDED.

6. CONTRACTOR TO SUBMIT CURRENT WELDER QUALIFICATION PAPERS TO ENGINEER PRIOR TO COMMENCING WELDING OPERATIONS.

7. THE MINIMUM SIZE FILLET WELD SIZE SHALL BE 3/16". THE SIZE AND LENGTH OF ALL FILLETS SHALL BE PROPORTIONED NOT TO LOCALLY OVERSTRESS THE CONNECTED MEMBERS.

8. FILLET WELDS ON CONNECTING ANGLES OR OTHER UNSYMMETRICAL SECTIONS SHALL BE DESIGNED ACCORDING TO THE ACTUAL STRESSES CARRIED BY THE INDIVIDUAL LINES OF WELDING. SHOP DRAWINGS SHALL INDICATE WELDS REQUIRED.

9. BEFORE WELDING MEMBERS TO EXISTING BEAMS OR COLUMNS, THOROUGHLY CLEAN ALL SURFACES TO REMOVE RUST, PAINT, OILS, DIRT OR OTHER FOREIGN MATTER IN THE AREA OF WELD.

10. WHERE WELDING IS USED, THE OWNER MAY DECIDE TO MAKE NON-DESTRUCTIVE TESTS OF THE WELDS USING RADIOGRAPHY, ULTRASONIC, MAGNETIC AND/OR DYE PENETRANT WELD TEST METHODS IN COMBINATION OR SINGULARLY. THE NON-DESTRUCTIVE INVESTIGATION WILL BE PERFORMED BY AN INDEPENDENT TESTING LABORATORY QUALIFIED IN THIS TYPE OF WORK. THE COST OF THIS INVESTIGATION WILL BE ASSUMED BY THE OWNER. THE CONTRACTOR SHALL BE RESPONSIBLE TO PROVIDE ACCESS AS REQUIRED FOR TESTING

11. WELD ACCEPTABILITY SHALL BE BASED ON AWS D1.1-LATEST EDITION "STRUCTURAL WELDING - CODE STEEL" CLAUSE 6. IN THE EVENT THE WELDING IS NOT ACCEPTABLE, THE CONTRACTOR SHALL REMOVE ALL REJECTED WELDS AND REWELD ALL SUCH AREAS. THE CONTRACTOR WILL ASSUME ALL COSTS IN CONNECTION WITH THE REWELDING AND RE-EXAMINATION OF THE REWELDED CONNECTIONS UNTIL THE WELDING IS ACCEPTED BY

1. ALL OPEN WEB STEEL JOISTS SHALL BE DESIGNED, FABRICATED AND ERECTED IN ACCORDANCE WITH THE LATEST "STEEL JOIST INSTITUTE" (SJI) SPECIFICATIONS.

WHERE NOTED, JOISTS SHALL BE DESIGNED FOR ADDITIONAL CONCENTRATED LOADS AND MOMENTS INDICATED IN SCHEDULES. SUBMIT DESIGN CALCULATIONS FOR REVIEW BY ARCHITECT-ENGINEER.

3. ALL JOISTS TO RECEIVE ONE COAT OF PAINT OR BE HOT-DIP GALVANIZED PER SPECIFICATIONS.

4. JOIST TO STEEL CONNECTIONS SHALL BE A MINIMUM OF TWO 3/16" FILLET WELDS 1 ½" LONG, EXCEPT AT COLUMNS OR AS REQUIRED TO RESIST LOADS SHOWN ON THE DRAWINGS. AT COLUMNS, JOISTS SHALL BE ATTACHED BY 3/4" DIAMETER BOLTS. JOISTS BEARING ON MASONRY OR CONCRETE SHALL BE FIELD WELDED TO ANCHORED BEARING PLATES, SIZED AS INDICATED.

5. EXTEND JOIST BOTTOM CHORDS AT COLUMNS. CONNECT BOTTOM CHORD AFTER DEAD LOAD IS APPLIED, IF INDICATED AS SUCH ON THE DRAWING. SIZE CONNECTION TO SUIT DETAILED LOADS.

6. MODIFY STANDARD JOIST FOR ADDITIONAL LOADS GIVEN ON PLAN OR FOR THE SPECIAL LOADING DIAGRAMS ON THE DRAWINGS. MODIFY JOIST SEATS WHERE INDICATED.

7. BRIDGING SHALL MEET THE MINIMUM REQUIREMENTS OF SJI UNLESS DETAILED OTHERWISE. HORIZONTAL BRIDGING SHALL BE CONTINUOUS TOP AND BOTTOM, ANCHORED AT EACH END AND WELDED TO EACH JOIST. DIAGONAL BRIDGING SHALL BE BOLTED TO EACH JOIST AND CLAMPED AT THE INTERSECTION WITH THE OPPOSITE BRIDGING.

8. ALL STEEL JOISTS SHALL BE CAMBERED FOR DEFLECTION DUE TO DEAD LOADS OR AS SPECIFICALLY NOTED ON

FOR JOISTS AND SPECIAL JOISTS LIVE LOAD DEFLECTION SHALL NOT EXCEED L/360.

10. FOR POINT LOADS SUPPORTED BY THE JOIST NOT AT THE PANEL POINTS, ADD SUPPLEMENTAL BRACING OR STRUTS IN ACCORDANCE WITH SJI.

1. ALL METAL DECK SHALL BE AS NOTED ON DRAWINGS, FABRICATED AND ERECTED IN ACCORDANCE WITH THE LATEST "STEEL DECK INSTITUTE" (SDI) SPECIFICATIONS.

2. THE CONTRACTOR SHALL FURNISH ALL ACCESSORIES INCLUDING CLOSURES, "Z" CLOSURES, COLUMN CLOSURES, SCREED ANGLES AND GIRDER FILLERS AS REQUIRED.

3. ROOF DECK SHALL HAVE A GALVANIZED COATING CONFORMING TO ASTM A653 - COATING DESIGNATION G-60. 4. DESIGN OF FLOOR DECK AS A FORM SHALL CONFORM TO THE REQUIREMENTS OF SDI SPECIFICATIONS AND COMMENTARIES FOR COMPOSITE STEEL FLOOR DECK, EXCEPT THAT CALCULATED THEORETICAL DEFLECTIONS AS DEFINED UNDER PARAGRAPH 3.3 SHALL NOT EXCEED L/240 OR 1 INCH, WHICHEVER IS SMALLER.

5. THE METAL DECK SHALL BE DESIGNED TO BE CONTINUOUS OVER THREE (3) SPANS MINIMUM IN THE DIRECTION INDICATED. SINGLE AND DOUBLE SPANS, IF REQUIRED, SHALL SATISFY LOAD AND DEFLECTION REQUIREMENTS.

6. COMPOSITE FLOOR DECK SHALL HAVE A GALVANIZED COATING CONFORMING TO ASTM A653 - COATING DESIGNATION G-60.

7. THE FABRICATOR/ERECTOR SHALL PROVIDE ENGINEERING CALCULATIONS, PUBLISHED MANUFACTURER'S DATA AND INDEPENDENTLY CERTIFIED TEST DATA, VERIFYING THE SPECIFIED DECK REQUIREMENTS TO THE ENGINEER FOR REVIEW. PROVIDE ENGINEERING AND CHECKED SHOP DRAWINGS, INDICATING LOCATION, GAGE AND SIZE OF EACH PIECE OF DECKING. THE DRAWING SHALL CLEARLY SHOW WELDING DETAILS TO STRUCTURAL FRAMING AND SIDE LAP CONNECTION DETAILS.

8. ALL NON-CELLULAR METAL DECK SHALL BE WIDE-RIB, SUITABLE FOR SHEAR STUD PLACEMENT WHERE STUDS ARE REQUIRED. THE CONFIGURATION OF THE METAL DECK SHALL BE SUCH AS TO DEVELOP THE FULL SHEAR VALUE OF THE STUD FOR THE PARTICULAR WEIGHTS OF THE CONCRETE AS LISTED IN THE AISC SPECIFICATIONS, LATEST EDITION, THE METAL DECK CONTRACTOR SHALL PROVIDE VERIFICATION OF THE STUD VALUES AND PROVIDE ADDITIONAL STUDS AS REQUIRED.

9. ALL DECKING SHALL BE WELDED TO THE STRUCTURAL STEEL BY QUALIFIED WELDERS USING PRE-QUALIFIED PROCEDURES IN ACCORDANCE WITH AWS D1.1 SECTION 7. LATEST EDITION. THE ERECTOR SHALL ESTABLISH A WELDING PROCEDURE FOR THE STEEL DECKING TO THE STRUCTURAL STEEL FOR THE PARTICULAR GAGE USED. PRIOR TO THE START OF ERECTION OF THE STEEL DECK, EACH WELDER SHALL BE QUALIFIED USING THIS PROCEDURE AS WITNESSED BY THE OWNER'S TESTING AGENCY.



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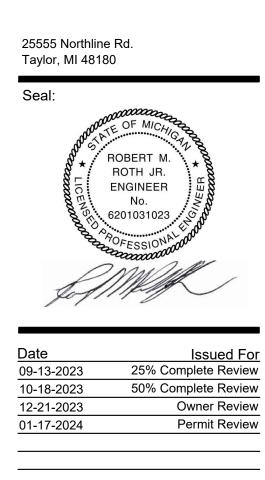


Client:

City of Taylor 23555 Goddard Ro Taylor, MI 48180

Project:

City of Taylor Animal Shelter Remodel & Expansion



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Approved:	MR

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METAL DECK (CONT.)

- 10. ALL METAL DECK SHALL BE WELDED AT 12-INCHES ON CENTER MAXIMUM SPACING TO THE SUPPORTING STEEL WITH A MINIMUM 5/8 INCH DIAMETER PUDDLE WELD. SIDE LAPS SHALL BE FASTENED AT 36-INCHES ON CENTER MAXIMUM SPACING.
- 11. NO LOADS SHALL BE PERMITTED TO BE HUNG FROM ANY ROOF DECK. ALL HANGERS FOR CEILINGS, DUCTWORK, ELECTRICAL CONDUIT, PIPING, ETC. SHALL BE HUNG DIRECTLY FROM STRUCTURAL STEEL WORK OR SUPPLEMENTARY MEMBERS.

12. ALTERNATE PAF OR SCREW FASTENERS ARE ACCEPTABLE ALTERNATES.

MASONRY

- 1. CONCRETE MASONRY UNITS (CMU) SHALL BE LAID WITH TYPE S OR M MORTAR AND ALL MORTAR SHALL CONFORM TO ASTM C270. MORTAR MAY BE EITHER TYPE N OR S U.N.O. - USE PORTLAND CEMENT/LIME FOR MORTAR.
- 2. CONCRETE MASONRY UNIT (CMU) PANELS SHALL HAVE HORIZONTAL JOINT REINFORCEMENT SPACED NOT MORE THAN 16 INCHES ON CENTER, LOCATED IN THE MORTAR BED JOINT, AND EXTENDING THE ENTIRE LENGTH OF THE PANEL, BUT NOT ACROSS EXPANSION JOINTS. LONGITUDINAL WIRES SHALL BE LAPPED A MINIMUM OF 6 IN. AT SPLICES. JOINT REINFORCEMENT SHALL BE PLACED IN THE PANEL. THE REINFORCEMENT SHALL BE PLACED IN THE BED JOINT IMMEDIATELY BELOW AND ABOVE OPENINGS IN THE PANEL. THE REINFORCEMENT SHALL HAVE NOT LESS THAN TWO PARALLEL LONGITUDINAL WIRES OF SIZE W1.7, AND HAVE WELDED CROSS WIRES OF SIZE W1.7.
- 3. CONCRETE MASONRY HAS BEEN DESIGNED IN ACCORDANCE WITH THE TMS 402/ACI 530/ASCE 5 BUILDING CODE REQUIREMENTS FOR CONCRETE MASONRY STRUCTURES AND TMS 602/ACI 530/ASCE 6 SPECIFICATION FOR MASONRY STRUCTURES.
- 4. ALL CONCRETE MASONRY UNITS (CMU) SHALL CONFORM TO ASTM C-90 GRADE N-1. CONCRETE MASONRY TO HAVE 28-DAY COMPRESSIVE STRENGTH FOR AN AVERAGE OF 3 UNITS OF AT LEAST f'm=1900 psi.
- 5. SPECIAL INSPECTION OF MASONRY CONSTRUCTION IS REQUIRED. REFER TO ACI 530, PART 1 AND MICHIGAN BUILDING CODE 2015, TABLE 1705.3 FOR MINIMUM QUALITY ASSURANCE REQUIREMENTS.
- 6. CONCRETE MASONRY UNITS (CMU) SHALL CONFORM TO THE FOLLOWING STANDARDS: HOLLOW LOAD-BEARING UNITS

HOLLOW LOAD-BEARING UNITS.	ASTIVI C90
TYPE I, GRADE N	
SOLID LOAD-BEARING UNITS:	ASTM C145
MEDIUM WEIGHT UNITS:	110 TO 125 PCF
REGULAR WEIGHT UNITS:	135 PCF

- 7. POURABLE CONSISTENCY GROUT SHALL BE USED TO FILL CAVITIES AT BEAM, JOIST AND METAL DECK BEARING, AT VERTICAL FILL OF HOLLOW CORES, AND IN BOND BEAMS AND REINFORCED MASONRY BEAMS, PIERS OR COLUMNS. GROUT SHALL CONFORM TO ASTM C476 WITH MINIMUM 28 DAY COMPRESSION STRENGTH OF 3000 PSI.
- 8. STEEL BAR REINFORCEMENT SHALL CONFORM TO ASTM A615, GRADE 60. HORIZONTAL JOINT REINFORCEMENT SHALL BE LADDER OR TRUSS TYPE.
- 9. VERTICAL CELLS CONTAINING REINFORCING AND GROUT SHALL FORM A CONTINUOUS CAVITY, FREE OF MORTAR DROPPINGS.
- 10. VERTICAL REINFORCING SHALL BE FULLY GROUTED IN THE CORES OF THE CONCRETE MASONRY UNITS AND SHALL BE LAPPED A MINIMUM OF 40 BAR DIAMETERS BUT NOT LESS THAN 24 INCHES. THE VERTICAL REINFORCEMENT SHALL BE LAPPED WITH DOWELS OF SAME SIZE AND SPACING WHICH HAVE BEEN PREVIOUSLY INSTALLED IN THE FOUNDATIONS. EMBEDMENT OF DOWELS SHALL CONFORM TO THE REQUIREMENTS OF ACI 318.
- 11. VERTICAL REINFORCING SHALL BE PLACED IN THE CENTER OF THE CELL, UNLESS SPECIFICALLY SHOWN OTHERWISE. ALLOWABLE SPACING TOLERANCE IS $\pm \frac{1}{2}$ ". THE USE OF REINFORCEMENT BAR POSITIONERS IS REQUIRED.
- 12. GROUTING OF MASONRY WALLS SHALL CONFORM TO THE RECOMMENDED PROCEDURE FOR "LOW LIFT GROUTING" OR "HIGH LIFT GROUTING" AS OUTLINED IN THE NCMA - TEK NOTE #3-2A - GROUTING CONCRETE MASONRY WALLS.
- 13. LIFTS OF GROUT SHALL BE KEYED 4 INCHES INTO THE PREVIOUS COURSE OF MASONRY BELOW.
- 14. SAMPLING AND TESTING OF MORTAR AND GROUT SHALL BE IN ACCORDANCE WITH THE PROCEDURE OUTLINED IN THE NCMA - TEK NOTE #107 LABORATORY AND FIELD TESTING OF MORTAR AND GROUT.
- 15. TESTING OF MASONRY PRISMS SHALL BE IN ACCORDANCE WITH THE PROCEDURE OUTLINED IN THE NCMA-TEK NOTE #18-01B - EVALUATING THE COMPRESSIVE STRENGTH OF CONCRETE MASONRY - 2012 IBC/2011 MSJC.
- 16. HOLLOW MASONRY UNIT SHALL HAVE FACE SHELL BEDDING EXCEPT FOR PIERS, COLUMNS, PILASTERS, THE COURSE IMMEDIATELY ABOVE FDNS, AND WHERE CONTAINMENT OF GROUT OR LOOSE FILL INSULATION REQUIRES THAT WEBS AND FACE SHELLS BE MORTARED. IN FULLY GROUTED OR UNGROUTED MASONRY ONLY THE FACE SHELLS NEED TO BE MORTARED UNLESS OTHERWISE NOTED.
- 17. PROVIDE CONTROL JOINTS IN ABOVE GRADE EXPOSED MASONRY WALLS FOR THE FOLLOWING CONDITIONS:
- A. AT THE PERPENDICULAR WALLS; ONE-HALF CONTROL JOINT SPACING FROM THE CORNERS. B. AT CHANGE IN WALL HEIGHT.
- C. AT CHANGE IN WALL THICKNESS.
- D. AT 25'-0" O.C. IN LONG CONTINUOUS WALLS.

SPECIAL INSPECTIONS & TESTS

SPECIAL INSPECTION SHALL MEET THE REQUIREMENTS OF IBC SECTION 1704. SPECIAL INSPECTOR(S) SHALL BE HIRED BY THE OWNER TO PERFORM THE REQUIRED SPECIAL INSPECTIONS. THE NAMES OF PERSONS OR FIRMS WHO ARE TO PERFORM THE SPECIAL INSPECTIONS SHALL BE FORWARDED TO THE BUILDING OFFICIAL FOR APPROVAL. THE SPECIAL INSPECTOR(S) SHALL COMPLETE AND SUBMIT ALL FORMS REQUIRED BUILDING OFFICIAL.

- THE SPECIAL INSPECTOR(S) SHALL: A. OBSERVE THE WORK ASSIGNED FOR CONFORMANCE TO THE APPROVED DRAWING AND SPECIFICATIONS. B. FURNISH INSPECTION REPORTS TO THE ENGINEER OF RECORD AND BUILDING DEPARTMENT. DISCREPANCIES SHALL BE BROUGHT TO THE IMMEDIATE ATTENTION OF THE CONTRACTOR FOR CORRECTION, THEN, IF NOT
- CORRECTED, TO THE ENGINEER AND THE BUILDING DEPARTMENT. C. SUBMIT TO THE ENGINEER OF RECORD AND THE BUILDING DEPARTMENT A SIGNED FINAL REPORT STATING THAT THE WORK WAS IN CONFORMANCE WITH THE APPROVED DRAWINGS AND SPECIFICATIONS AND THE APPLICABLE WORKMANSHIP PROVISIONS OF THE IBC.

2. SPECIAL INSPECTION NOTES:

- A. CONTINUOUS SPECIAL INSPECTION IS ALWAYS REQUIRED DURING THE PERFORMANCE OF THE WORK UNLESS SPECIFICALLY NOTED BELOW.
- B. WHERE FABRICATION OF THE STRUCTURAL LOAD-BEARING MEMBERS AND ASSEMBLIES IS BEING PERFORMED ON THE PREMISES OF A FABRICATOR'S SHOP, CONTINUOUS SPECIAL INSPECTION IS REQUIRED DURING THE PERFORMANCE OF THE WORK EXCEPT AS ALLOWED IN IBC SECTION 1704.2.5 AND UNLESS SPECIFICALLY NOTED BELOW.
- C. IT IS THE RESPONSIBILITY OF THE CONTRACTOR TO PROVIDE THE SPECIAL INSPECTOR(S) WITH ADVANCE NOTICE, NO LESS THAN ONE WORKING DAY, OF THE INITIATION OF ANY WORK REQUIRED TO HAVE SPECIAL INSPECTIONS. ALL WORK PERFORMED WITHOUT REQUIRED SPECIAL INSPECTION WILL BE SUBJECT TO REMOVAL.
- 3. TYPES OF WORK REQUIRING SPECIAL INSPECTIONS ARE:
- A. STRUCTURAL STEEL ELEMENTS OF BUILDINGS AND STRUCTURES AS REQUIRED BY IBC SECTION 1705.2.1 AND AISC 360 SECTION 'N'. COLD-FORMED STEEL DECK AS REQUIRED BY IBC SECTION 1705.2.2 AND SDI QA/QC.
- OPEN-WEB STEEL JOISTS AND JOIST GIRDERS AS REQUIRED BY IBC SECTION 1705.2.3 AND TABLE 1705.2.3, AS С. FOLLOWS: PERIODIC SPECIAL INSPECTION IN COMPLIANCE WITH SJI SPECIFICATIONS, SECTION 2207.1 FOR INSTALLATION
- OF OPEN-WEB STEEL JOISTS AND JOIST GIRDERS REQUIRED FOR: a. END CONNECTIONS - WELDING OR BOLTED. BRIDGING - HORIZONTAL OR DIAGONAL. APPLIES TO BOTH STANDARD BRIDGING AND BRIDGING THAT b.
- DIFFERS FROM THE SJI SPECIFICATIONS LISTED IN SECTION 2207.1 D. CONCRETE CONSTRUCTION AS REQUIRED BY IBC SECTION 1705.3 AND TABLE 1705.3, AS FOLLOWS: WELDING OF REINFORCING BARS AS REQUIRED BY IBC SECTION 1705.3.1 AND IN COMPLIANCE WITH
- AWS D1.4 FOR SPECIAL INSPECTION AND AWS D1.4 FOR SPECIAL INSPECTOR QUALIFICATION. MATERIAL TESTS AS REQUIRED BY IBC SECTION 1705.3.2 AND ACI 318, CHAPTERS 19 AND 20. b.

	IBC TABLE 1705.3 - REQ'D. SPECIAL INSPECTION OF CONC	. CONSTRU	CTION
	INSPECTION TYPE	CONTINUOUS INSPECTION	
1.	INSPECT REINFORCEMENT, INCLUDING PRESTRESSING TENDONS, AND VERIFY PLACEMENT.		X
2. a.	REINFORCING BAR WELDING: VERIFY WELDABILITY OF REINFORCING BARS OTHER THAN ASTM A706		
а. b. c.	INSPECT SINGLE-PASS FILLET WELDS, MAXIMUM $5_{16}^{\prime\prime}$; AND	x	X X
3.			
4 <u>.</u> a.		X	
b.	ORIENTATIONS TO RESIST SUSTAINED TENSION LOADS. MECHANICAL ANCHORS AND ADHESIVE ANCHORS NOT DEFINED IN 4.a.		x
5.	VERIFY USE OF REQUIRED DESIGN MIX.		X
6.	PRIOR TO CONCRETE PLACEMENT, FABRICATE SPECIMENS FOR STRENGTH TESTS PERFORM SLUMP AND AIR CONTENT TESTS, AND DETERMINE THE TEMPERATURE OF THE CONCRETE.	, X	
7.	INSPECT CONCRETE AND SHOTCRETE PLACEMENT FOR PROPER APPLICATION TECHNIQUES.	x	
8.	VERIFY MAINTENANCE OF SPECIFIED CURING TEMPERATURE AND TECHNIQUES.		x
9. a.	INSPECT PRESTRESSED CONCRETE FOR: APPLICATION OF PRESTRESSING FORCES; AND	x	
b.	GROUTING OF BONDED PRESTRESSING TENDONS.	X	
	INSPECT ERECTION OF PRECAST CONCRETE MEMBERS.		X
11.	VERIFY IN-SITU CONCRETE STRENGTH, PRIOR TO STRESSING OF TENDONS IN POST-TENSIONED CONCRETE AND PRIOR TO REMOVAL OF SHORES AND FORMS FROM BEAMS AND STRUCTURAL SLABS.		x
12.	INSPECT FORMWORK FOR SHAPE, LOCATION AND DIMENSIONS OF THE CONCRETE MEMBER BEING FORMED.		X
•	MASONRY CONSTRUCTION AS REQUIRED BY IBC SECTION 1709 SPECIAL INSPECTIONS OF TMS 402/ACI 530/ASCE 5 AS FOLLOW TMS TABLE 3.1.2 - LEVEL B QUALITY ASSURANCE	S:	EL B
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F. SOILS AS REQUIRED BY IBC 1705.6 AND TABLE 1705.6 AS FOLLOWS: 1. PERIODIC SPECIAL INSPECTION REQUIRED TO: VERIFY MATERIALS BELOW SHALLOW FOUNDATIONS ARE ADEQUATE TO ACHIEVE THE DESIGN a. BEARING CAPACITY. VERIFY EXCAVATIONS ARE EXTENDED TO PROPER DEPTH AND HAVE REACHED PROPER MATERIAL. b PERFORM CLASSIFICATION AND TESTING OF COMPACTED FILL MATERIALS. C. PRIOR TO PLACEMENT OF COMPACTED FILL, INSPECT SUBGRADE AND VERIFY THAT SITE HAS BEEN d. PREPARED.

2. CONTINUOUS SPECIAL INSPECTION REQUIRED TO: VERIFY USE OF PROPER MATERIALS, DENSITIES AND LIFT THICKNESSES DURING PLACEMENT AND а. COMPACTION OF COMPACTED FILL. COMPACTED SOIL BACKFILL IN COMPLIANCE WITH SECTION 1803 SHALL REQUIRE b.

SPECIAL INSPECTIONS IN ACCORDANCE WITH ASTM D1557. b.a.

G. FABRICATED ITEMS AS REQUIRED BY IBC SECTION 1705.10 AND SECTION 1704.2.5.



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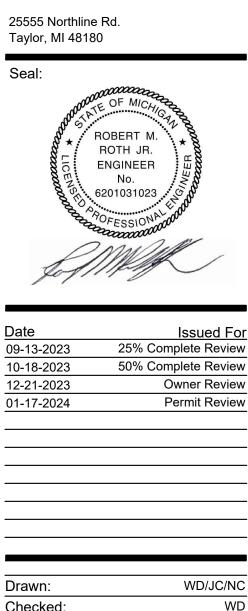
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Client: City of Taylor 23555 Goddard Ro Taylor, MI 48180

Project:

City of Taylor **Animal Shelter** Remodel & Expansion




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STRUCTURAL **GENERAL NOTES**

22712.A Project Number:

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FOUNDATION PLAN

SCALE: 1/8" = 1'-0"

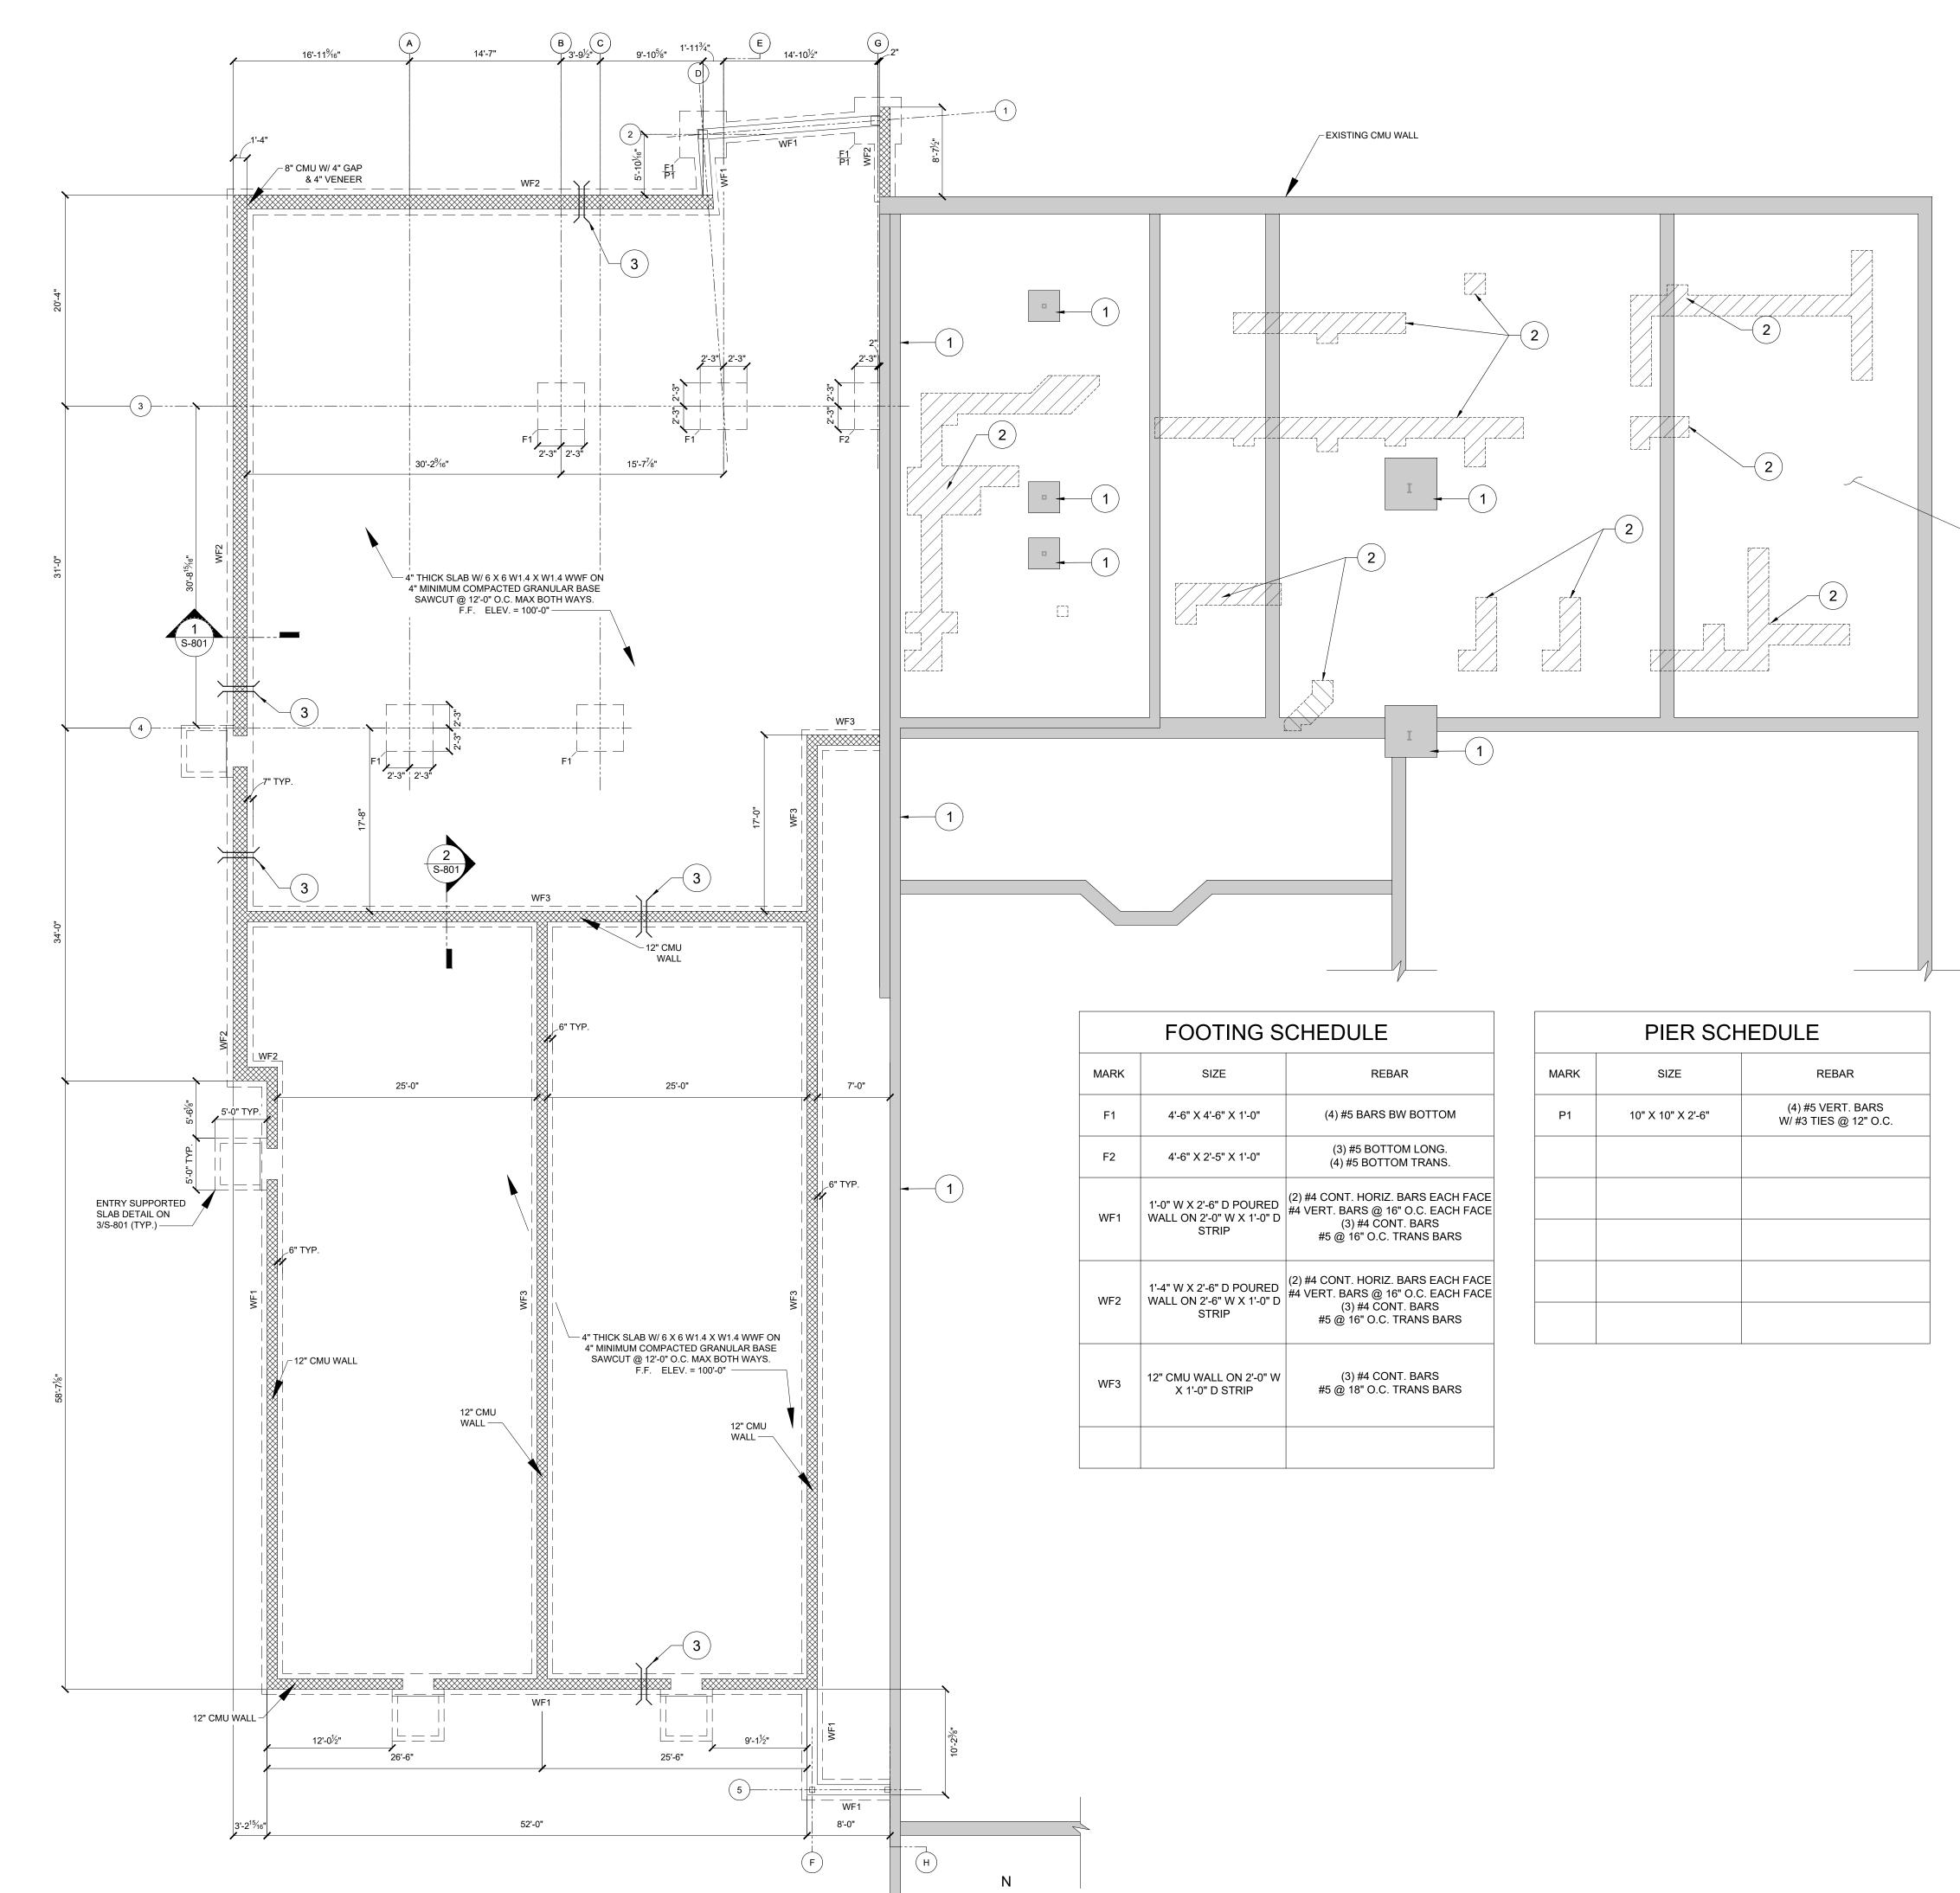(1) S-100

NEW



- 1 EXISTING FOOTINGS
- 2 APPROXIMATE LOCATION AND SIZE OF CONCRETE FLOOR SLAB TO BE REPLACED AS NEEDED AFTER INSTALLING NEW FLOOR DRAINS AND ASSOCIATED PIPING.
- 3 APPROXIMATE LOCATION OF PLUMBING SLEEVE. COORDINATE W/ SITE UTILITIES & PLUMBING PLANS.



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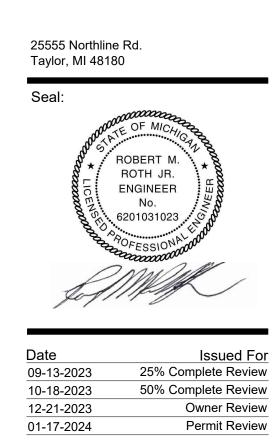
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Project:

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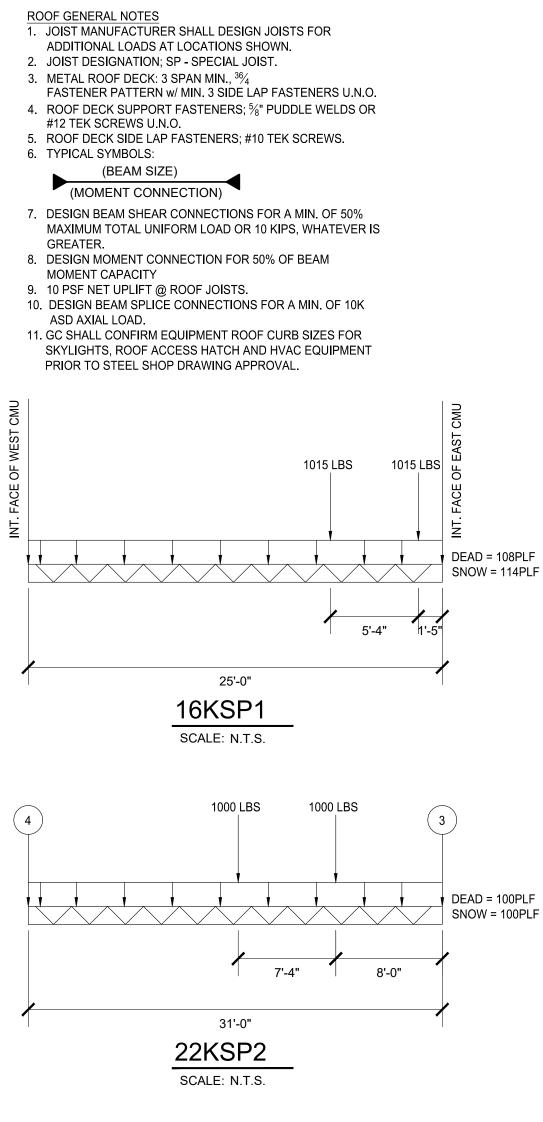
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Approved:	MR

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Project Number: 22712.A

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- EXISTING 4" CONC. SLAB-ON-GRADE




COLUMN SCHEDULE			
	DESCRIPTION	BASEPLATE	ANCHORS

C1 HSS 4" X 4" X 3/1	6" TBD	TBD


BEARING PLATE SCHEDULE

MARK	SIZE	ANCHOF
BP1	11"x7"x ³ / ₈ "	(2) ½"Øx5" S
BP2	7"x7"x⅔	(2) ½"Øx5" S
BP3	7"x12"x¾"	(2) ¹ ⁄₂"Øx5" S

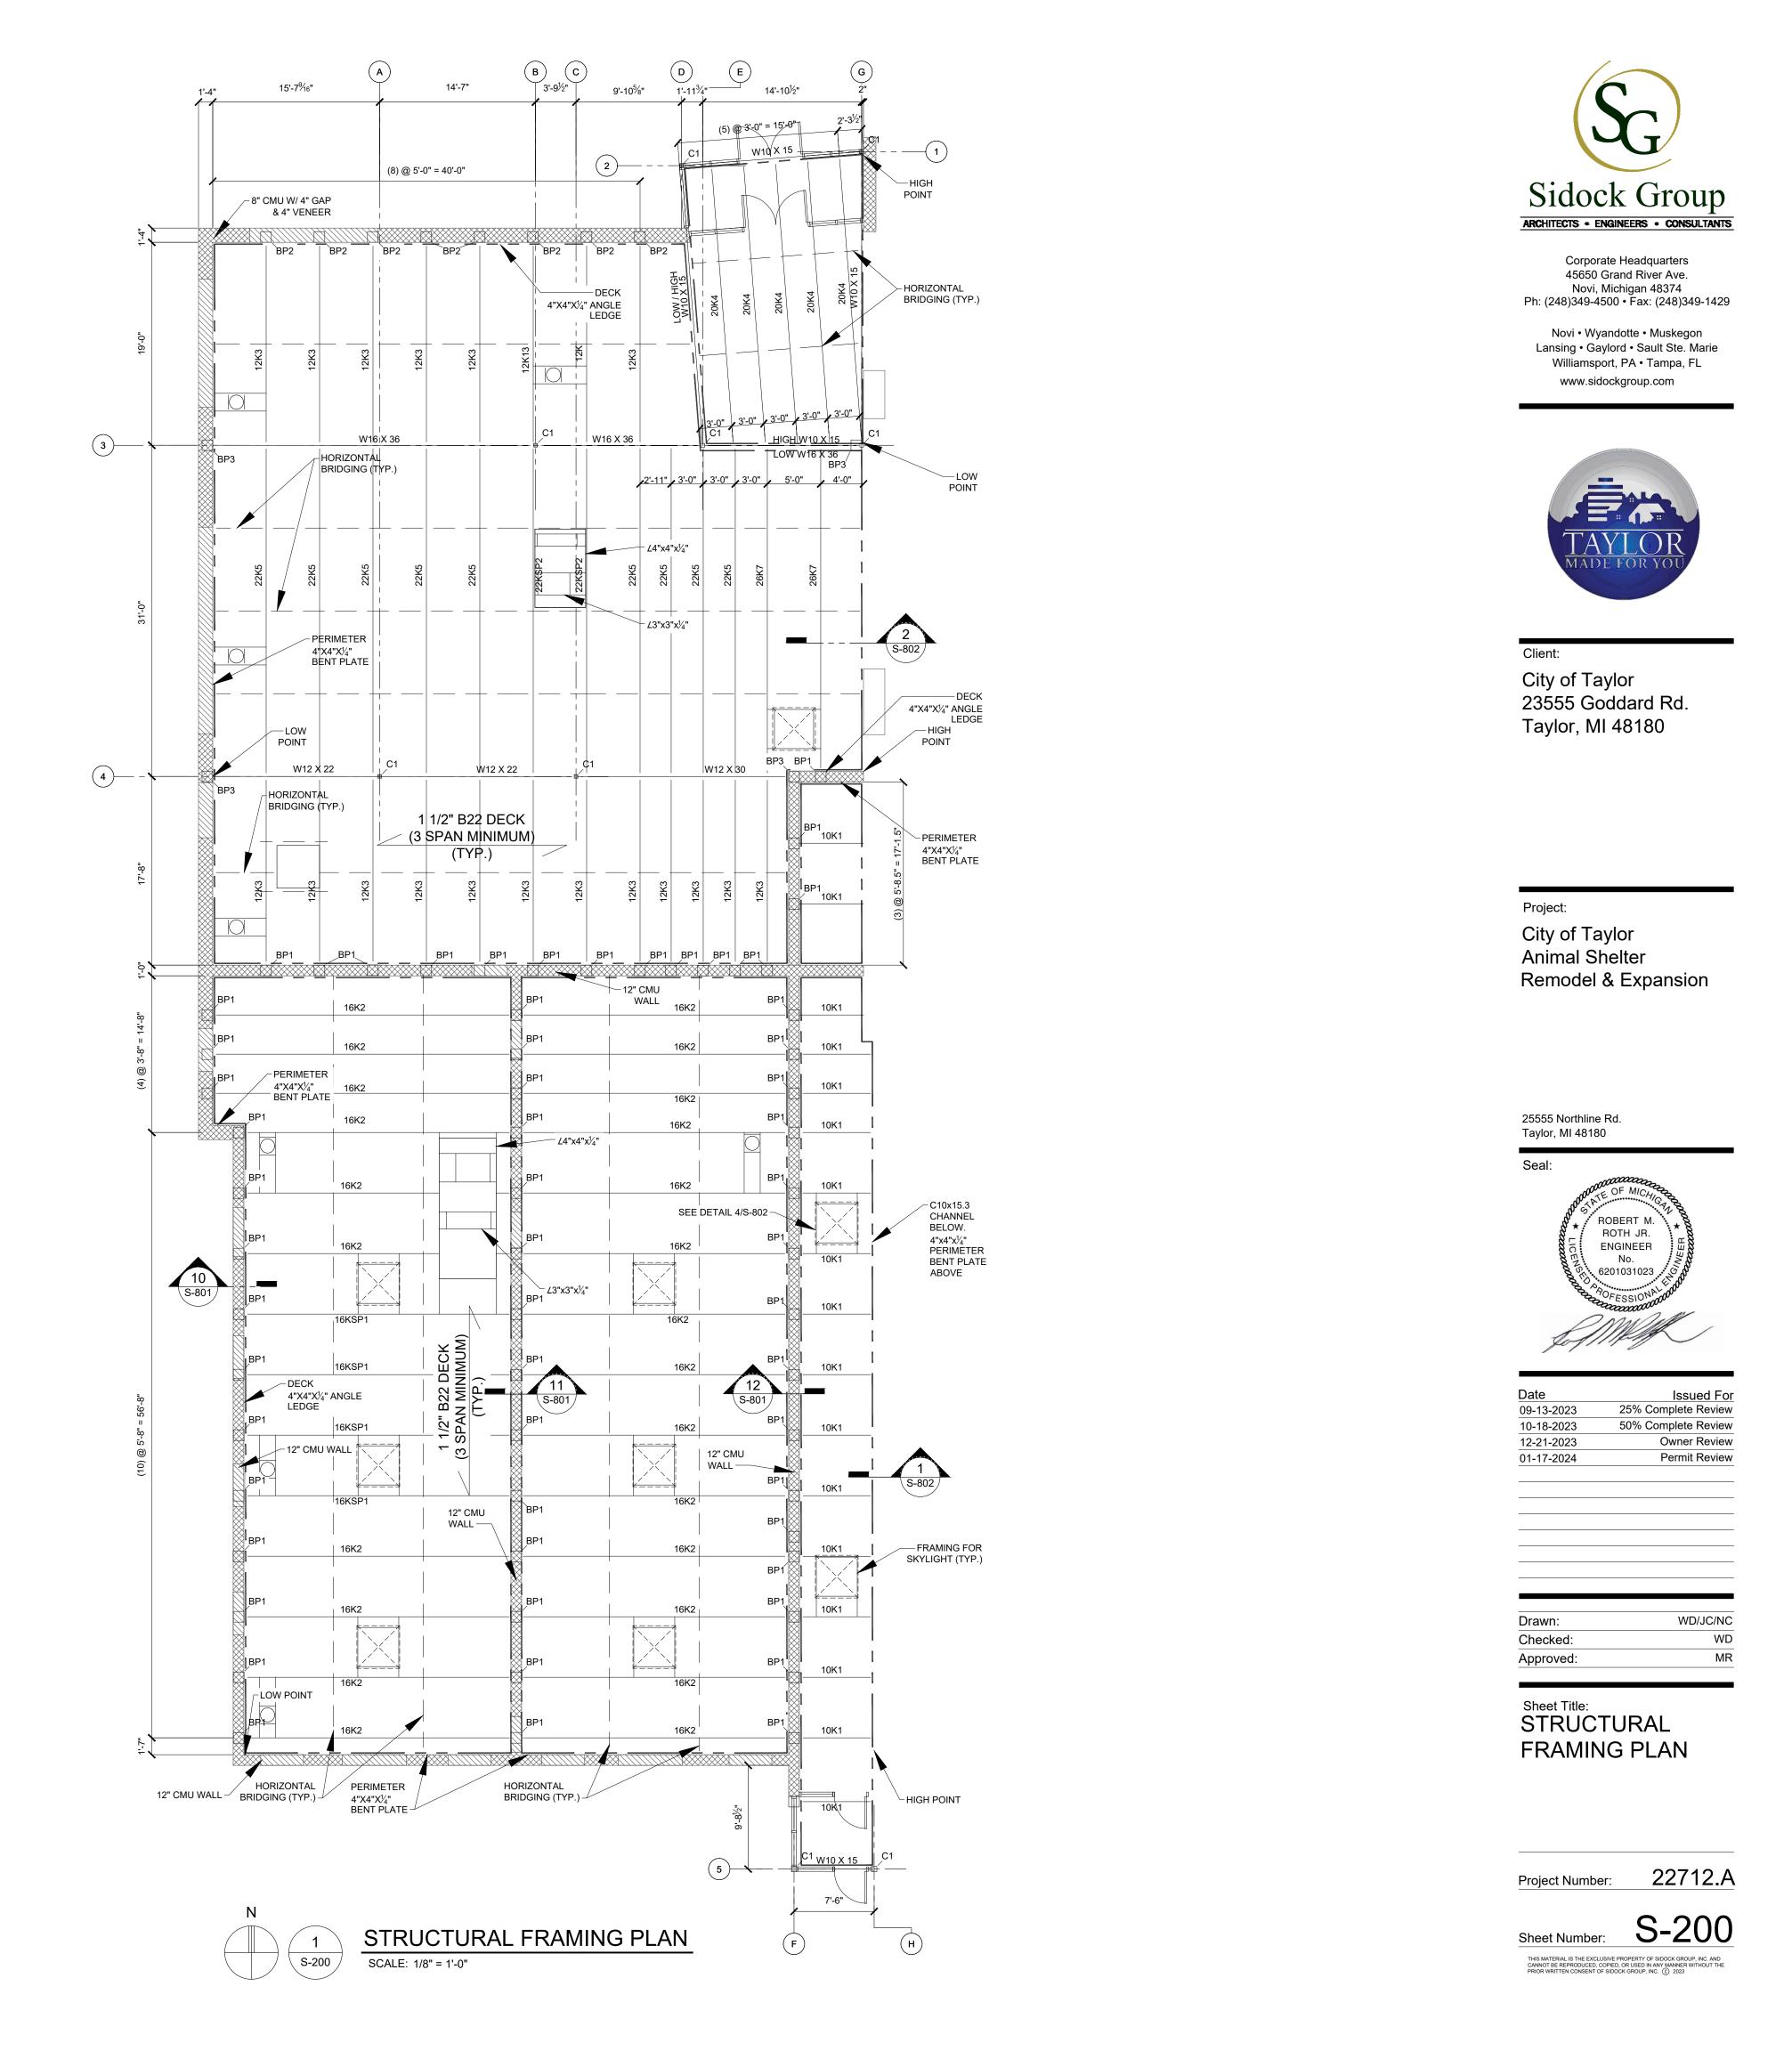

MINIMUM EMBEDMENT TBD

STUDS

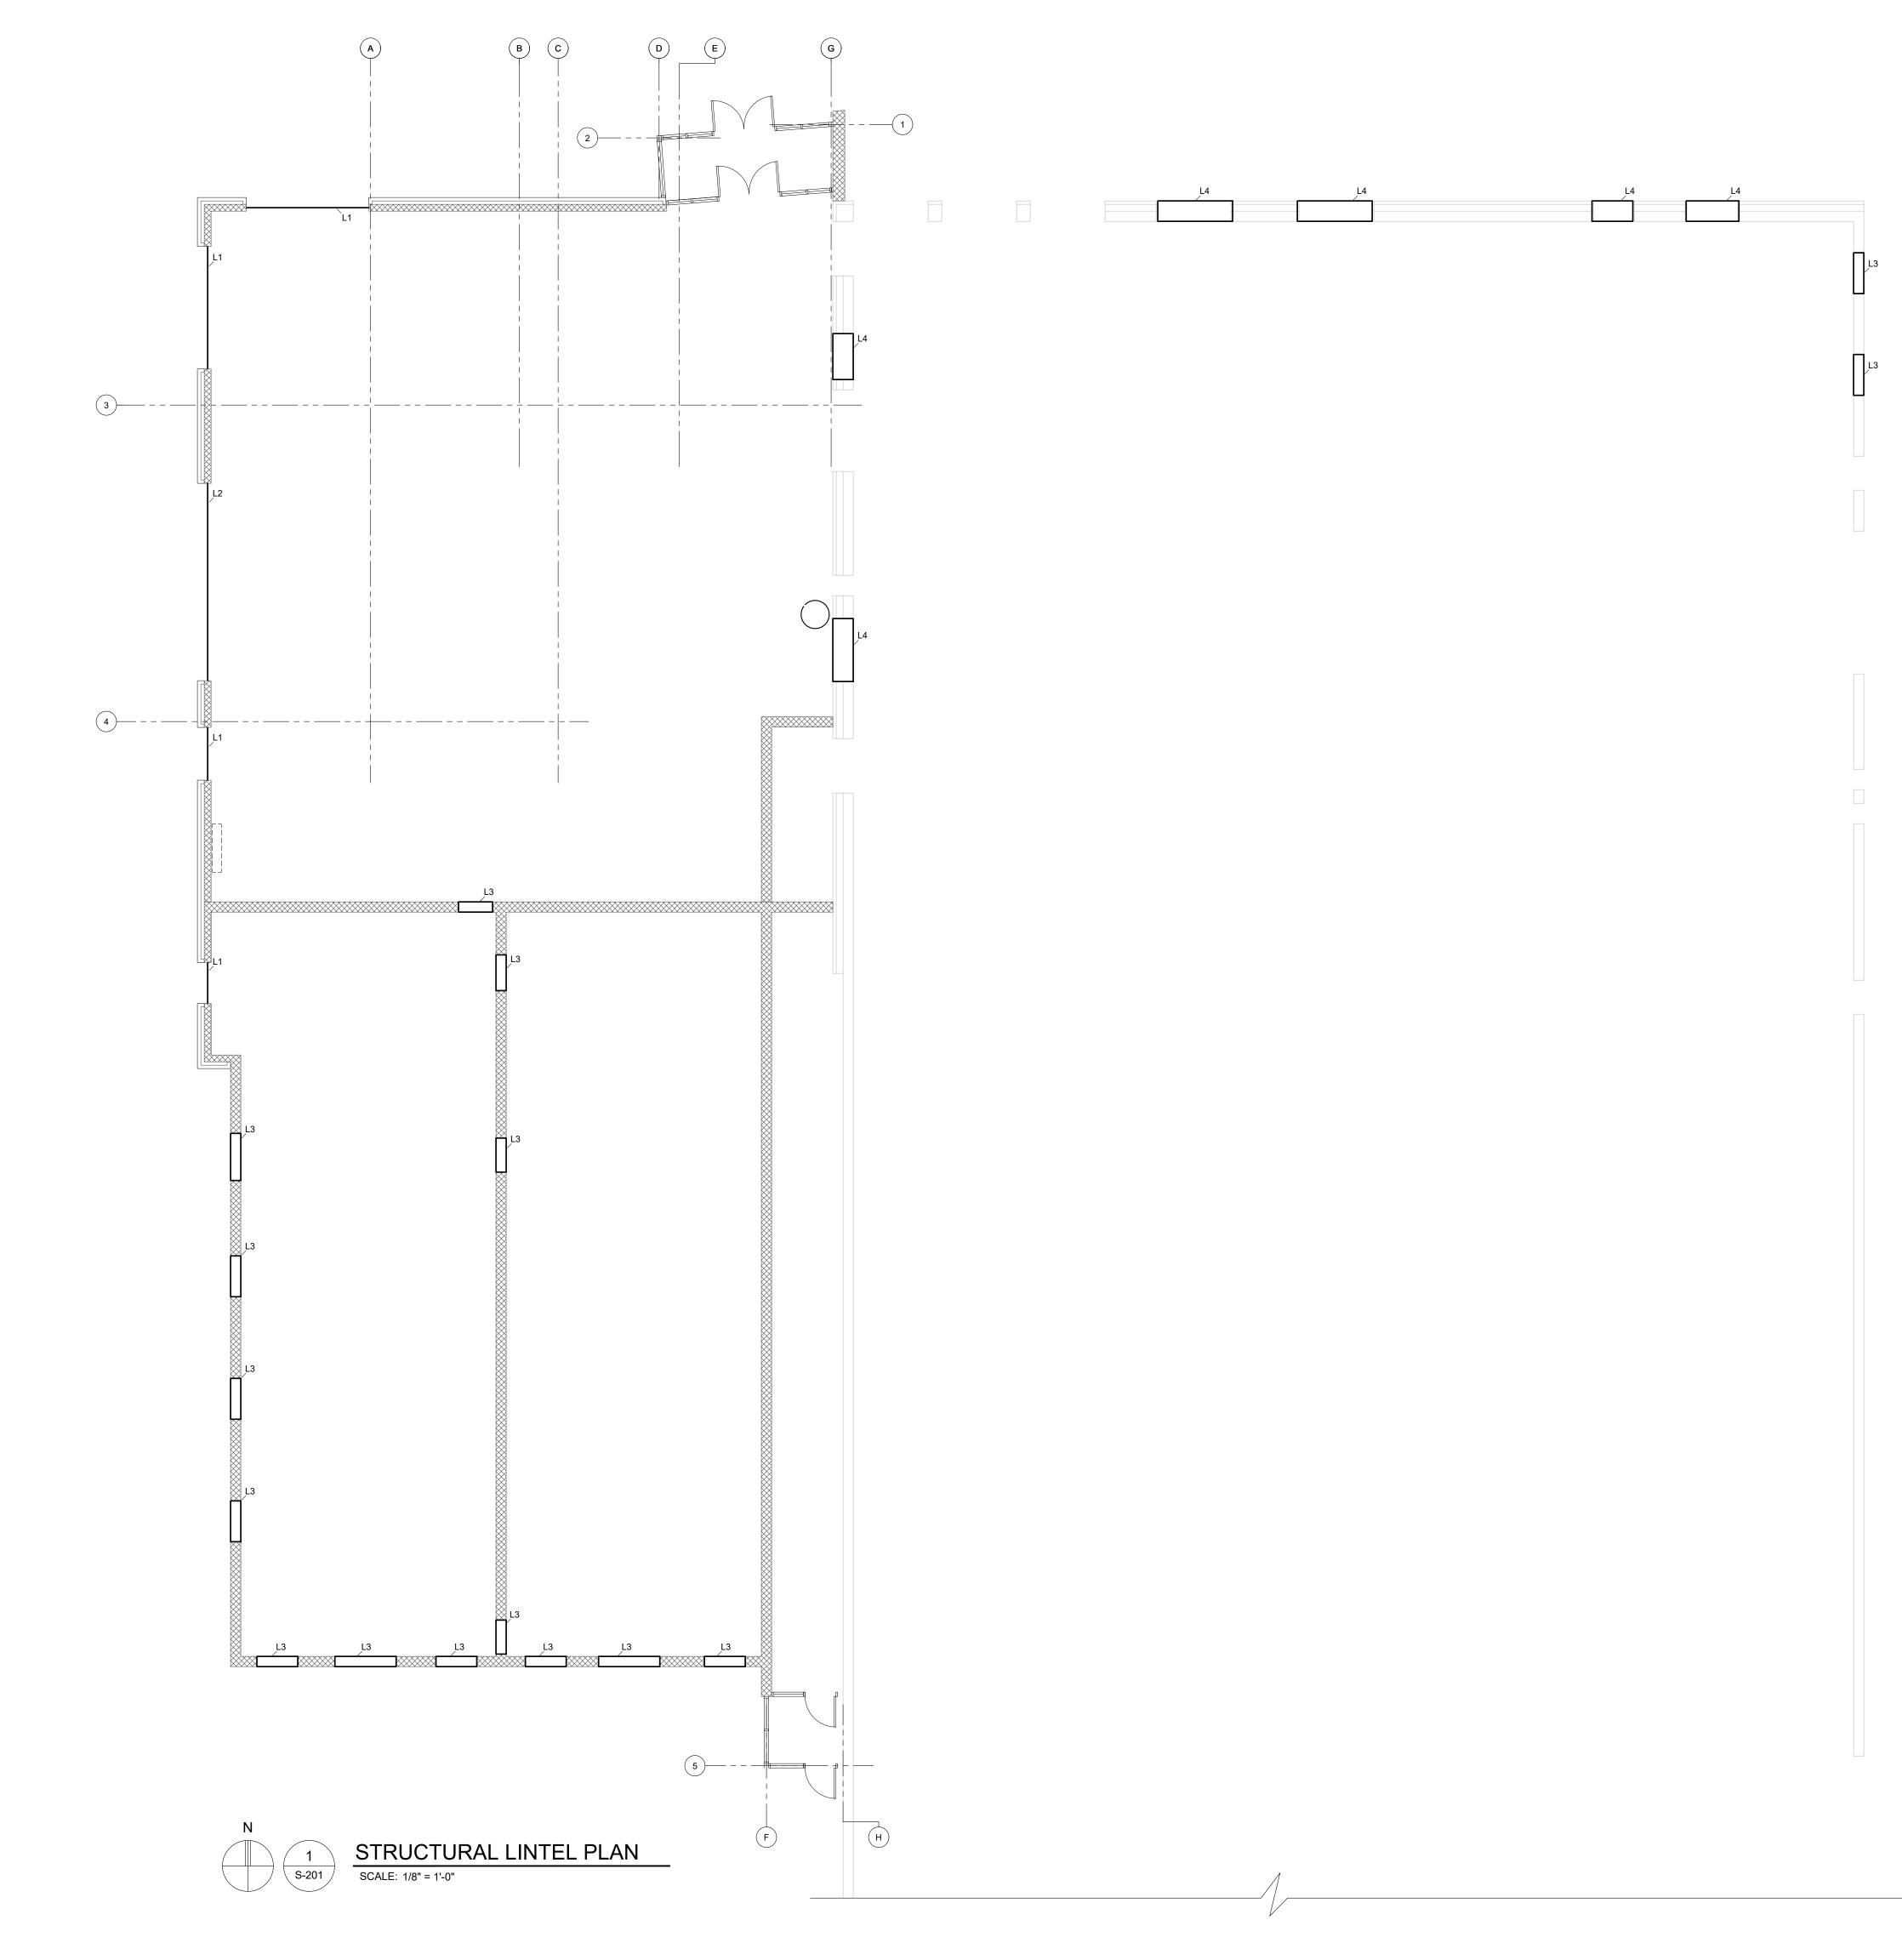



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Client:

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Project:

City of Taylor Animal Shelter Remodel & Expansion

LINTEL SCHEDULE		
MARK	SIZE	
L1	W8x15 W/ 14"x¾" PLATE + ∠3x3x¾ STIFFENERS @ 1'-0" O.C.	
L2	W8x21 W/ 14"x¾" PLATE + ∠3x3x¾ STIFFENERS @ 1'-0" O.C.	
L3	16"D MASONRY LINTEL W/ (2) #5 BARS	
L4	W8x15 W/ 23"x¾" BOTTOM PLATE + 20"x¾" TOP PLATE	

* ALL LINTELS HAVE 8" BEARING

25555 Northline Rd. Taylor, MI 48180 Seal:




ate	Issued For
9-13-2023	25% Complete Review
0-18-2023	50% Complete Review
2-21-2023	Owner Review
1-17-2024	Permit Review


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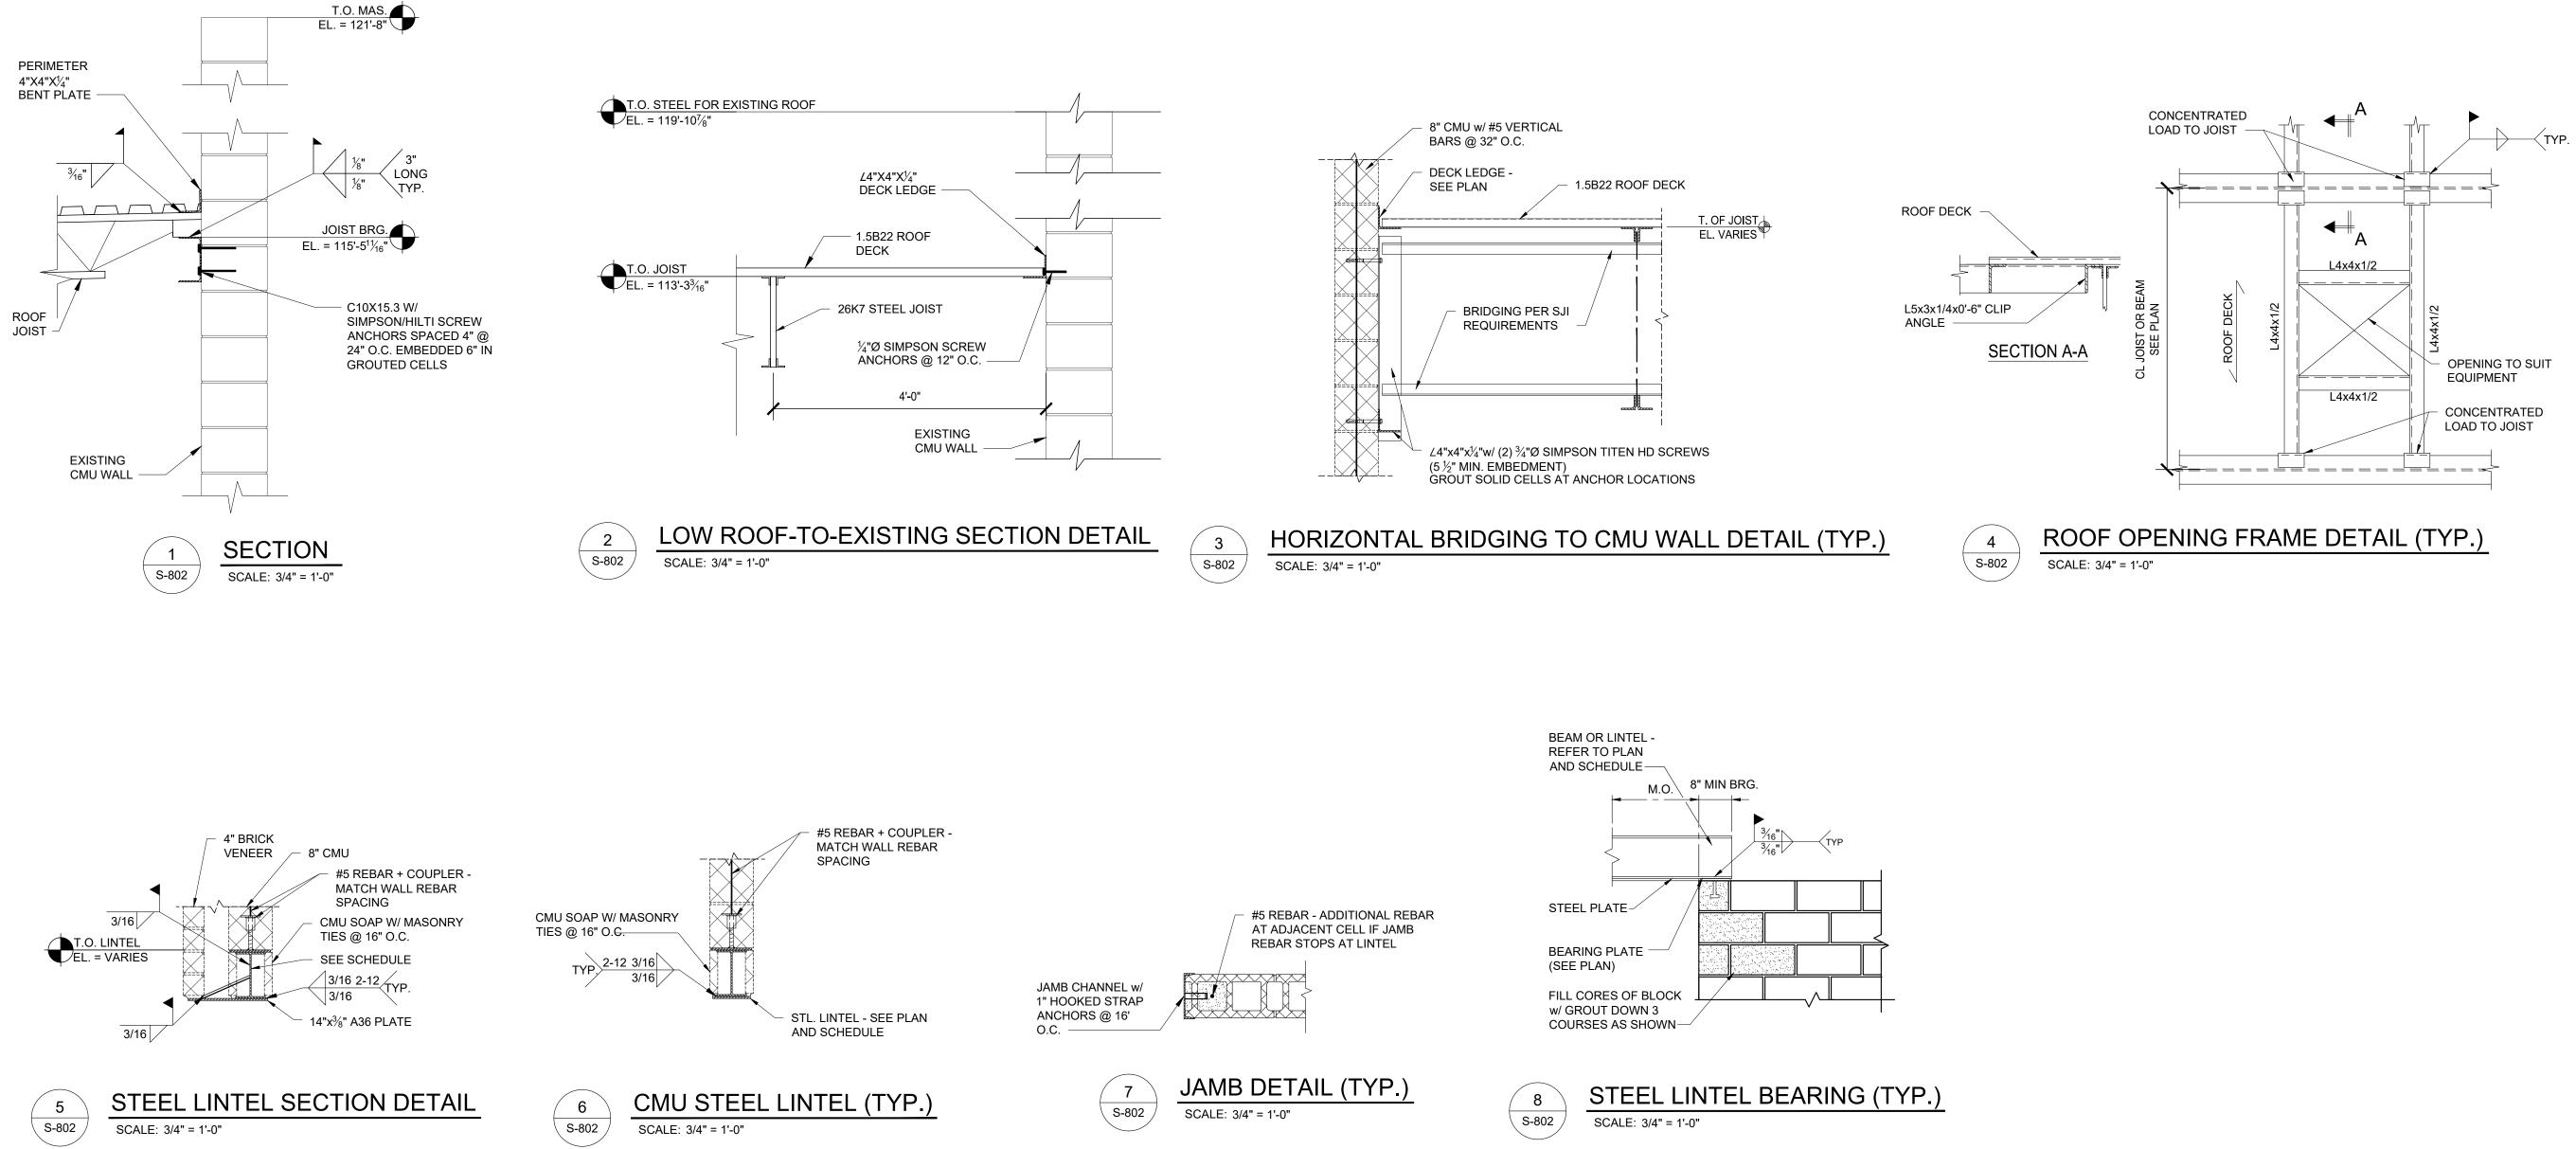
Sheet Title: STRUCTURAL LINTEL PLAN

Project Number: 22712.A Sheet Number: S-201

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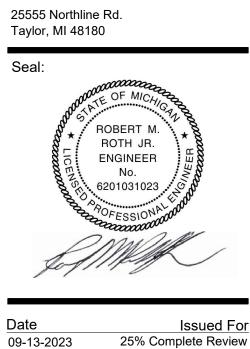
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Client: City of Taylor 23555 Goddard Rd. Taylor, MI 48180

Project:

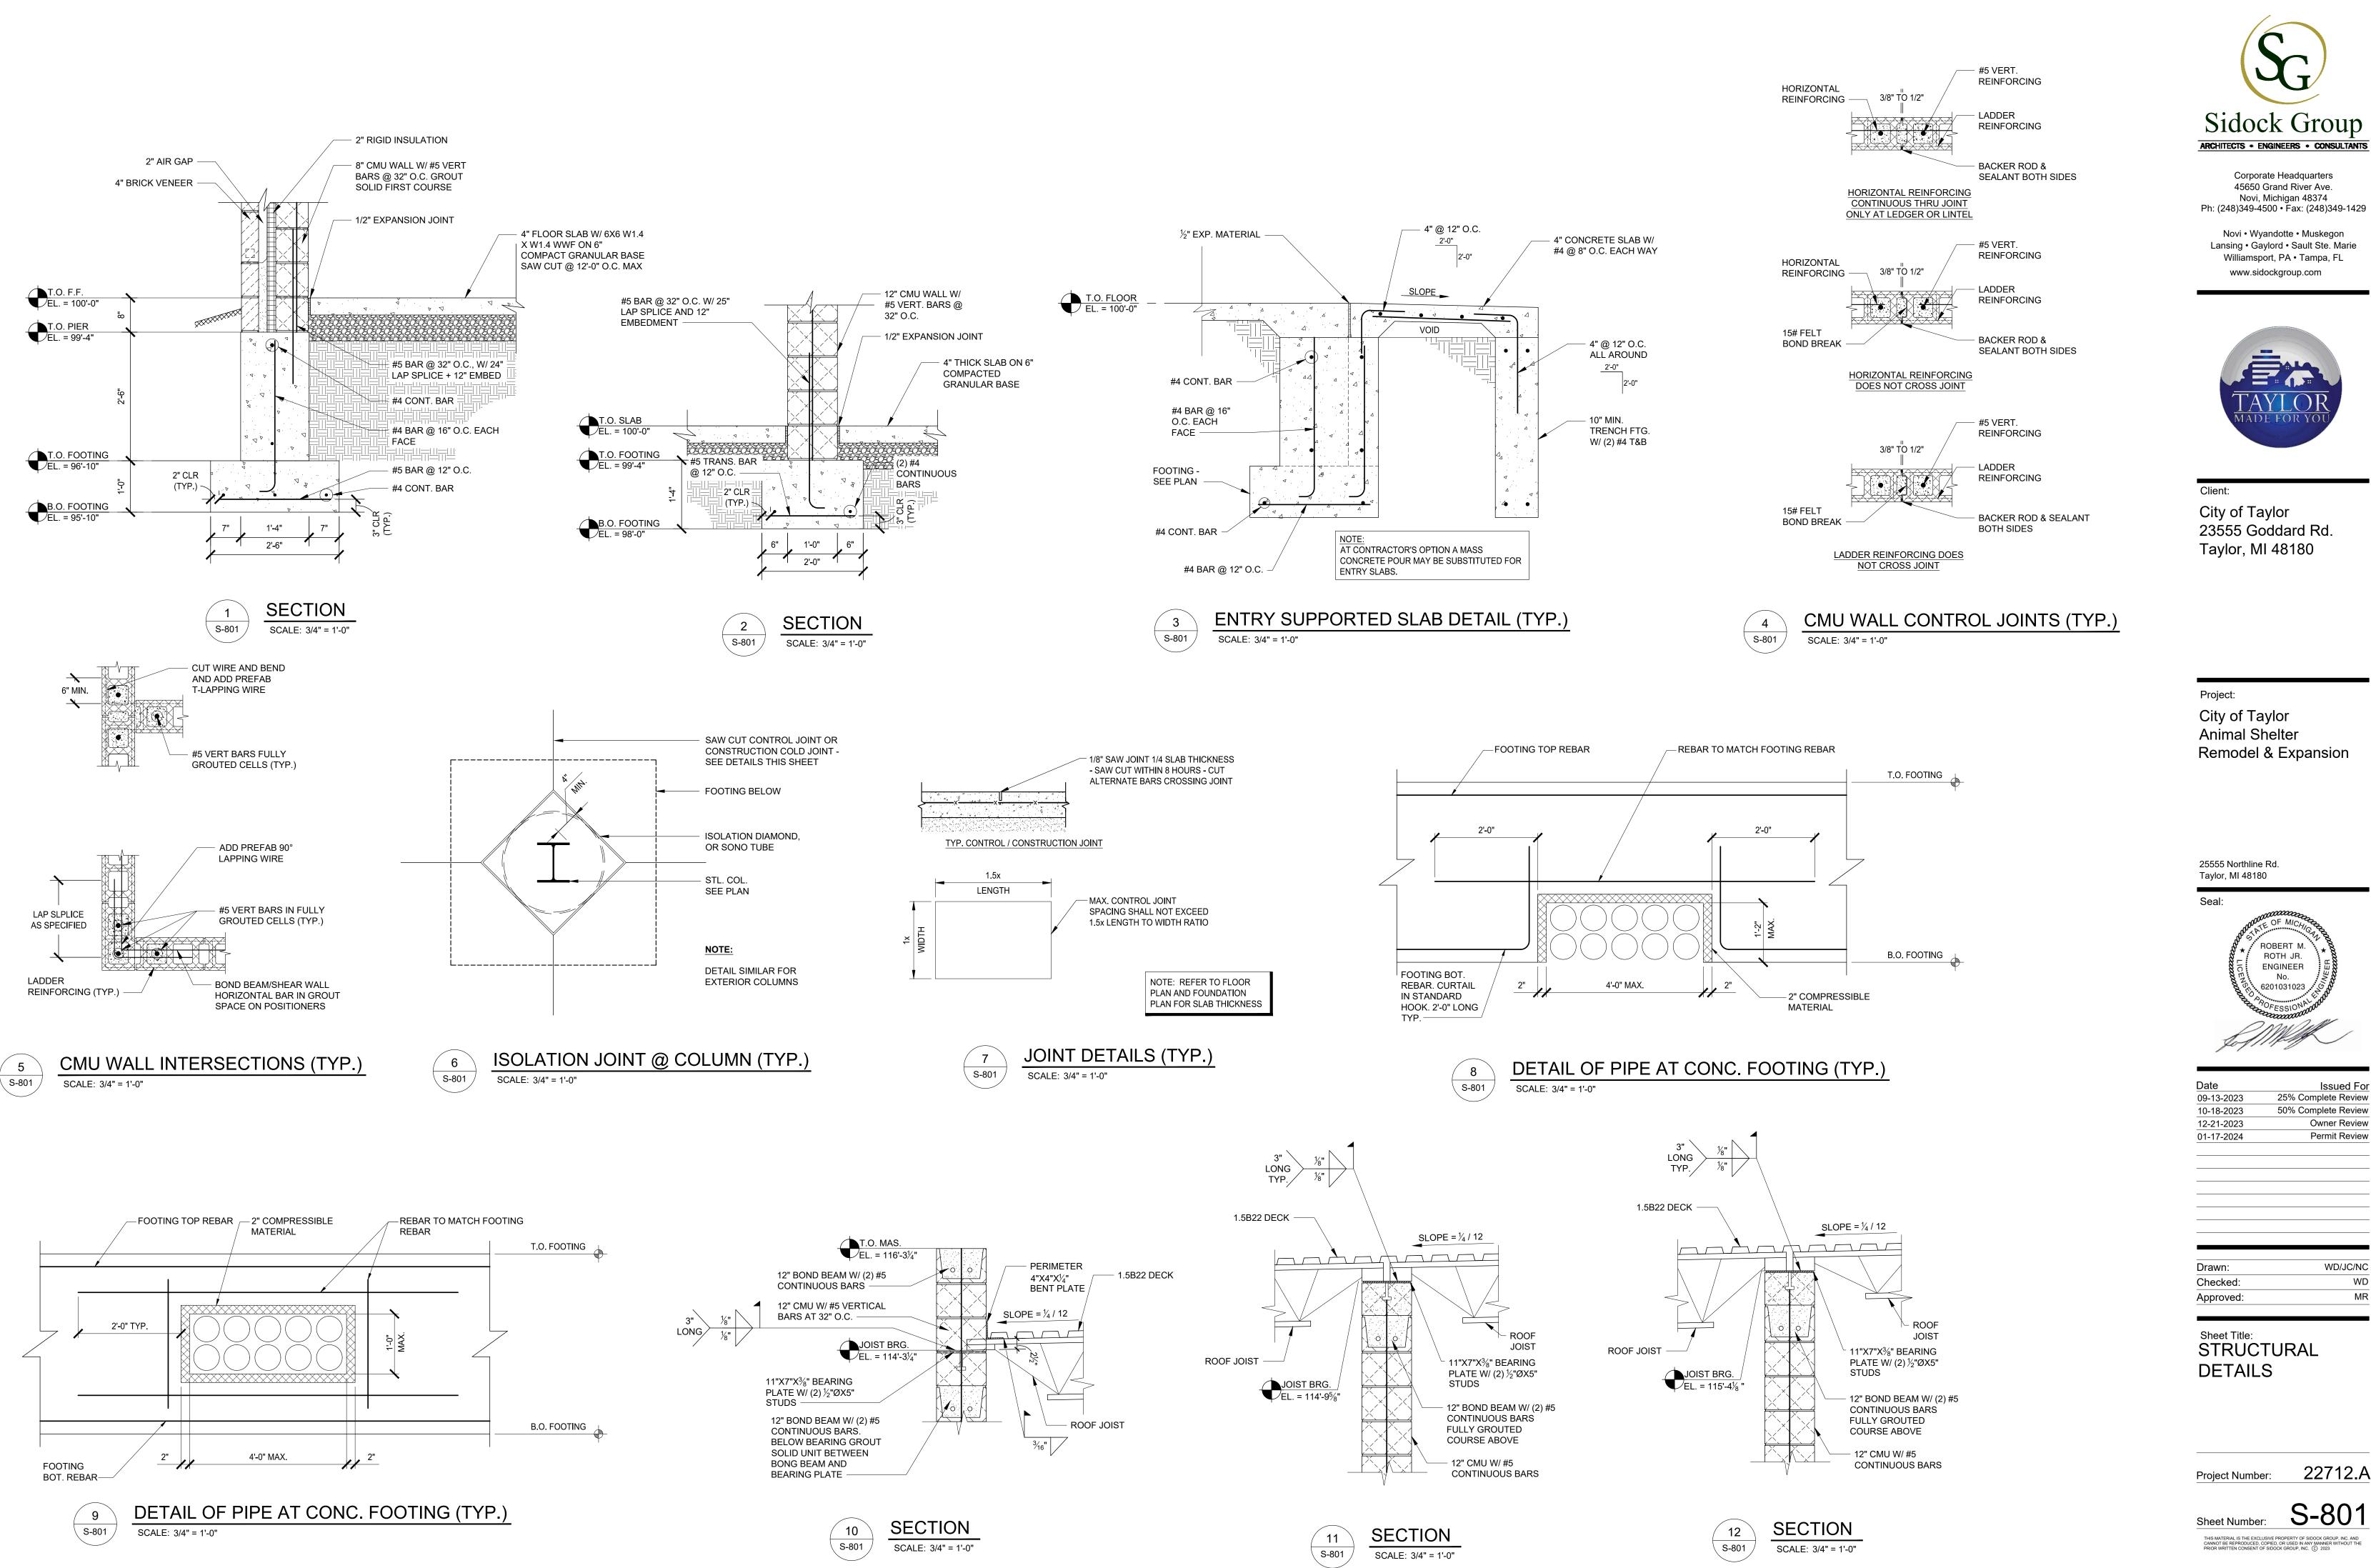
City of Taylor Animal Shelter Remodel & Expansion

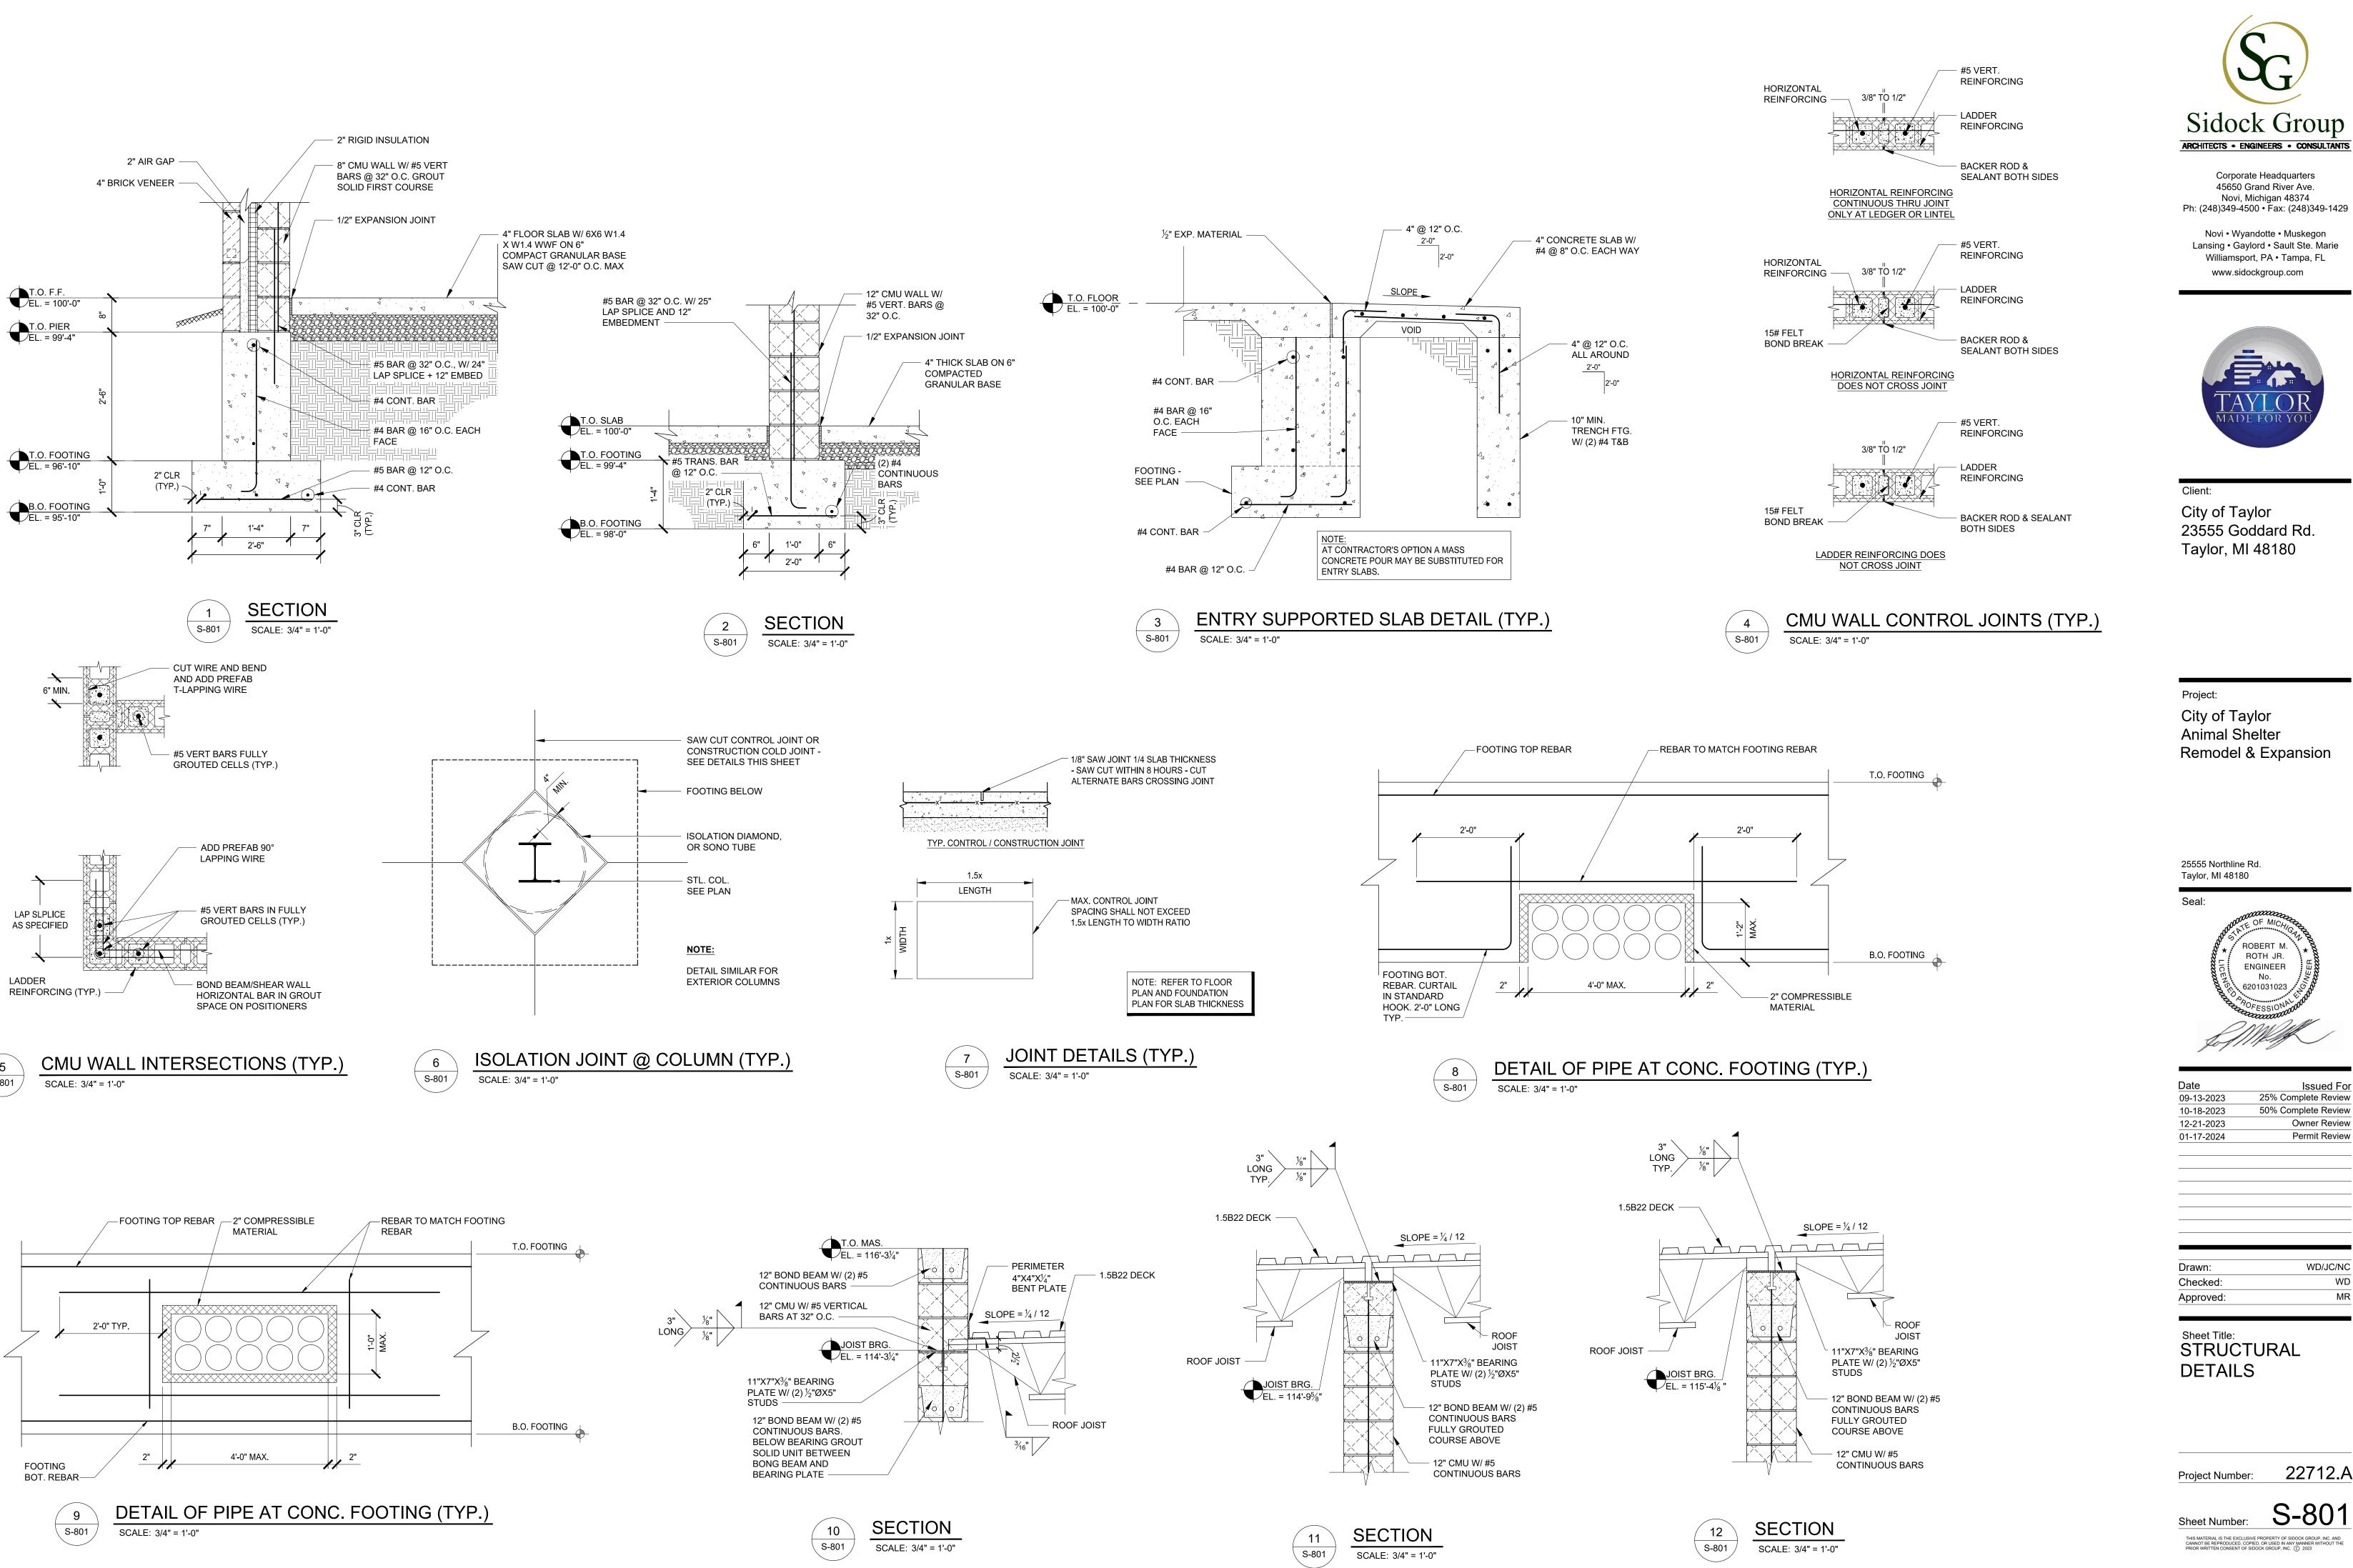


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Sheet Title: DETAILS



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♦TBM = 618.75

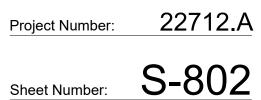

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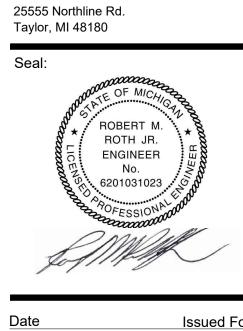
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Project:

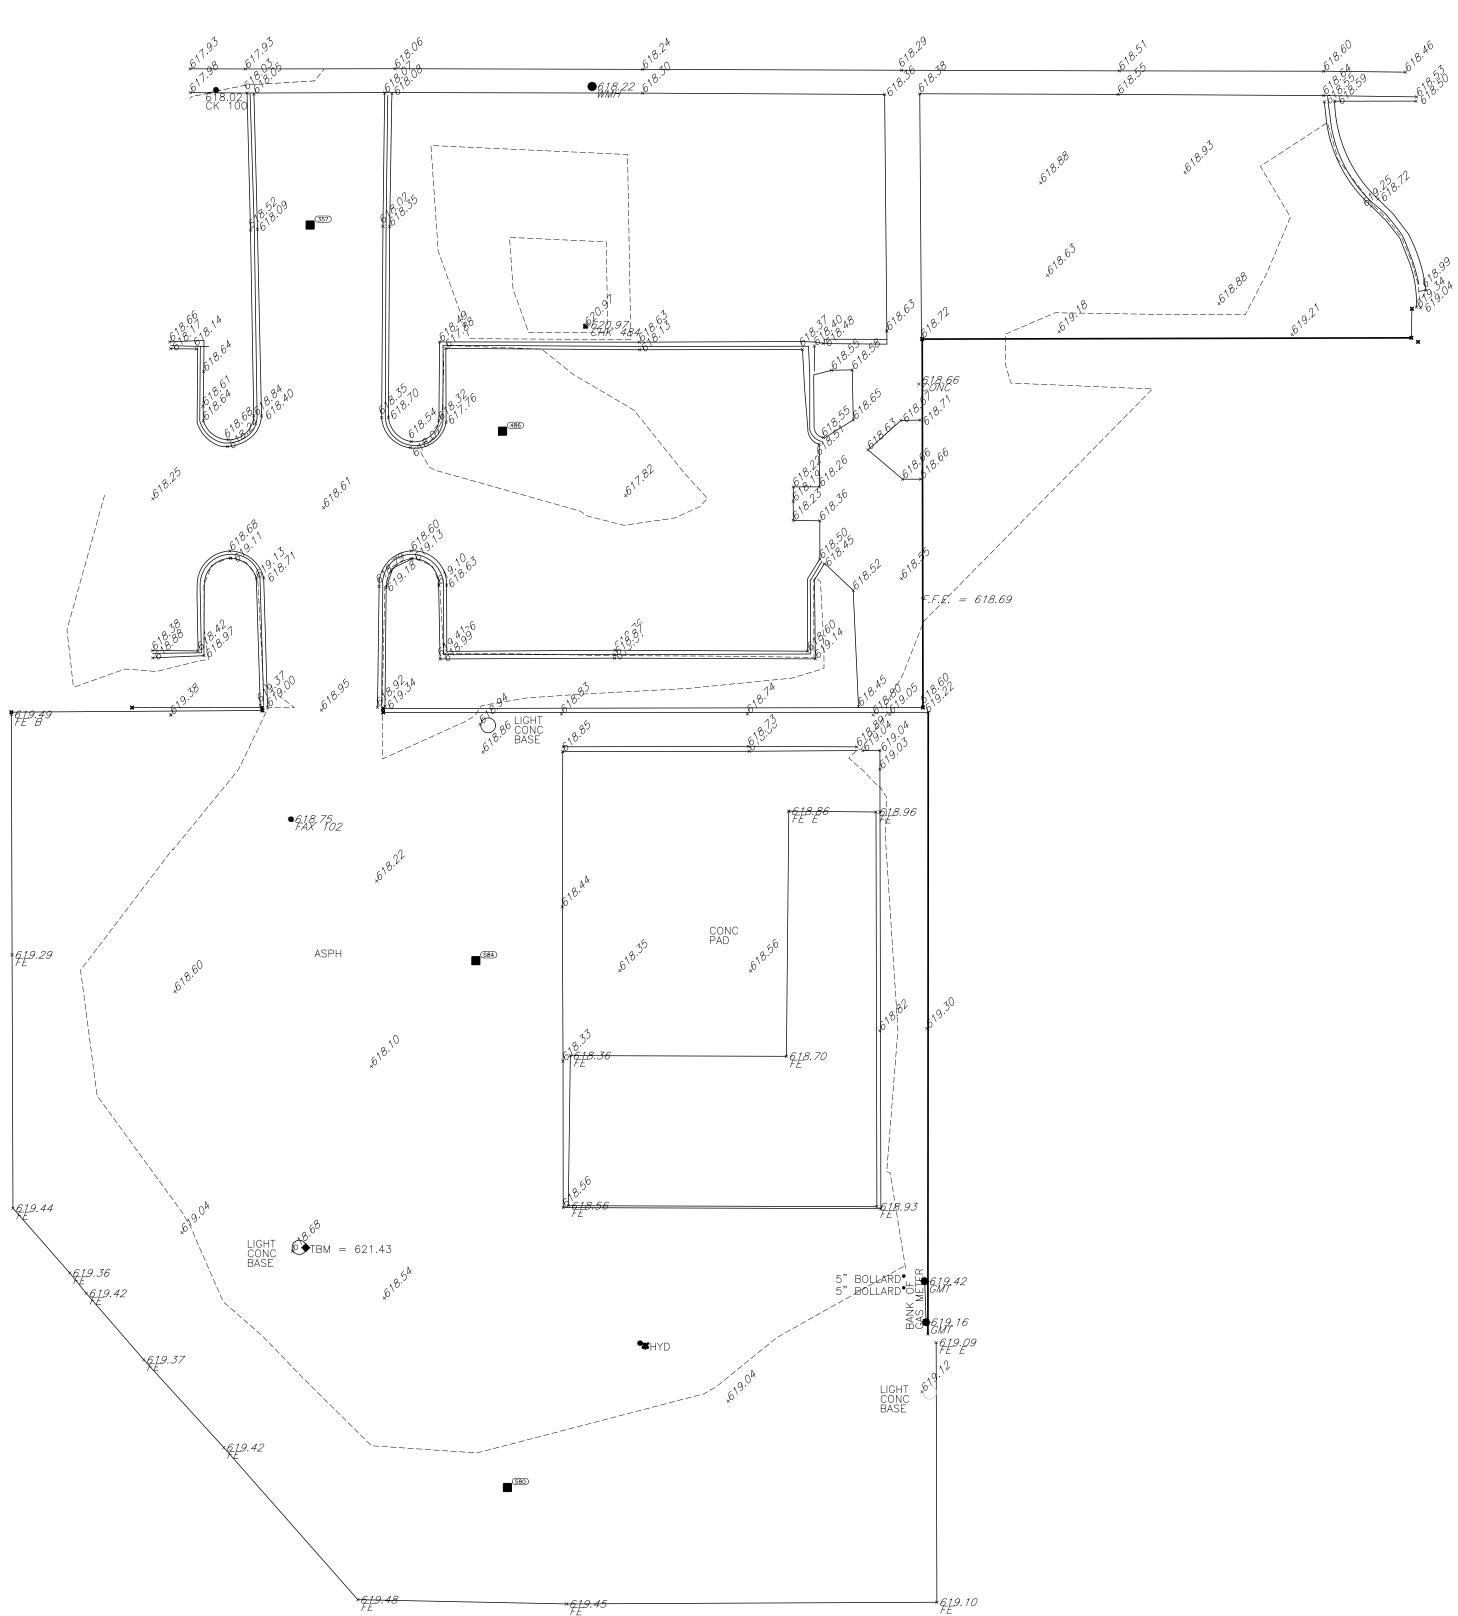City of Taylor Animal Shelter Remodel & Expansion



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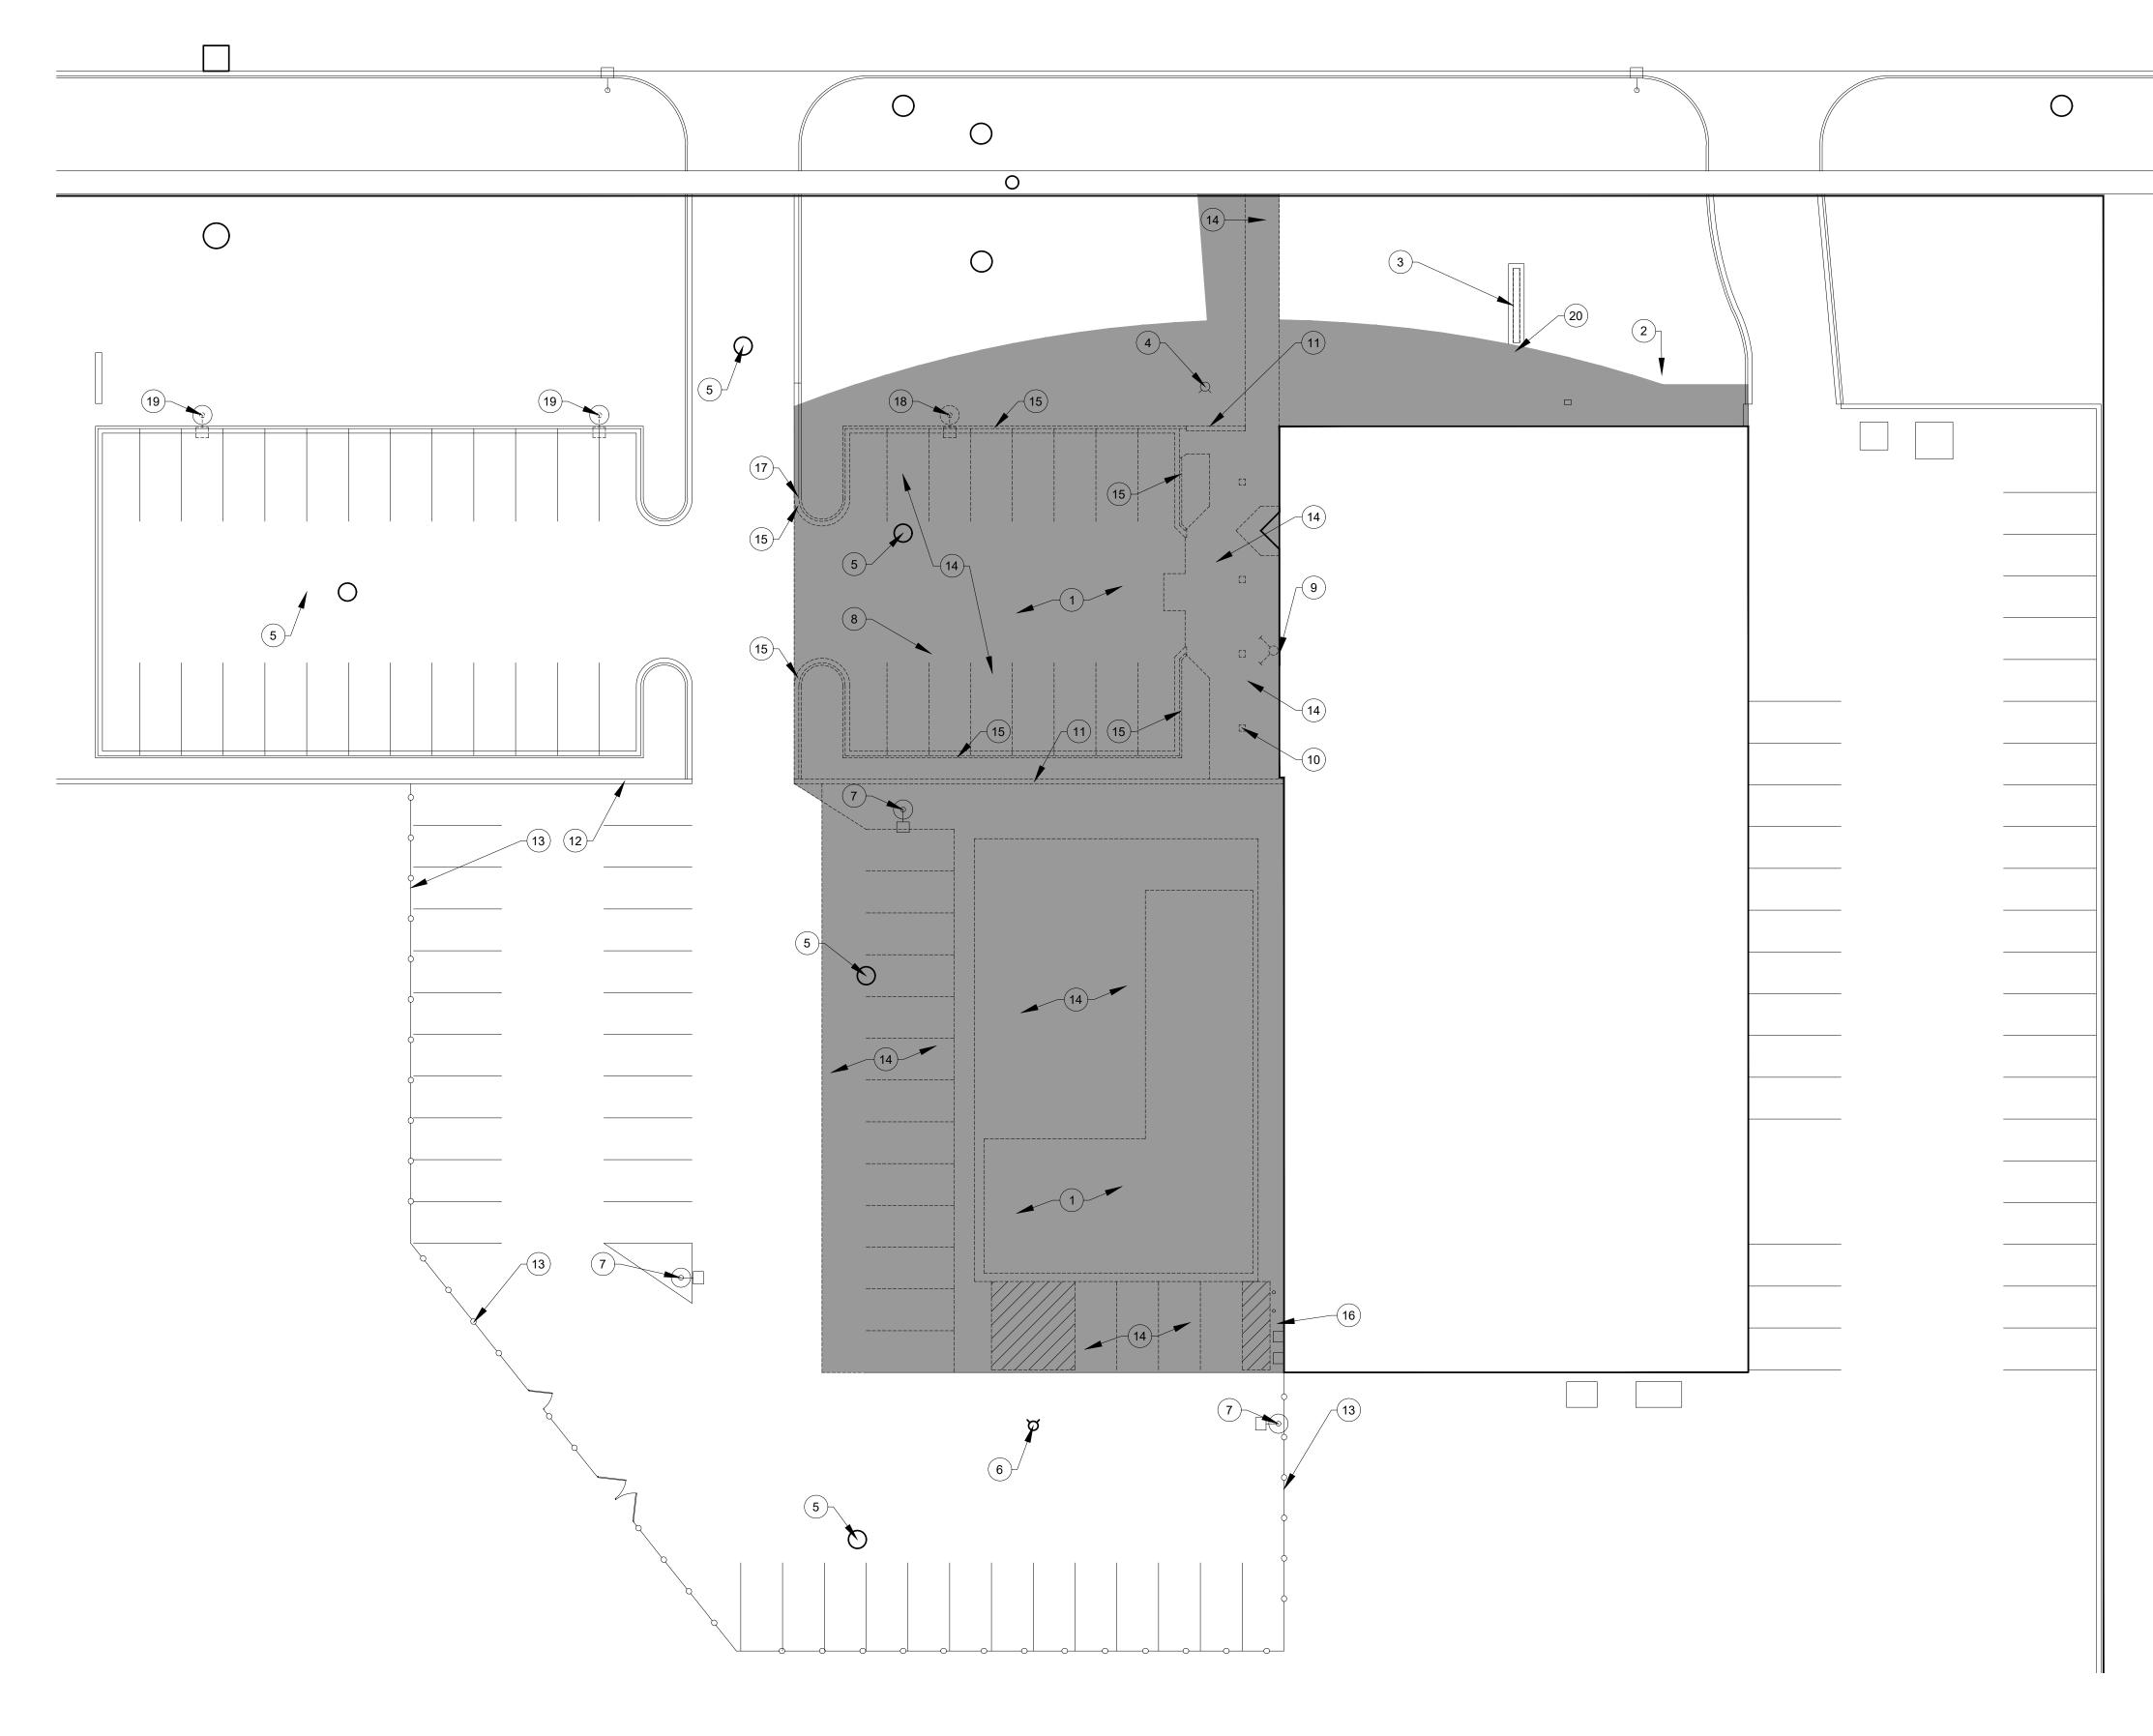
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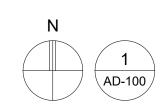
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Sheet Title: TOPOGRAPHIC SURVEY

Project Number: 22712.A

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NORTHLINE ROAD

DEMOLITION SITE PLAN

SCALE: 1" = 20'-0"

LEGEND:

x

KEY NOTE

GENERAL NOTES:

- A. REFER TO SHEET C-121 FOR DETAILED SITE DIMENSIONS AND ADDITIONAL INFORMATION.
- B. REFER TO SHEET C-130 FOR GRADING PLAN.
- C. REFER TO SHEET C-140 FOR SITE UTILITIES PLAN.
- D. REFER TO SHEET L-100 FOR LANDSCAPE PLAN.
- E. REFER TO ARCHITECTURAL AND MEP PLANS FOR FURTHER INFO.

DEMOLITION SITE PLAN NOTES:

- 1 MAJORITY OF DEMOLITION WORK TO BE CONTAINED WITHIN GRAY SHADED AREA. REFER TO C-140 FOR UNDERGROUND UTILITY WORK.
- 2 REMOVE LANDSCAPING LOCATED AT THIS NORTHEAST CORNER OF THE BUILDING.
- (3) REMOVE EXISTING LETTERING ON MONUMENT SIGN.
- (4) REMOVE FIRE HYDRANT
- 5 STORM DRAIN TO REMAIN
- 6 FIRE HYDRANT TO REMAIN
- 7 LIGHT POLE TO REMAIN
- 8 WATER SHUT-OFF VALVE TO REMAIN
- 9 FDC TO BE REMOVED & RELOCATED
- (10) REMOVE CANOPY SUPPORT COLUMNS. (4) LOCATIONS
- (11) REMOVE MASONRY WALL & FOOTING
- (12) MASONRY WALL TO REMAIN
- (13) FENCE TO REMAIN
- (14) REMOVE PAVING
- (15) REMOVE CURB
- (16) WALL MOUNTED METERS TO REMAIN. REFER TO MEP PLANS
- (17) CURB REMOVAL TO STOP AT THIS APPROXIMATE LOCATION
- (18) REMOVE EXISTING LIGHT POLE IN ITS ENTIRETY
- (19) REMOVE EXISTING LIGHT POLE. CONCRETE BASE TO REMAIN
- 20 EXISTING LAWN SPRINKLER CONTROL BOX TO BE PROTECTED DURING CONSTRUCTION. EXISTING SPRINKLER LINES SHALL BE LOCATED PRIOR TO CONSTRUCTION AND PROTECTED TO THE BEST OF THE GC'S ABILITY.



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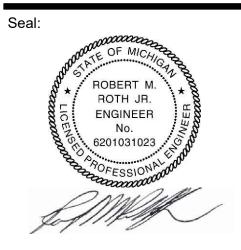


^{Client:} City of Taylor 23555 Goddard Rd. Taylor, MI 48180

Project: City of Taylor Animal Shelter

Animal Shelter Remodel & Expansion

25555 Northline Rd. Taylor, MI 48180



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 Owner Review


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 Permit Review

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MR


Sheet Title: DEMOLITION SITE PLAN

Project Number: 22712.A



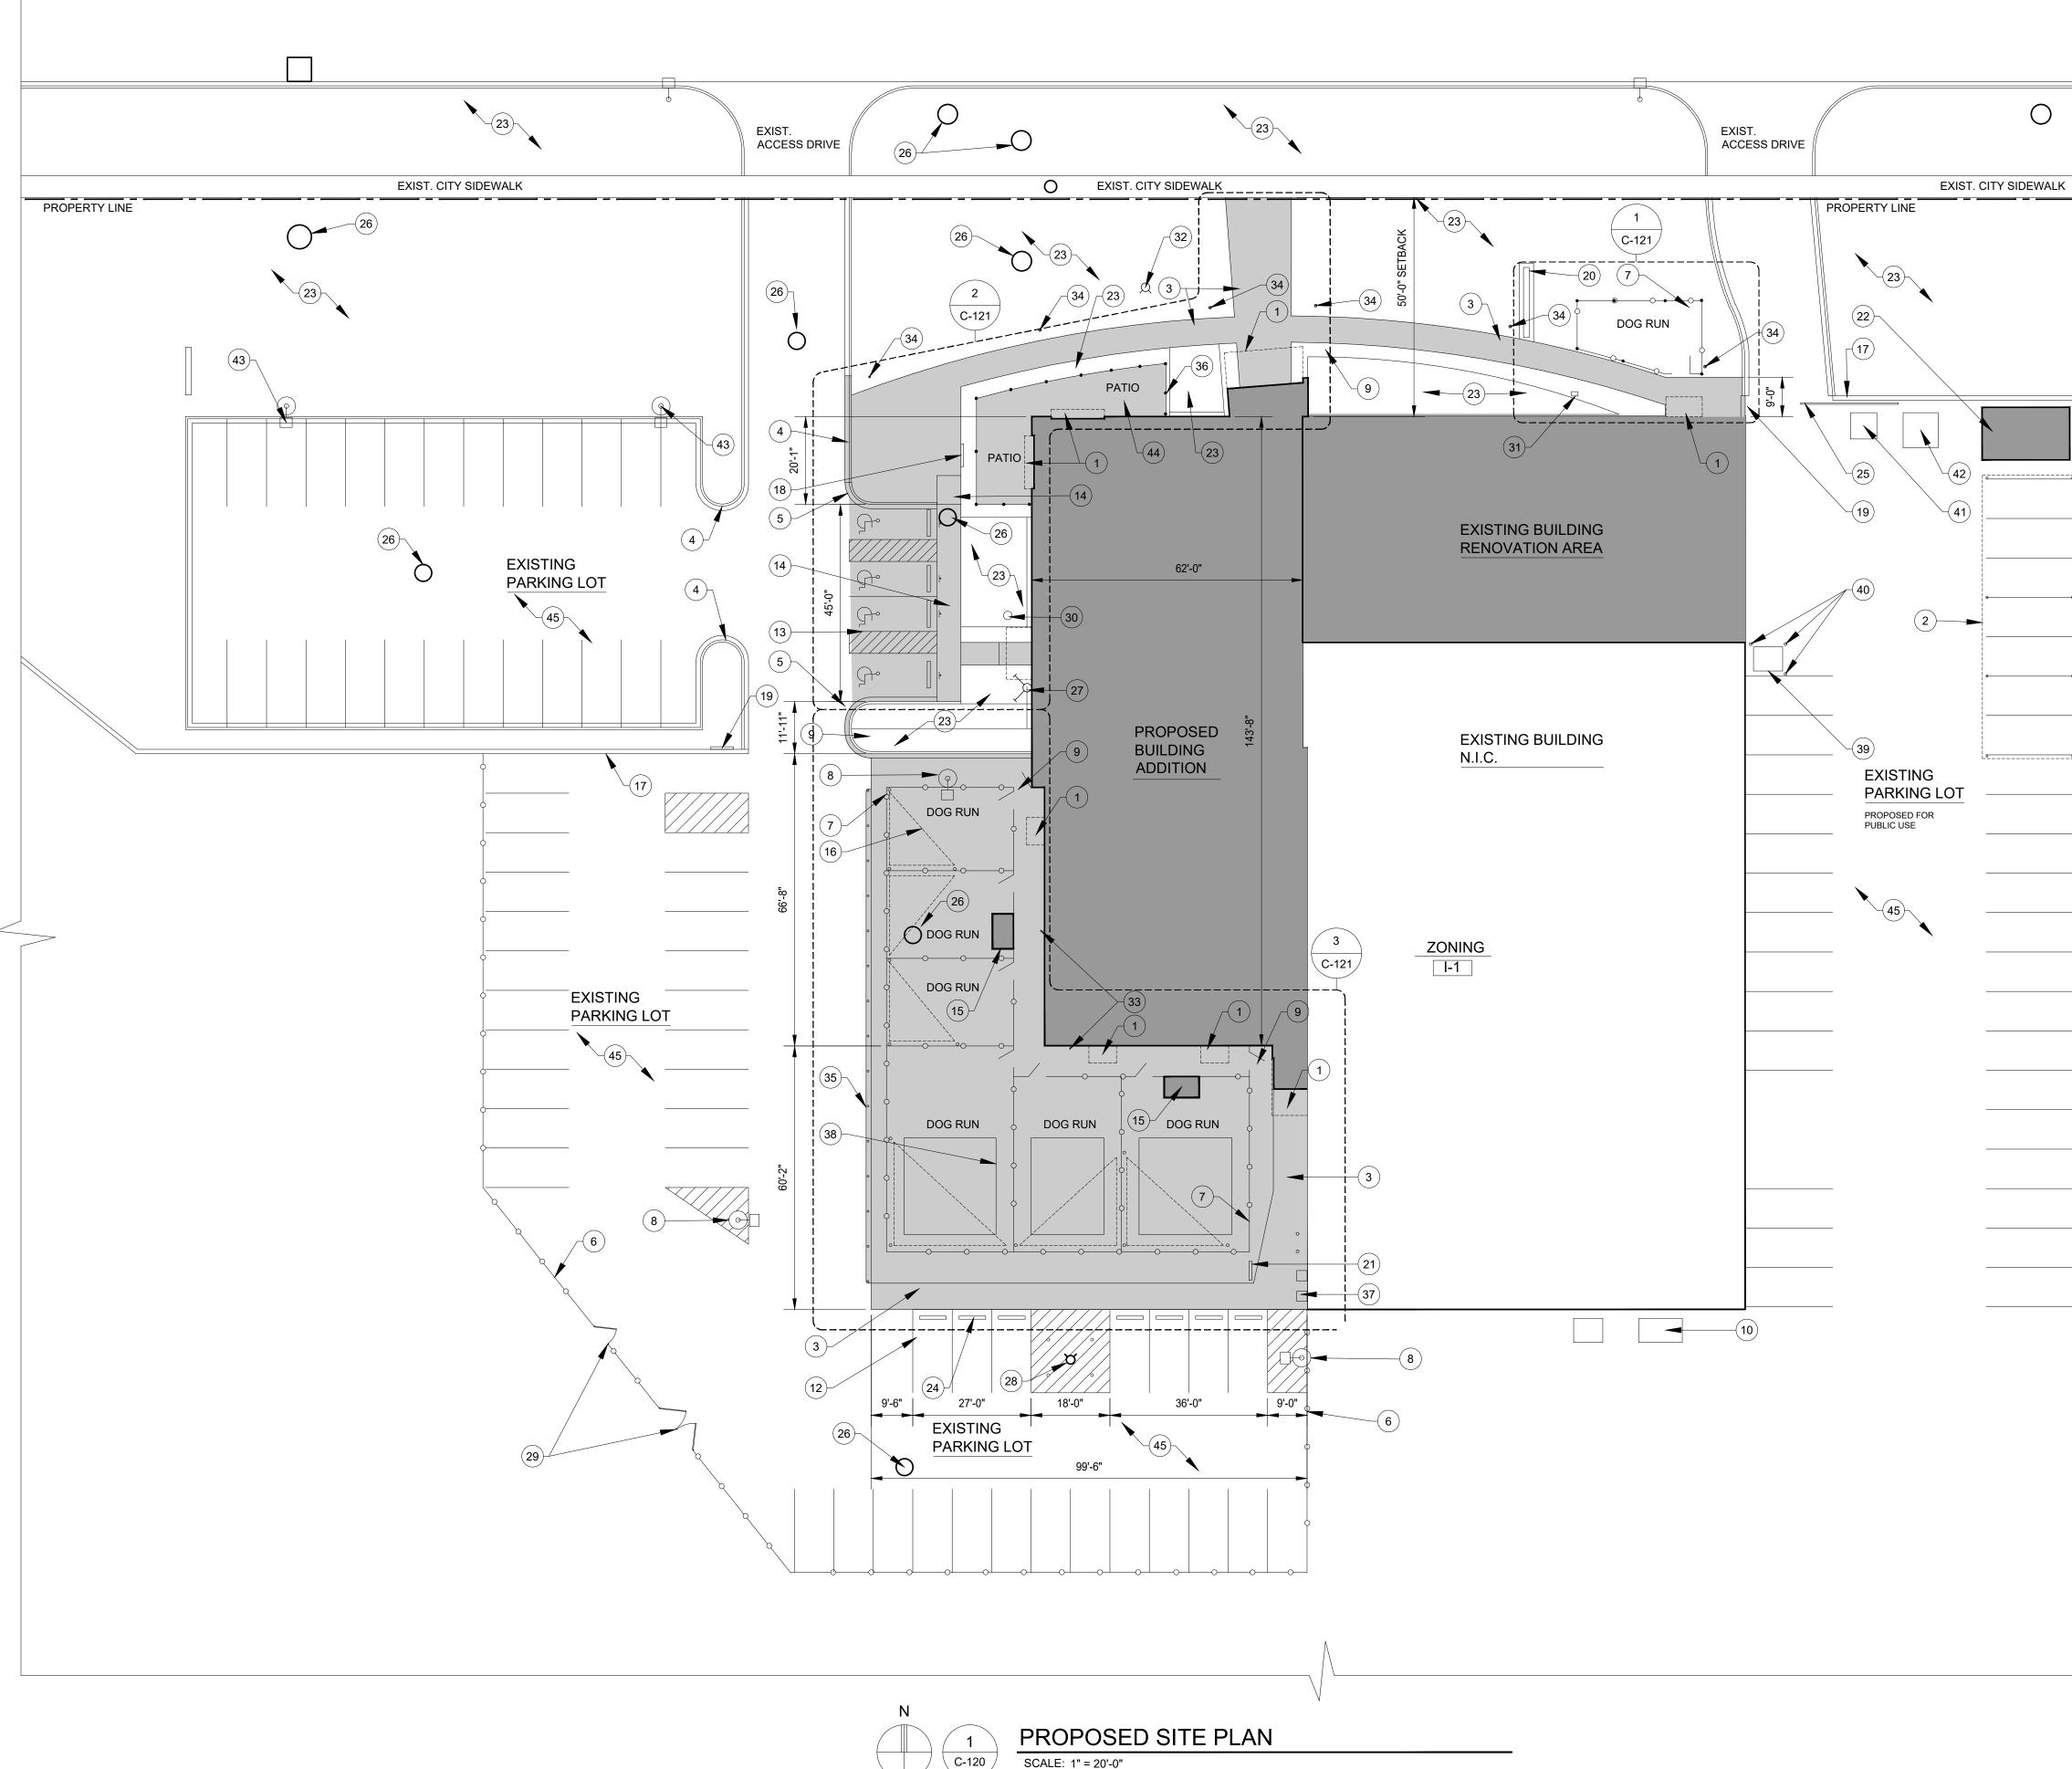

SCALE: 1" = 20'-0"

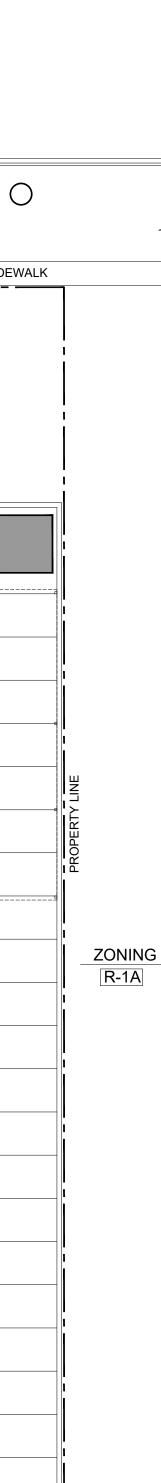

LEGEND:

- AREA OF RENOVATION, NEW BUILDING ADDITION, AND STORAGE SHEDS
- AREA OF NEW EXTERIOR PAVING AND CURBS. SEE DETAILS C-130

GENERAL NOTES:

- A. REFER TO SHEET C-121 FOR DETAILED SITE DIMENSIONS AND ADDITIONAL INFORMATION.
- B. REFER TO SHEET C-130 FOR GRADING PLAN.
- C. REFER TO SHEET C-140 FOR SITE UTILITIES PLAN.
- D. REFER TO SHEET L-100 FOR LANDSCAPE PLAN.
- E. REFER TO ARCHITECTURAL AND MEP PLANS FOR FURTHER INFO.

SITE PLAN NOTES:

(1) NEW CANOPIES AT DOORS

- 2) NEW FIXED CARPORT AT 7 SPACES. SEE BID ALTERNATE CS-001
- (3) NEW WALK. SEE PAVING DETAIL C-130
- 4 EXISTING CURB
- (5) NEW CURB. SEE DETAIL C-130.
- (6) EXISTING FENCING
- (7) NEW 8'-0" VINYL COATED CHAIN-LINK FENCING (NO-CLIMB SIZE)
- (8) EXISTING LIGHT POLE

LATCH/LOCK.

- (9) GATE TO BE EQUIPPED WITH ELECTRIC SECURITY ACCESS
- (10) EXISTING ELECTRICAL TRANSFORMER
- (11) EXISTING PARKING SPACES
- (12) NEW PARKING SPACES
- (13) 4 NEW ADA PARKING SPACES
- (14) NEW ADA WALKWAY RAMP
- (15) NEW PLASTIC STORAGE BIN/SHED. GC TO PROVIDE \$800.00 ALLOWANCE PER UNIT.
- 16 NEW SHADE SAIL CANOPIES WITHIN EACH DOG RUN. CANOPY TO INCLUDE (3) 4" STEEL TUBE SUPPORT COLUMNS AT 12'-0" HEIGHT. SUPPORTS SHALL BE SECURED WITHIN A 12" DIA. CONCRETE POST FOOTING.
- (17) EXISTING WALL
- (18) NEW DIRECTIONAL SIGNAGE
- (19) NEW SIGNAGE ON WALL
- (20) NEW LETTERING ON EXISTING MONUMENT SIGN
- (21) NEW 'FIRING RANGE' SIGN
- (22) NEW WOOD STORAGE SHED. GC TO PROVIDE \$12,000.00 ALLOWANCE.
- (23) AREA OF LAWN AND LANDSCAPING. SEE LANDSCAPING PLAN L-100.
- (24) NEW CONCRETE PARKING BLOCKS AT 7 PARKING SPACES.
- (25) EXISTING GATE TO REMAIN
- (26) EXISTING CATCH BASIN
- (27) NEW FIRE DEPARTMENT CONNECTION
- (28) EXISTING FIRE HYDRANT WITH (4) NEW STEEL BOLLARDS.
- (29) EXISTING FENCE GATE
- (30) NEW WATER SHUT OFF VALVE
- (31) EXISTING PHONE LINE PEDESTAL
- (32) NEW FIRE HYDRANT
- (33) NEW HOSE BIB
- (34) NEW LIGHT BOLLARD
- (35) NEW STEEL BUMPER GUARDRAIL AT 30" HT. WITH STEEL SUPPORT POSTS AT 8'-0" O.C.
- (36) NEW 4'-0" HIGH ALUMINUM FENCING. FENCING TO HAVE 'WROUGHT IRON' LOOK.
- (37) EXISTING GAS METERS
- (38) AREA OF ARTIFICIAL TURF WITHIN 3 OF THE DOG RUNS
- (39) NEW TRANSFORMER. SEE ELECTRICAL DWGS.
- (40) NEW STEEL BOLLARD
- (41) EXISTING DUMPSTER
- (42) EXISTING STORAGE SHED
- (43) NEW LIGHT POLE. SEE ELECTRICAL PLANS.
- (44) NEW CONCRETE PAVED PATIO WITHIN FENCE.
- (45) PARKING SPACES TO BE RE-STRIPPED THROUGHOUT.



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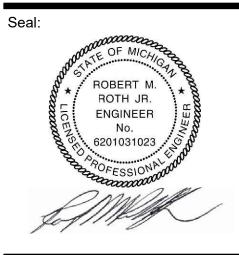
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Client: City of Taylor 23555 Goddard Rd. Taylor, MI 48180

Project: City of Taylor Animal Shelter Remodel & Expansion

25555 Northline Rd. Taylor, MI 48180



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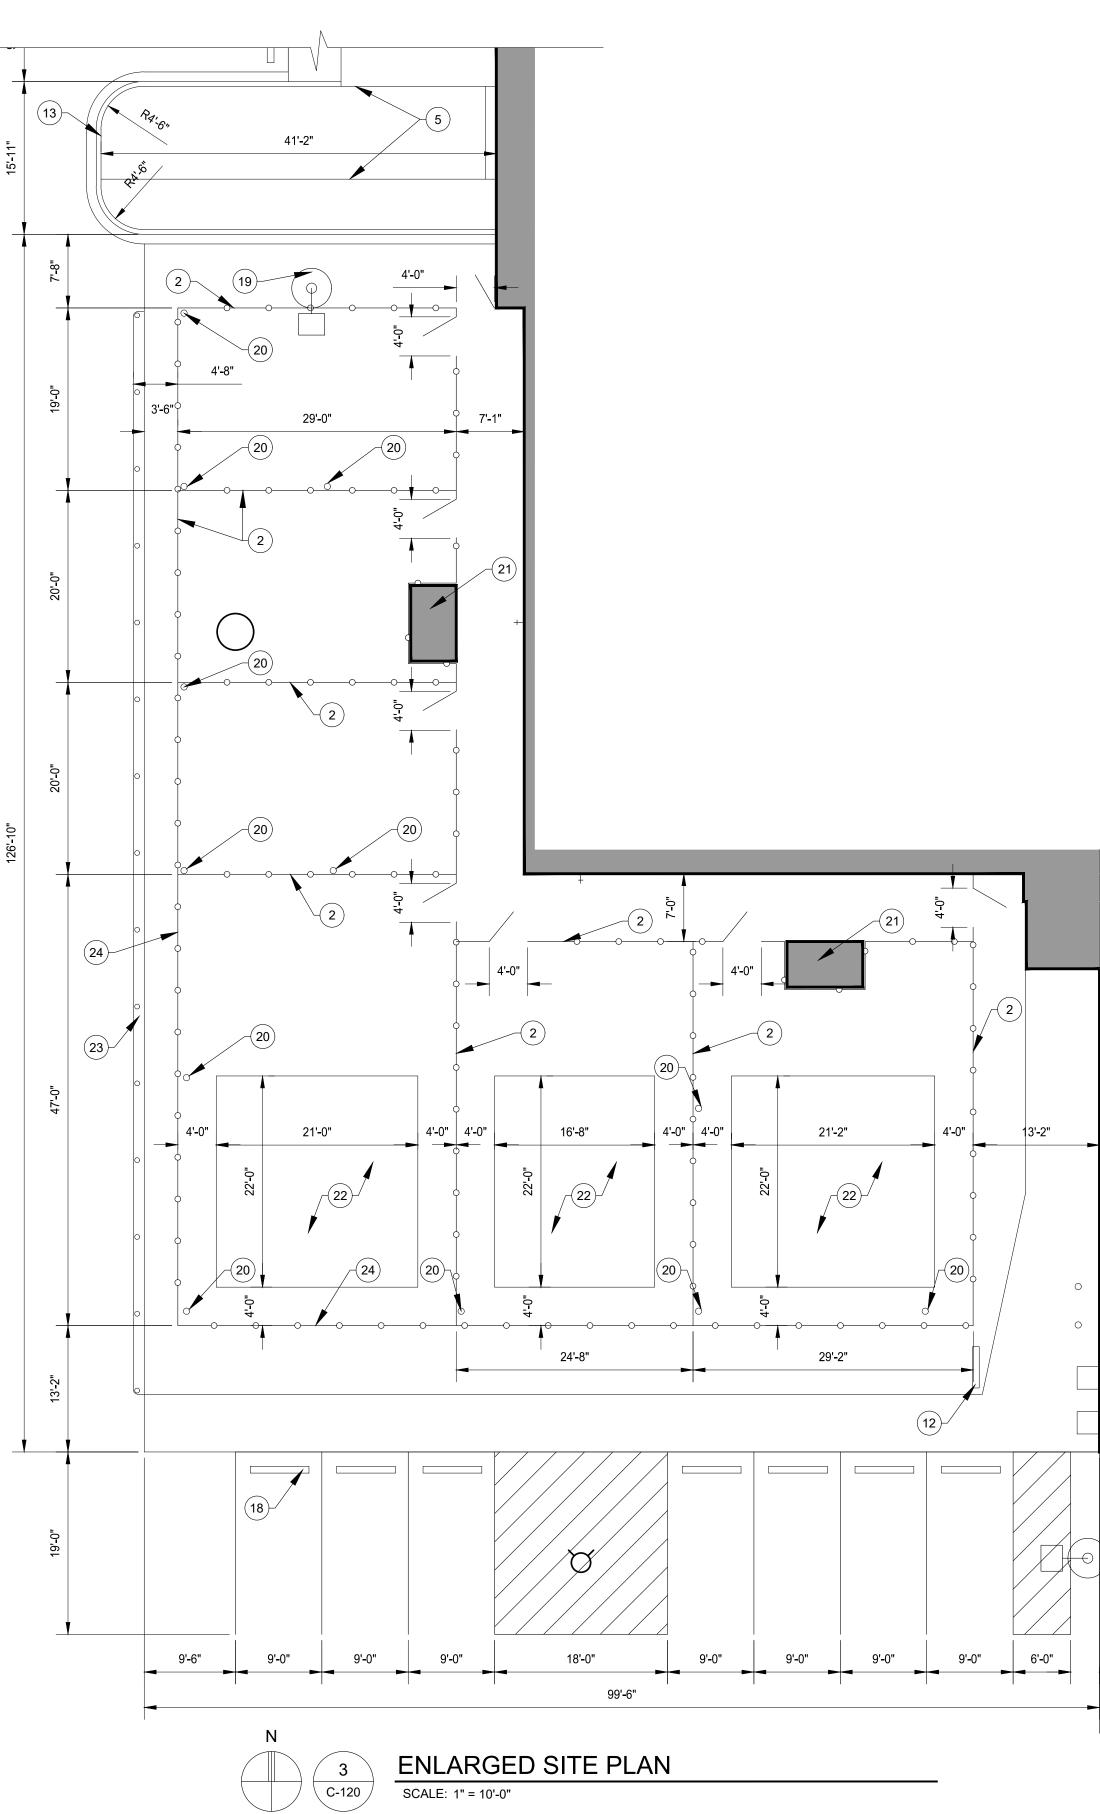
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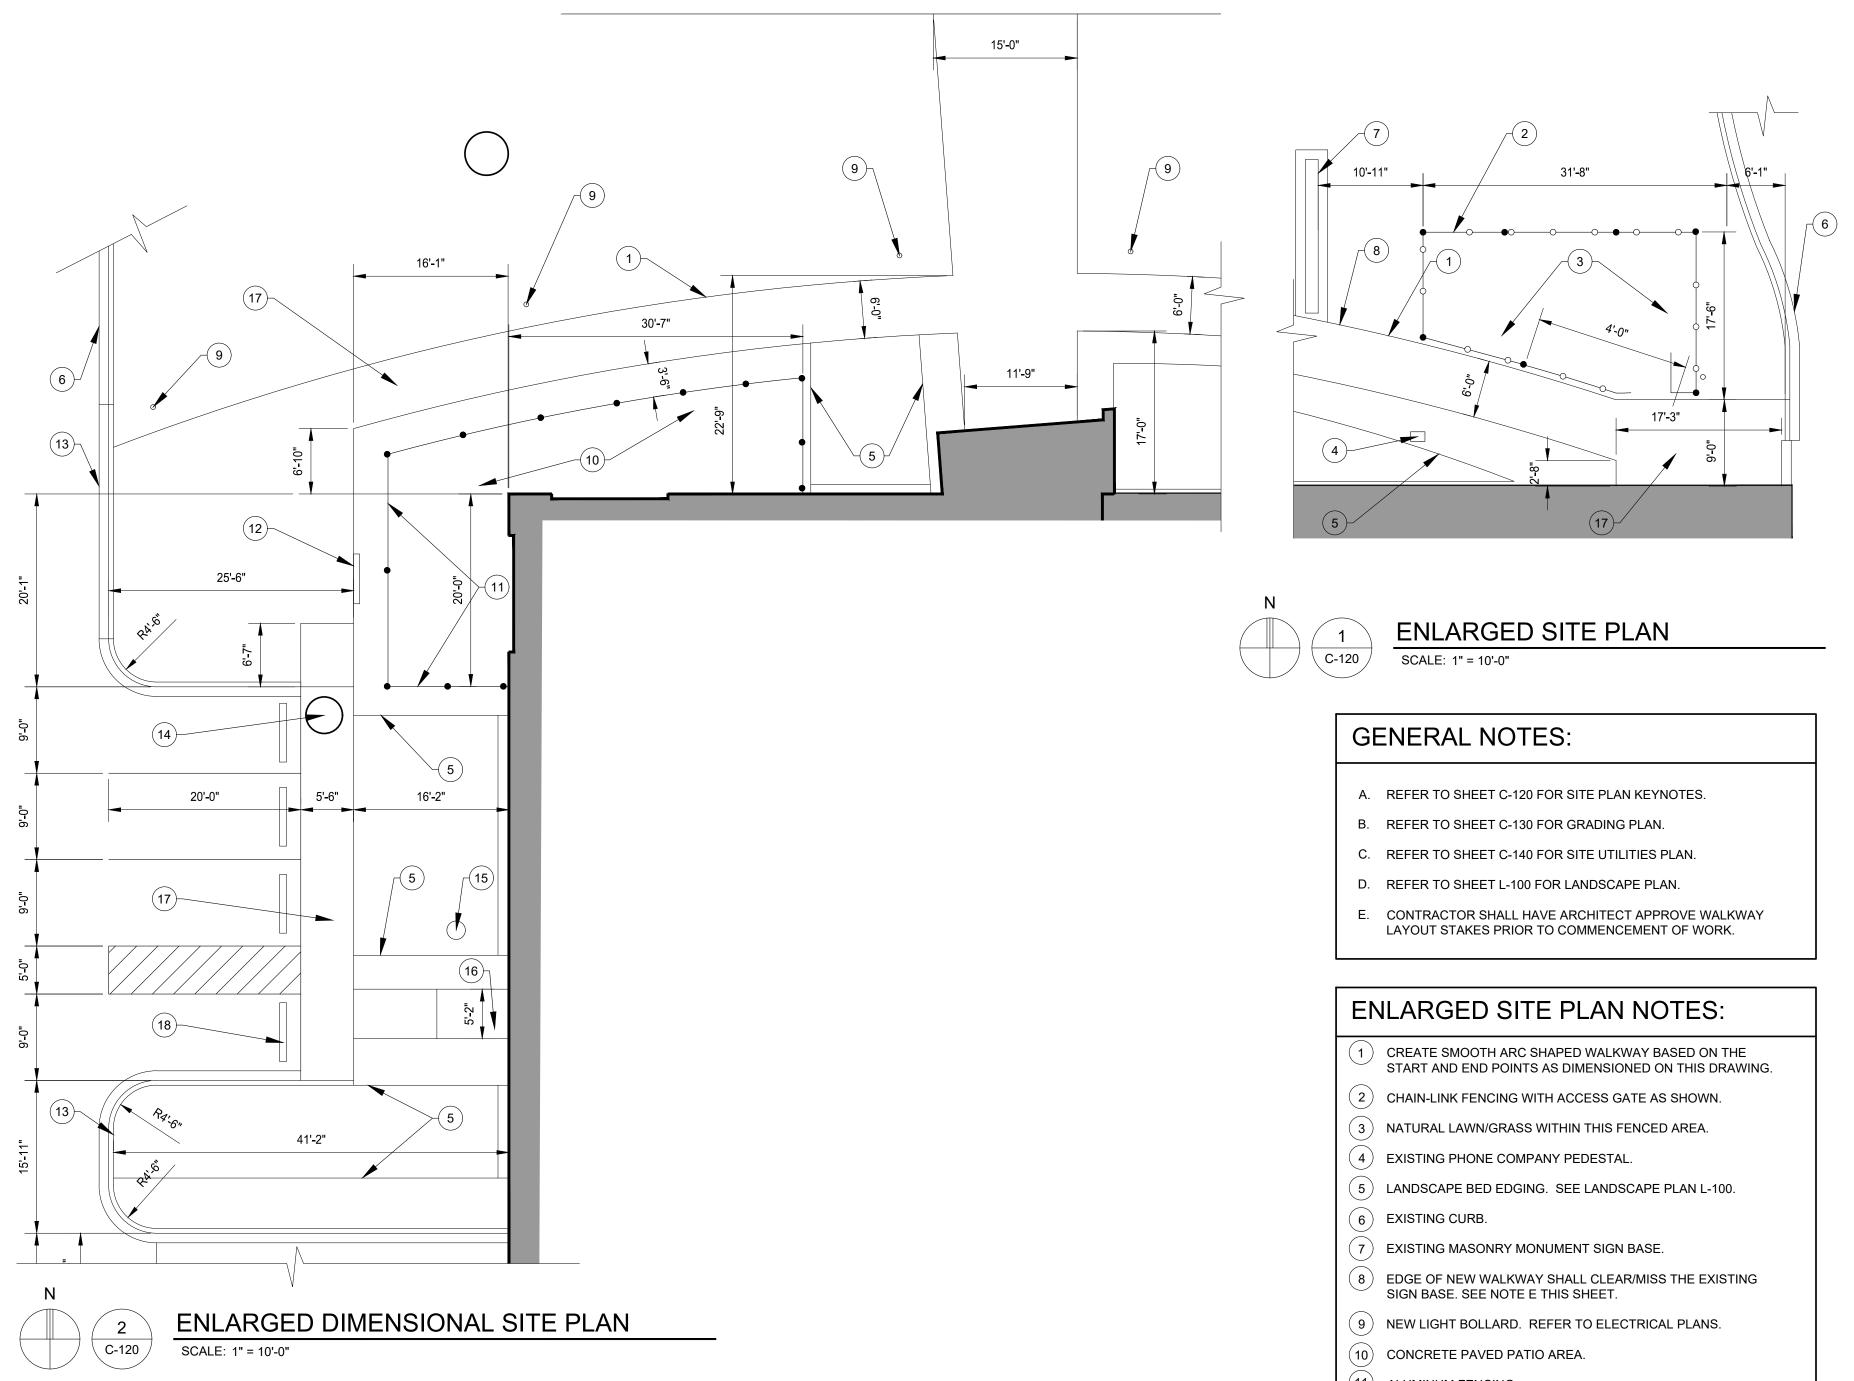


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_/(19)

3'-0"

- (11) ALUMINUM FENCING.
- (12) EXTERIOR DIRECTIONAL SIGN.
- (13) NEW CURB.
- (14) EXISTING CATCH BASIN (STORM DRAIN)
- (15) WATER SHUT-OFF VALVE LOCATION.
- (16) CONCRETE WALK CENTERED ON DOOR.
- (17) CONCRETE WALK
- (18) CONCRETE PARKING BLOCKS
- (19) EXISTING LIGHT POLE AND CONCRETE BASE.
- (20) STEEL SUPPORT COLUMN FOR OVERHEAD 'SAIL' CANOPY.
- (21) FREE-STANDING STORAGE BIN/SHED. FENCE TO BE INSTALLED AROUND SHED (FENCING CONTRACTOR SHALL COORDINATE).
- (22) AREA OF ARTIFICIAL TURF. TURF TO BE INSTALLED ON COMPACTED BASE PER MFR. SPECIFICATIONS.
- (23) STEEL VEHICLE BUMPER RAIL.
- (24) THE EAST & SOUTH FACING LENGTHS OF KENNEL FENCING SHALL BE INFILLED W/ PRIVACY SLATS TO FULL FENCE HEIGHT.



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Sheet Title: ENLARGED

SITE PLAN

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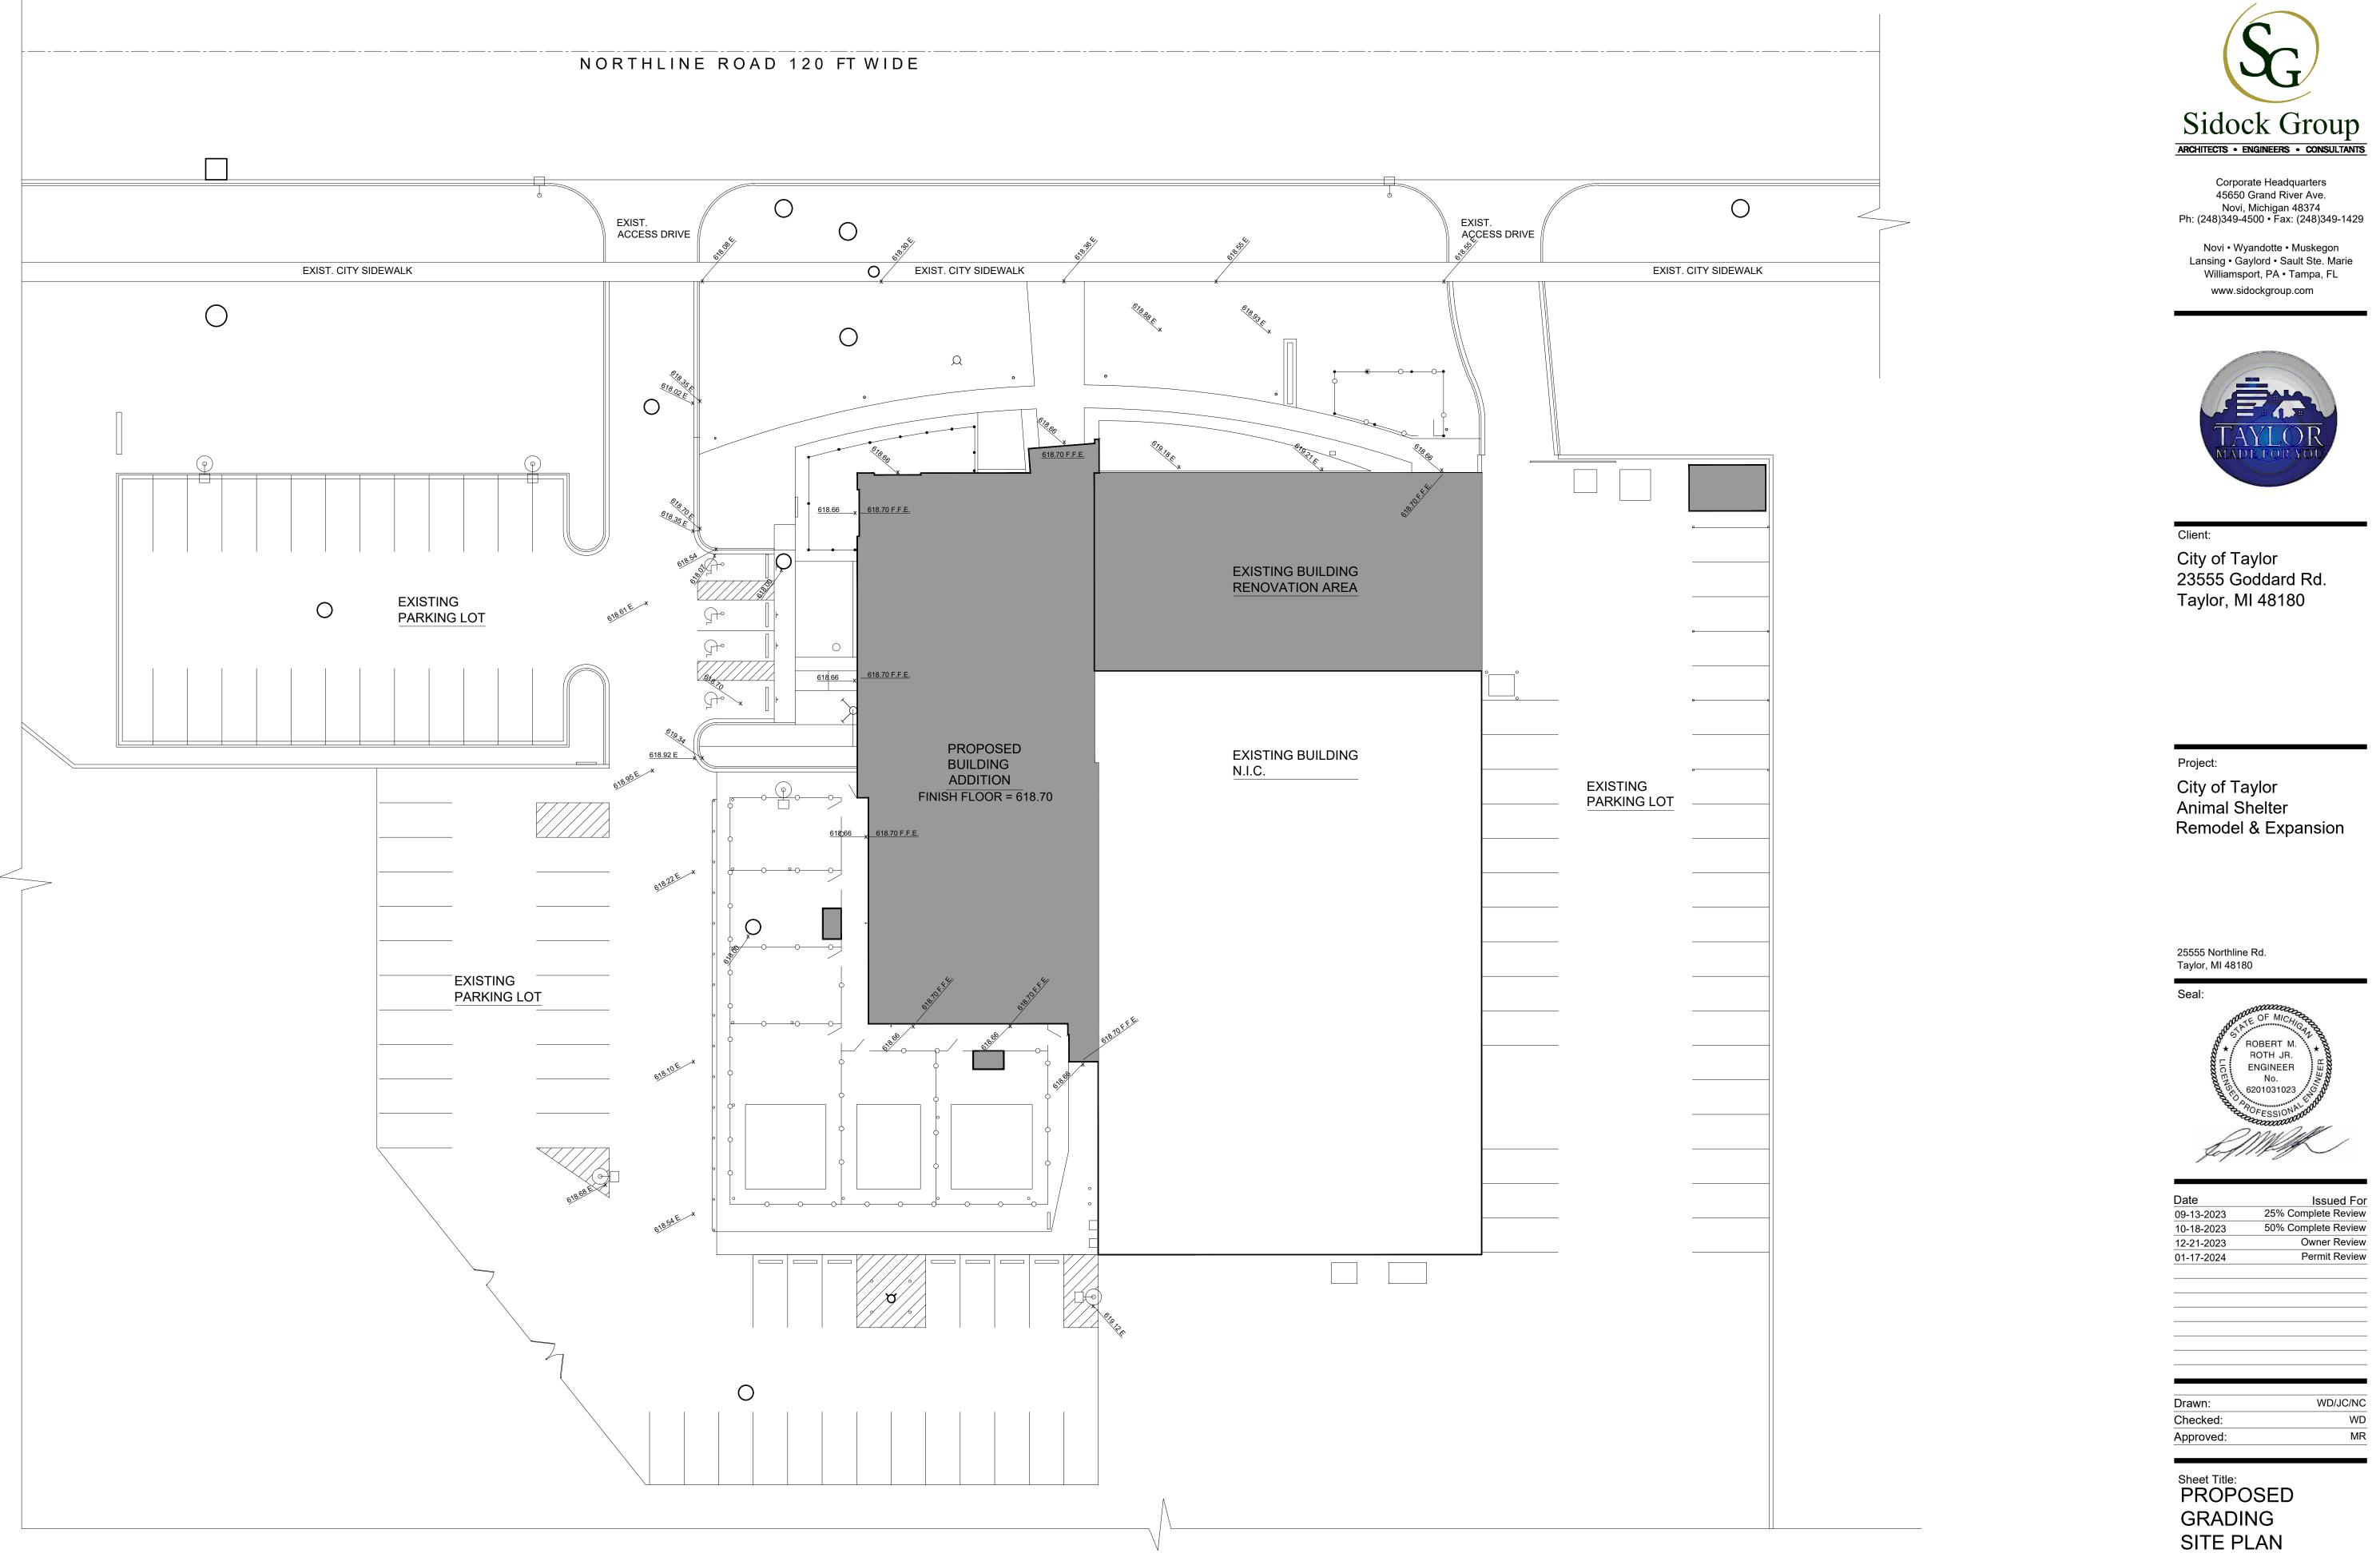
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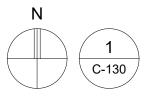
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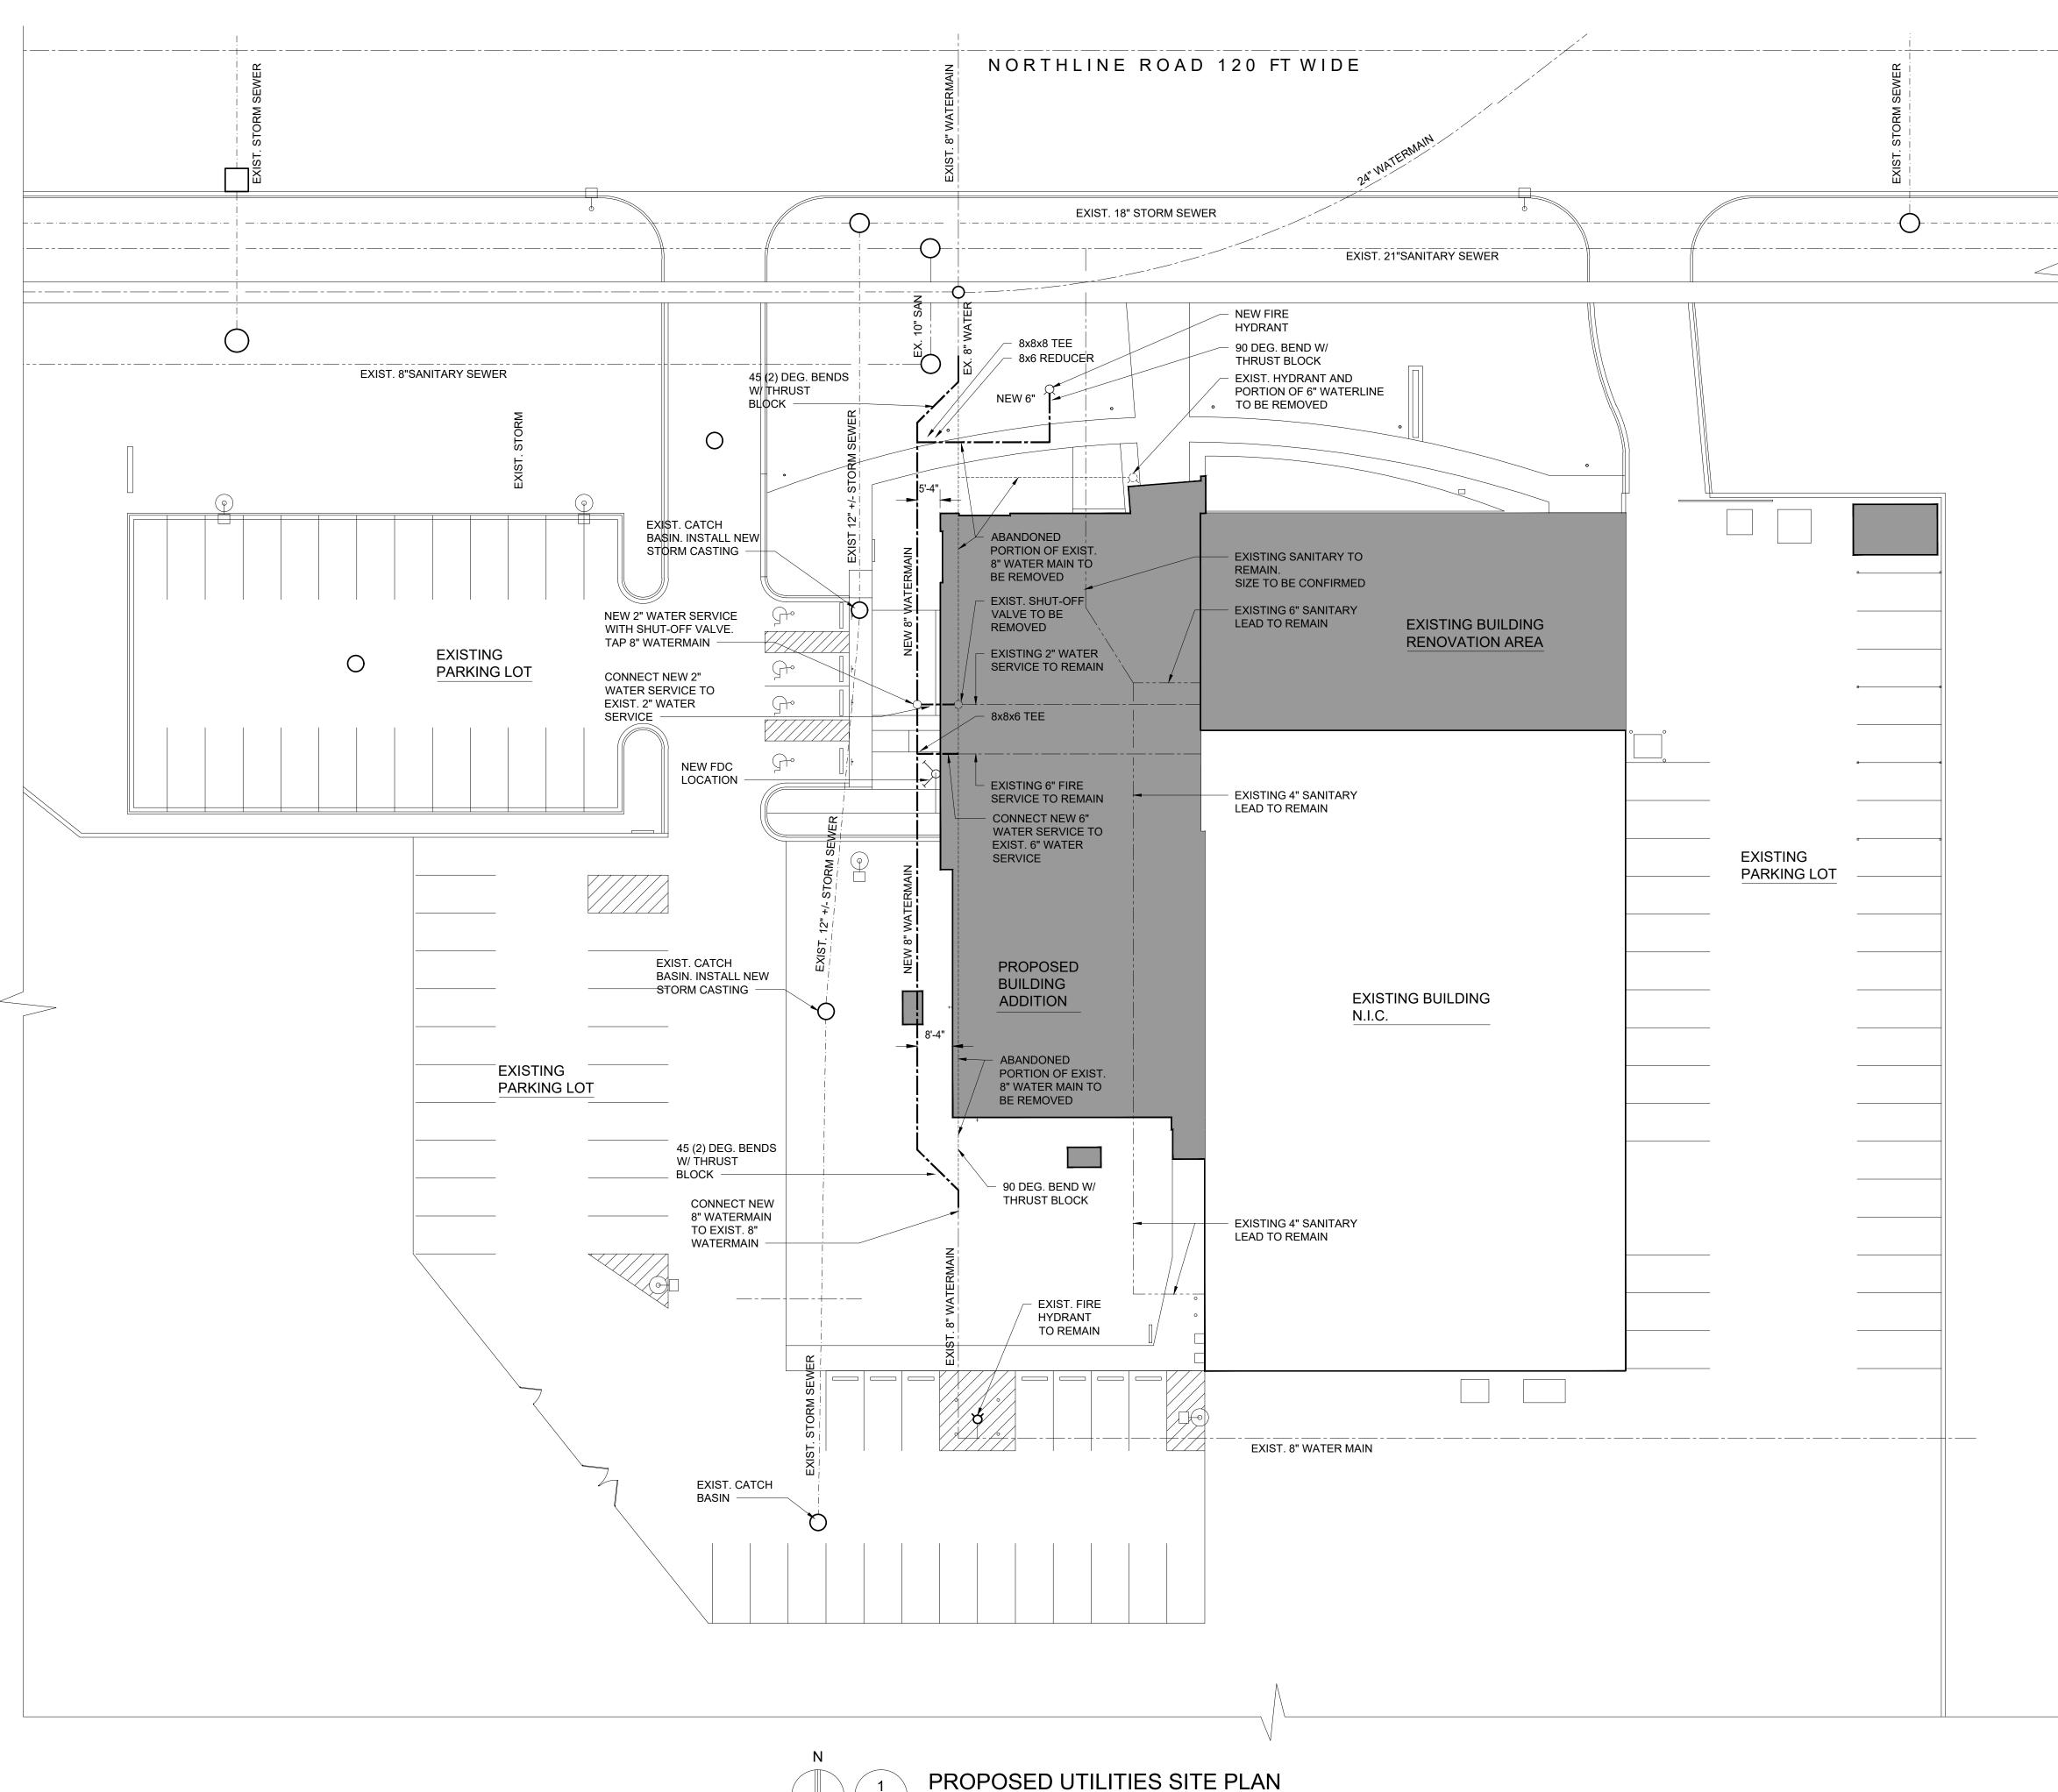
PROPOSED GRADING SITE PLAN

SCALE: 1" = 20'-0"

Project Number:

22712.A

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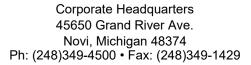
C-140 /

SCALE: 1" = 20'-0"



WATER MAIN GENERAL NOTES:

- A. GENERAL CONTRACTOR SHALL COORDINATE WATER MAIN CONSTRUCTION ACTIVITIES WITH THE CITY OF TAYLOR TO AVOID CONFLICTS WITH THE ANIMAL SHELTER AND OTHER OPERATIONS. OFF PEAK WORK HOURS MAY BE REQUIRED BY THE CITY OF TAYLOR.
- B. GENERAL CONTRACTOR SHALL ENSURE THAT WATER MAIN WORK IS SCHEDULED AND COMPLETED IN A TIMELY MANNER TO ALLOW ANIMAL SHELTER TO PREDICTABLY PERFORM NORMAL BUSINESS OPERATIONS.
- C. GENERAL CONTRACTOR IS RESPONSIBLE TO CONDUCT ALL REQUIRED WATER MAIN TESTING SUCH AS PRESSURE TEST, BRC-T SAMPLING, AND SWAB.
- D. GENERAL CONTRACTOR SHALL SCOPE/CAMERA ALL STORM WATER AND SANITARY PIPING WITHIN SCOPE OF PROJECT AND REPORT FINDINGS TO CITY OF TAYLOR AND ARCHITECT PRIOR TO COMMENCEMENT OF CONSTRUCTION.



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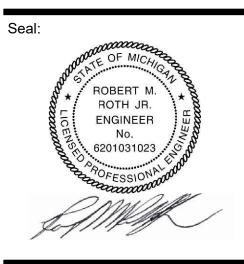


Client: City of Taylor 23555 Goddard Rd. Taylor, MI 48180

Project:

City of Taylor Animal Shelter Remodel & Expansion

25555 Northline Rd. Taylor, MI 48180



ite	Issued Fo
-13-2023	25% Complete Review
-18-2023	50% Complete Review
-21-2023	Owner Review
-17-2024	Permit Review

Drawn:	WD/JC/NC
Checked:	WD
Approved:	MR

Sheet Title: PROPOSED UTILITIES SITE PLAN

Project Number:

22712.A

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UTILITIES

CONTRACT

THE CONTRACTOR SHALL NOTIFY THE ENGINEER OF ANY EXISTING UTILITIES WHICH DO NOT MATCH THE PLANS AND SPECIFICATIONS PRIOR TO COMMENCING WORK. ANY FIELD CHANGES OF THE PROPOSED UTILITIES SHALL BE APPROVED BY THE CITY ENGINEER BEFORE THE WORK IS DONE.

THE CONTRACTOR SHALL PROTECT ALL EXISTING UTILITIES FROM DAMAGE. ANY SERVICE OR UTILITY DAMAGED OR REMOVED BY THE CONTRACTOR SHALL BE REPAIRED OR REPLACED AT THE EXPENSE OF THE CONTRACTOR, IN CONFORMANCE WITH THE REQUIREMENTS OF THE UTILITY COMPANY PROVIDER.

ALL SIDEWALKS, DRIVEWAYS, LAWNS, FENCING, TREES, SHRUBS, SPRINKLERS, LANDSCAPING, ETC., THAT ARE DAMAGED DURING CONSTRUCTION MUST BE REPAIRED OR REPLACED, IN KIND OR BETTER, BY THE CONTRACTOR. ALL STREET SIGNS, MAIL BOXES, ETC., REMOVED SHALL BE REPLACED IN KIND OR BETTER, BY THE CONTRACTOR. ALL THE REPAIRS OR REPLACEMENTS DUE TO THE CONTRACTOR'S WORK ARE TO BE INCLUDED IN THE CONTRACT PRICE(S) AND SHALL NOT BE AN EXTRA TO THE CONTRACT.

THE CONTRACTOR SHALL SECURE PERMISSION IN WRITING FROM ADJACENT PROPERTY OWNERS PRIOR TO ENTERING UPON ANY ADJOINING PROPERTIES, UNLESS OFFSITE PERMITS HAVE ALREADY BEEN OBTAINED BY THE OWNER AND ARE PART OF THE CONTRACT DOCUMENTS. DEWATERING OF TRENCH AND EXCAVATIONS

CONSTRUCTION.

OUT ON THE PLANS OR NOT

DURING THE PROGRESS OF THE WORK THE CONTRACTOR SHALL ACCOMMODATE BOTH VEHICULAR AND PEDESTRIAN TRAFFIC IN THE ROAD RIGHTS OF WAY. THE CONTRACTOR'S EQUIPMENT AND OPERATIONS ON PUBLIC STREETS SHALL BE GOVERNED BY ALL APPLICABLE LOCAL, COUNTY AND STATE ORDINANCES, REGULATIONS AND LAWS. THE CONTRACTOR SHALL OBTAIN AND SATISFY ANY AND ALL PERMIT REQUIREMENTS BY THE LOCAL, COUNTY AND STATE GOVERNMENTAL AGENCIES.

IN ADDITION, WHERE THE WORK REQUIRES THE CLOSURE OF ONE OR MORE LANES OR IS WITHIN THE INFLUENCE OF THE ROAD OR PEDESTRIAN RIGHT OF WAY, THE CONTRACTOR SHALL PROVIDE ALL SIGNS, BARRICADES, FLAG PERSONS AND OTHER TRAFFIC CONTROL MEASURES AS COLINITY AND IN CONFORMANCE WITH THE MICHIGAN MANUAL OF UNIFORM TRAFFIC CONTROL DEVICES.

PROPOSAL. IRRIGATION

SUB-SOIL CONDITIONS ANY SOIL BORING PROVIDED BY THE OWNER AND/OR ENGINEER IS PROVIDED FOR INFORMATIONAL PURPOSES ONLY. THIS INFORMATION IS NOT OFFERED AS EVIDENCE OF GROUND CONDITIONS THROUGHOUT THE PROJECT AND ONLY REFLECT THE GROUND CONDITIONS AT THE LOCATION OF THE BORING ON THE DATE THEY WERE TAKEN.

THE ACCURACY AND RELIABILITY OF THE SOIL LOGS AND REPORT ARE NOT WARRANTED OR GUARANTEED IN ANY WAY BY THE OWNER OR ENGINEER AS TO THE SUB-SOIL CONDITIONS FOUND ON THE SITE. THE CONTRACTOR SHALL MAKE THEIR OWN DETERMINATION AND SUB-SOIL INVESTIGATION AND SECURE OTHER SUCH INFORMATION AS THE CONTRACTOR CONSIDERS NECESSARY TO DO THE WORK PROPOSED AND IN PREPARATION OF THEIR BID.

IT SHALL BE THE CONTRACTOR'S RESPONSIBILITY TO REMOVE ANY AND ALL SOILS WHICH DO NOT CONFORM TO THE PLANS AND SPECIFICATIONS. THE CONTRACTOR SHALL BE RESPONSIBLE TO PROVIDE A SUBGRADE IN CONFORMANCE WITH THE PROJECT PLANS AND/OR SPECIFICATIONS. THE MEANS AND METHODS USED TO ACHIEVE THE REQUIRED RESULT SHALL REST SOLELY WITH THE CONTRACTOR.

ANY AREAS OF UNDERCUTTING THAT RESULT IN ADDITIONAL OR EXTRA WORK BECAUSE THEY COULD NOT BE IDENTIFIED BY THE CONTRACTOR'S PRE-BID SITE OBSERVATION OR ARE NOT SET FORTH IN THE PLANS AND SPECIFICATIONS, SHALL BE BROUGHT TO THE ATTENTION OF THE OWNER AND ENGINEER BEFORE ANY EXTRA WORK IS PERFORMED. THE CONTRACTOR SHALL MAKE A REQUEST FOR ANY ADDITIONAL COMPENSATION FOR THE UNDERCUTTING IN WRITING AND THE REQUEST SHALL CONFORM TO THE CONTRACT'S CHANGE ORDER PROVISIONS.

STRUCTURAL BACKFILL SHALL BE PLACED IN CONFORMANCE WITH THE PROJECT PLANS, SPECIFICATIONS OR AS REQUIRED BY THE COMMUNITY, GOVERNMENT AGENCY OR UTILITY THAT HAS JURISDICTION OVER THE WORK.

TRENCH BACKFILL SHALL BE PLACED IN CONFORMANCE WITH THE PLANS AND/OR SPECIFICATIONS. TRENCH BACKFILL SHALL ALSO BE INSTALLED IN CONFORMANCE WITH THE COMMUNITY REQUIREMENTS OR AGENCY/UTILITY GOVERNING SAID TRENCH CONSTRUCTION. IN THE CASE OF CONFLICTING REQUIREMENTS, THE MORE STRINGENT SHALL APPLY.

THE CONTRACT DOCUMENTS.

AT LEAST 72 HOURS (3 WORKING DAYS) PRIOR TO THE START OF CONSTRUCTION. THE CONTRACTOR SHALL NOTIFY MISS DIG AND THE LOCAL COMMUNITY (WHERE APPLICABLE) TO STAKE LOCATIONS OF EXISTING UTILITIES.

THE CONTRACTOR SHALL EXPOSE AND VERIFY EXISTING UTILITIES FOR LOCATION, SIZE, DEPTH, MATERIAL AND CONFIGURATION PRIOR TO CONSTRUCTION. COSTS FOR EXPLORATORY EXCAVATION IS AN INCIDENTAL COST AND SHALL NOT BE CONSIDERED AN EXTRA TO THE

DAMAGE TO PRIVATE PROPERTY

IF NOT SPECIFICALLY PROVIDED FOR IN THE CONSTRUCTION DESIGN DOCUMENTS, THE DESIGN OR QUALITATIVE ANALYSIS OF GROUND WATER DEWATERING SYSTEMS IS BEYOND THE SCOPE OF DESIGN FOR THESE DOCUMENTS. THE CONTRACTOR SHALL BE RESPONSIBLE FOR SELECTING AND PROVIDING APPROPRIATE EXCAVATION DEWATERING SYSTEMS FOR USE DURING

THE DEWATERING METHOD SELECTED BY THE CONTRACTOR WILL NOT ADVERSELY AFFECT ADJACENT PAVEMENTS OR STRUCTURES PRIOR TO BEGINNING DEWATERING CONDITIONS. MEANS AND METHODS OF DEWATERING ARE SOLELY THE RESPONSIBILITY OF THE CONTRACTOR. THE COST OF DEWATERING WILL BE CONSIDERED INCLUDED IN THE WORK OF CONSTRUCTING THE UNDERGROUND UTILITIES UNLESS SPECIFICALLY INDICATED OTHERWISE.

BY-PASS PUMPING

FROM TIME TO TIME IT MAY BE NECESSARY FOR THE CONTRACTOR TO BY-PASS PUMP TO COMPLETE THE WORK INDICATED ON THE PLANS. THE COST OF BY-PASS PUMPING, THE METHODS, EQUIPMENT AND MEANS OF PROVIDING THAT WORK ARE THE RESPONSIBILITY OF THE CONTRACTOR AND SHALL BE CONSIDERED PART OF THE WORK WHETHER SPECIFICALLY CALLED

MEANS AND METHODS FOR PIPE CONSTRUCTION

IT SHALL BE THE CONTRACTOR'S RESPONSIBILITY TO DETERMINE THE MEANS AND METHODS FOR CONSTRUCTING THE UNDERGROUND PIPE SYSTEMS PROPOSED ON THE PLANS, INCLUDING BUT NOT LIMITED TO THE NEED FOR SHORING/BRACING OF TRENCHES, DEWATERING OF TRENCHES, SCHEDULING THE WORK AT OFF PEAK HOURS, AND/OR MAINTAINING EXISTING FLOWS THAT MAY BE ENCOUNTERED VIA PUMPING, BY-PASS PIPING OR OTHER MEANS. THE CONTRACTOR SHALL NOT BE PAID ANY ADDITIONAL COMPENSATION TO IMPLEMENT ANY MEANS AND METHODS TO SATISFACTORILY COMPLETE THE CONSTRUCTION.

PAVEMENT REMOVAL

THE CONTRACTOR IS RESPONSIBLE FOR DETERMINING THE THICKNESS OF THE PAVEMENT REMOVAL. PAVEMENT CORE SAMPLES ARE FOR INFORMATIONAL PURPOSES ONLY AS TO THE THICKNESS OF THE PAVEMENT AT THE LOCATION OF THE SAMPLE. THE OWNER AND ENGINEER MAKE NO REPRESENTATION, WARRANTY OR GUARANTY THAT THE SAMPLES ACCURATELY REFLECT THE PAVEMENT THICKNESS ON THE PROJECT.

MAINTENANCE OF TRAFFIC

COMPENSATION FOR TRAFFIC CONTROL SHALL BE CONSIDERED INCLUDED IN THE CONTRACT PRICE(S) UNLESS SPECIFIC TRAFFIC CONTROL ITEMS ARE INCLUDED IN THE ACCEPTED BID

THE CONTRACTOR SHALL MAINTAIN OR REPAIR ANY EXISTING IRRIGATION SYSTEMS WITHIN THE PROJECT AREA UNLESS THE DRAWINGS CALL FOR THE IRRIGATION SYSTEM TO BE REMOVED. THE OWNER AND NFE MAKE NO REPRESENTATIONS, WARRANTY OR GUARANTY AS TO THE LOCATION OF THE IRRIGATION SYSTEM. THE CONTRACTOR SHALL TAKE ALL NECESSARY MEASURES TO PROTECT THE IRRIGATION SYSTEM DURING CONSTRUCTION ACTIVITIES. COMPENSATION FOR MAINTAINING OR REPAIRING EXISTING IRRIGATIONS SYSTEMS SHALL BE CONSIDERED INCLUDED IN THE CONTRACT PRICE(S) UNLESS SPECIFIC IRRIGATION SYSTEM REPAIR ITEMS ARE INCLUDED IN THE ACCEPTED BID PROPOSAL.

SUBGRADE UNDERCUTTING AND PREPARTION

STRUCTURE BACKFILL

TRENCH BACKFILL

EARTH BALANCE / GRADING

IT SHALL BE THE CONTRACTOR'S RESPONSIBILITY TO DETERMINE WHETHER THE SITE EARTHWORK BALANCES OR NOT. ANY EXCESS CUT MATERIAL SHALL BE DISPOSED OF BY THE CONTRACTOR. IN A LIKE MANNER, IT SHALL BE THE CONTRACTOR'S RESPONSIBILITY TO IMPORT APPROVED FILL MATERIAL AND PLACE IT AS REQUIRED TO ATTAIN THE SITE GRADE AND COMPACTION REQUIREMENTS PER THE ENGINEER'S PLAN AND ALL APPLICABLE GOVERNMENTAL STANDARDS. THE ENGINEER AND OWNER MAKE NO REPRESENTATION AS TO THE QUANTITIES THAT MAY BE NEEDED TO CREATE A BALANCED EARTHWORK CONDITION OR THAT THE SITE EARTHWORK IS BALANCED.

SOIL EROSION / SEDIMENTATION CONTROL

THE CONTRACTOR SHALL OBTAIN THE REQUIRED SOIL EROSION PERMIT AND SATISFY ALL REGULATORY REQUIREMENTS FOR CONTROLLING SOIL EROSION AND SEDIMENT TRANSPORT. THE CONTRACTOR IS RESPONSIBLE FOR THE MEANS AND METHODS. THE ENGINEER AND OWNER ARE NOT RESPONSIBLE FOR INSPECTION OR APPROVAL OF THE CONTRACTOR'S WORK IN CONNECTION WITH SATISFYING THE SOIL EROSION PERMIT REQUIREMENTS UNLESS SPECIFICALLY STATED IN

GENERAL PAVING NOTES

PAVEMENT SHALL BE OF THE TYPE, THICKNESS AND CROSS SECTION AS INDICATED ON THE PLANS AND AS FOLLOWS:

PORTLAND CEMENT TYPE IA (AIR-ENTRAINED) WITH A MINIMUM CEMENT CONCRETE: CONTENT OF SIX SACKS PER CUBIC YARD, MÍNIMUM 28 DAY COMPRESSIVE STRENGTH OF 3,500 PSI AND A SLUMP OF 1 1/2 TO 3 INCHES.

BASE COURSE - MOOT BITUMINOUS MIXTURE HMA 4E ML: ASPHALT: SURFACE COURSE - MDOT BITUMINOUS MIXTURE HMA 5E ML: BOND COAT - MDOT SS-1H EMULSION AT 0.10 GALLON PER SQUARE YARD

PAVEMENT BASE SHALL BE COMPACTED TO 95% OF THE MAXIMUM DENSITY (MODIFIED PROCTOR) PRIOR TO PLACEMENT OF PROPOSED PAVEMENT. EXISTING SUB-BASE SHALL BE PROOF-ROLLED IN THE PRESENCE OF THE ENGINEER TO DETERMINE STABILITY.

ALL CONCRETE PAVEMENT. DRIVEWAYS. CURB & GUTTER, ETC., SHALL BE SPRAY CURED WITH WHITE MEMBRANE CURING COMPOUND IMMEDIATELY FOLLOWING FINISHING OPERATION.

ALL CONCRETE PAVEMENT JOINTS SHALL BE FILLED WITH HOT POURED RUBBERIZED ASPHALT JOINT SEALING COMPOUND IMMEDIATELY AFTER SAWCUT OPERATION. FEDERAL SPECIFICATION SS-S164.

ALL WORKMANSHIP AND MATERIALS SHALL BE IN ACCORDANCE WITH THE CURRENT STANDARDS AND SPECIFICATIONS OF THE MUNICIPALITY AND THE MICHIGAN DEPARTMENT OF TRANSPORTATION STANDARD SPECIFICATIONS FOR CONSTRUCTION, CURRENT EDITION.

ALL TOP OF CURB ELEVATIONS, AS SHOWN ON THE PLANS, ARE CALCULATED FOR A 6" CONCRETE CURB UNLESS OTHERWISE NOTED.

ALL SIDEWALK RAMPS, CONFORMING TO PUBLIC ACT NO. 8, 1993, SHALL BE INSTALLED AS INDICATED ON THE PLANS. CONSTRUCTION OF A NEW OR RECONSTRUCTED DRIVE APPROACH CONNECTING TO AN

EXISTING STATE OR COUNTY ROADWAY SHALL BE ALLOWED ONLY AFTER AN APPROVED PERMIT HAS BEEN SECURED FROM THE AGENCY HAVING JURISDICTION OVER SAID ROADWAY. FOR ANY WORK WITHIN THE PUBLIC RIGHT-OF-WAY, THE CONTRACTOR SHALL PAY FOR AND

SECURE ALL NECESSARY PERMITS AND LIKEWISE ARRANGE FOR ALL INSPECTION. EXISTING TOPSOIL, VEGETATION AND ORGANIC MATERIALS SHALL BE STRIPPED AND REMOVED FROM PROPOSED PAVEMENT AREA PRIOR TO PLACEMENT OF BASE MATERIALS.

EXPANSION JOINTS SHOULD BE INSTALLED AT THE END OF ALL INTERSECTION RADII. SIDEWALK RAMPS, CONFORMING TO PUBLIC ACT NO. 8, 1973, SHALL BE INSTALLED AS


SHOWN AT ALL STREET INTERSECTIONS AND AT ALL BARRIER FREE PARKING AREAS AS INDICATED ON THE PLANS.

ALL PAVEMENT AREAS SHALL BE PROOF-ROLLED UNDER THE SUPERVISION OF A GEOTECHNICAL ENGINEER PRIOR TO THE PLACEMENT OF BASE MATERIALS AND PAVING MATERIALS.

FILL AREAS SHALL BE MACHINE COMPACTED IN UNIFORM LIFTS NOT EXCEEDING 9 INCHES THICK TO 98% OF THE MAXIMUM DENSITY (MODIFIED PROCTOR) PRIOR TO PLACEMENT OF PROPOSED PAVEMENT

GENERAL TREE PROTECTION NOTES

- APPROVED TREE PROTECTION SHALL BE ERECTED PRIOR TO THE START OF CONSTRUCTION ACTIVITIES, AND SHALL REMAIN IN PLACE UNTIL THE IN PLACE UNTIL CONSTRUCTION IS COMPLETE.
- ALL UNDERSTORY VEGETATION WITHIN THE LIMITS OF PROTECTIVE FENCING SHALL BE PRESERVED. NO PERSON MAY CONDUCT ANY ACTIVITY WITHIN THE DRIP LINE OF ANY TREE .3.
- DESIGNATED TO REMAIN, INCLUDING BUT NOT LIMITED TO, PLACING SOLVENTS, BUILDING MATERIALS, CONSTRUCTION EQUIPMENT, OR SOIL DEPOSITS WITHIN THE DRIP LINE. WHERE GROUPINGS OF TREES ARE TO REMAIN, TREE FENCING SHALL BE PLACED AT
- THE LIMITS OF GRADING LINE. DURING CONSTRUCTION, NO PERSON SHALL ATTACH ANY DEVICE OR WIRE TO ANY TREE,
- SCHEDULED TO REMAIN. ALL UTILITY SERVICE REQUESTS MUST INCLUDE NOTIFICATION TO THE INSTALLER THAT PROTECTED TREES MUST BE AVOIDED. ALL TRENCHING SHALL OCCUR OUTSIDE OF THE
- PROTECTIVE FENCING. SWALES SHALL BE ROUTED TO AVOID THE AREA WITHIN THE DRIP LINES OF PROTECTED
- TREES LOCATED ON ADJACENT PROPERTIES THAT MAY BE AFFECTED BY CONSTRUCTION 8. ACTIVITIES MUST BE PROTECTED.
- ROOT ZONES OF PROTECTED TREES SHOULD BE SURROUNDED WITH RIGIDLY STAKED
- FENCING. 10. THE PARKING OF IDLE AND RUNNING EQUIPMENT SHALL BE PROHIBITED UNDER THE
- DRIP LINE OF PROTECTED TREES. THE STRIPPING OF TOPSOIL FROM AROUND PROTECTED TREES SHALL BE PROHIBITED. ALL TREES TO BE REMOVED SHALL BE CUT AWAY FROM TREES TO REAMIN. 13. THE GRUBBING OF UNDERSTORY VEGETATION WITHIN CONSTRUCTION AREAS SHOULD BE CLEARED BY CUTTING VEGETATION AT THE GROUND WITH A CHAIN SAW OR MINIMALLY
- WITH A HYDRO-AXE. 14. THE CONTRACTOR IS RESPONSIBLE FOR THE REPLACEMENT PER ORDINANCE GUIDELINES, FOR THE DAMAGE OR REMOVAL OF ANY TREE DESIGNATED TO REMAIN.
- 15. TREES TO BE REMOVED SHALL BE FIELD VERIFIED, EVALUATED AND FLAGGED FOR REMOVAL, BY THE LANDSCAPE ARCHITECT OR FORESTER, ONLY AS DIRECTED BY THE OWNER OR OWNERS REPRESENTATIVE.

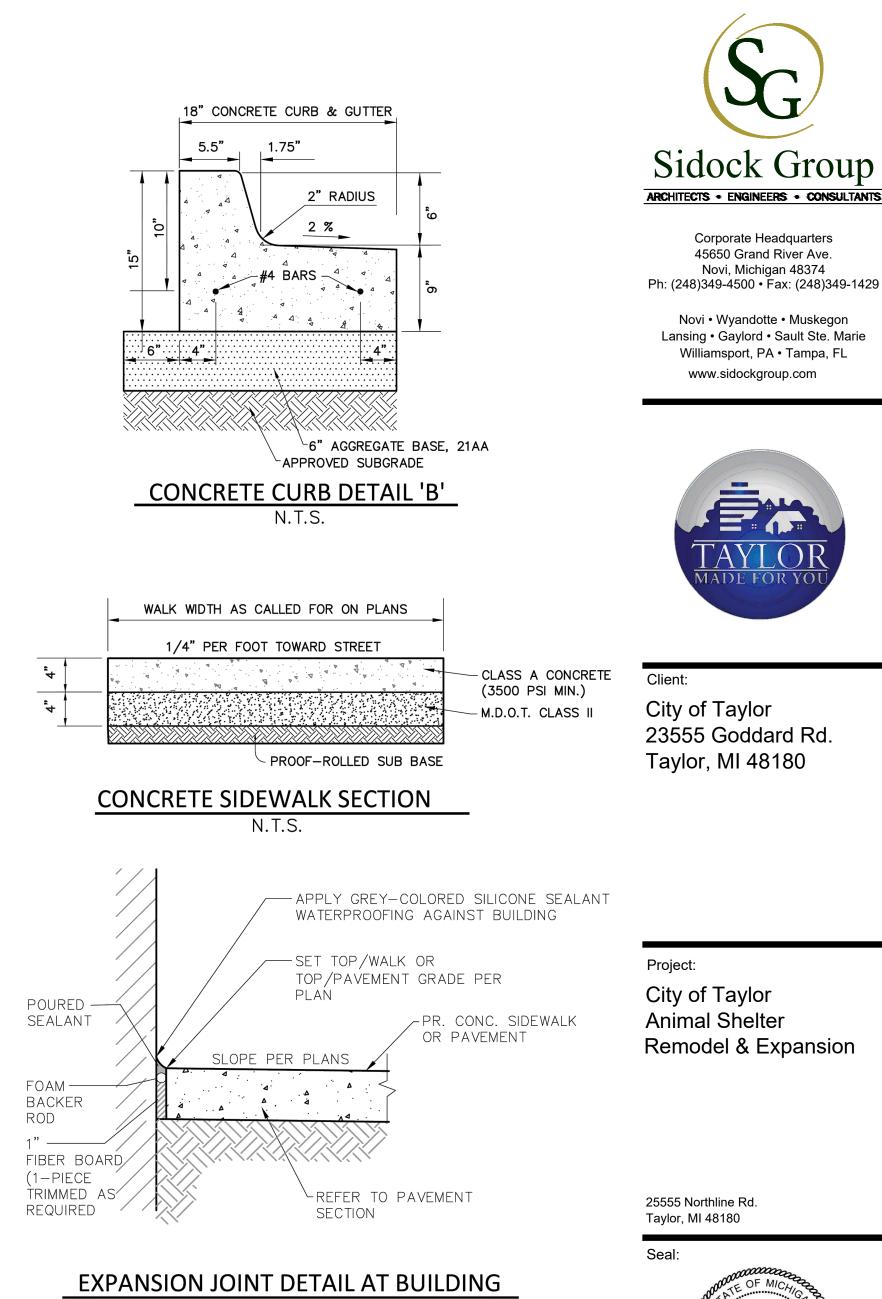

N.T.S.


ROBERT M ROTH JR. ENGINEER No. 6201031023

Date	Issued For	
09-13-2023	25% Complete Review	
10-18-2023	50% Complete Review	
12-21-2023	Owner Review	
01-17-2024	Permit Review	
Drawn:	WD/JC/NC	
Checked:	WD	
Approved:	MR	

Sheet Title: **GENERAL NOTES** & DETAILS

22712.A Project Number: Sheet Number

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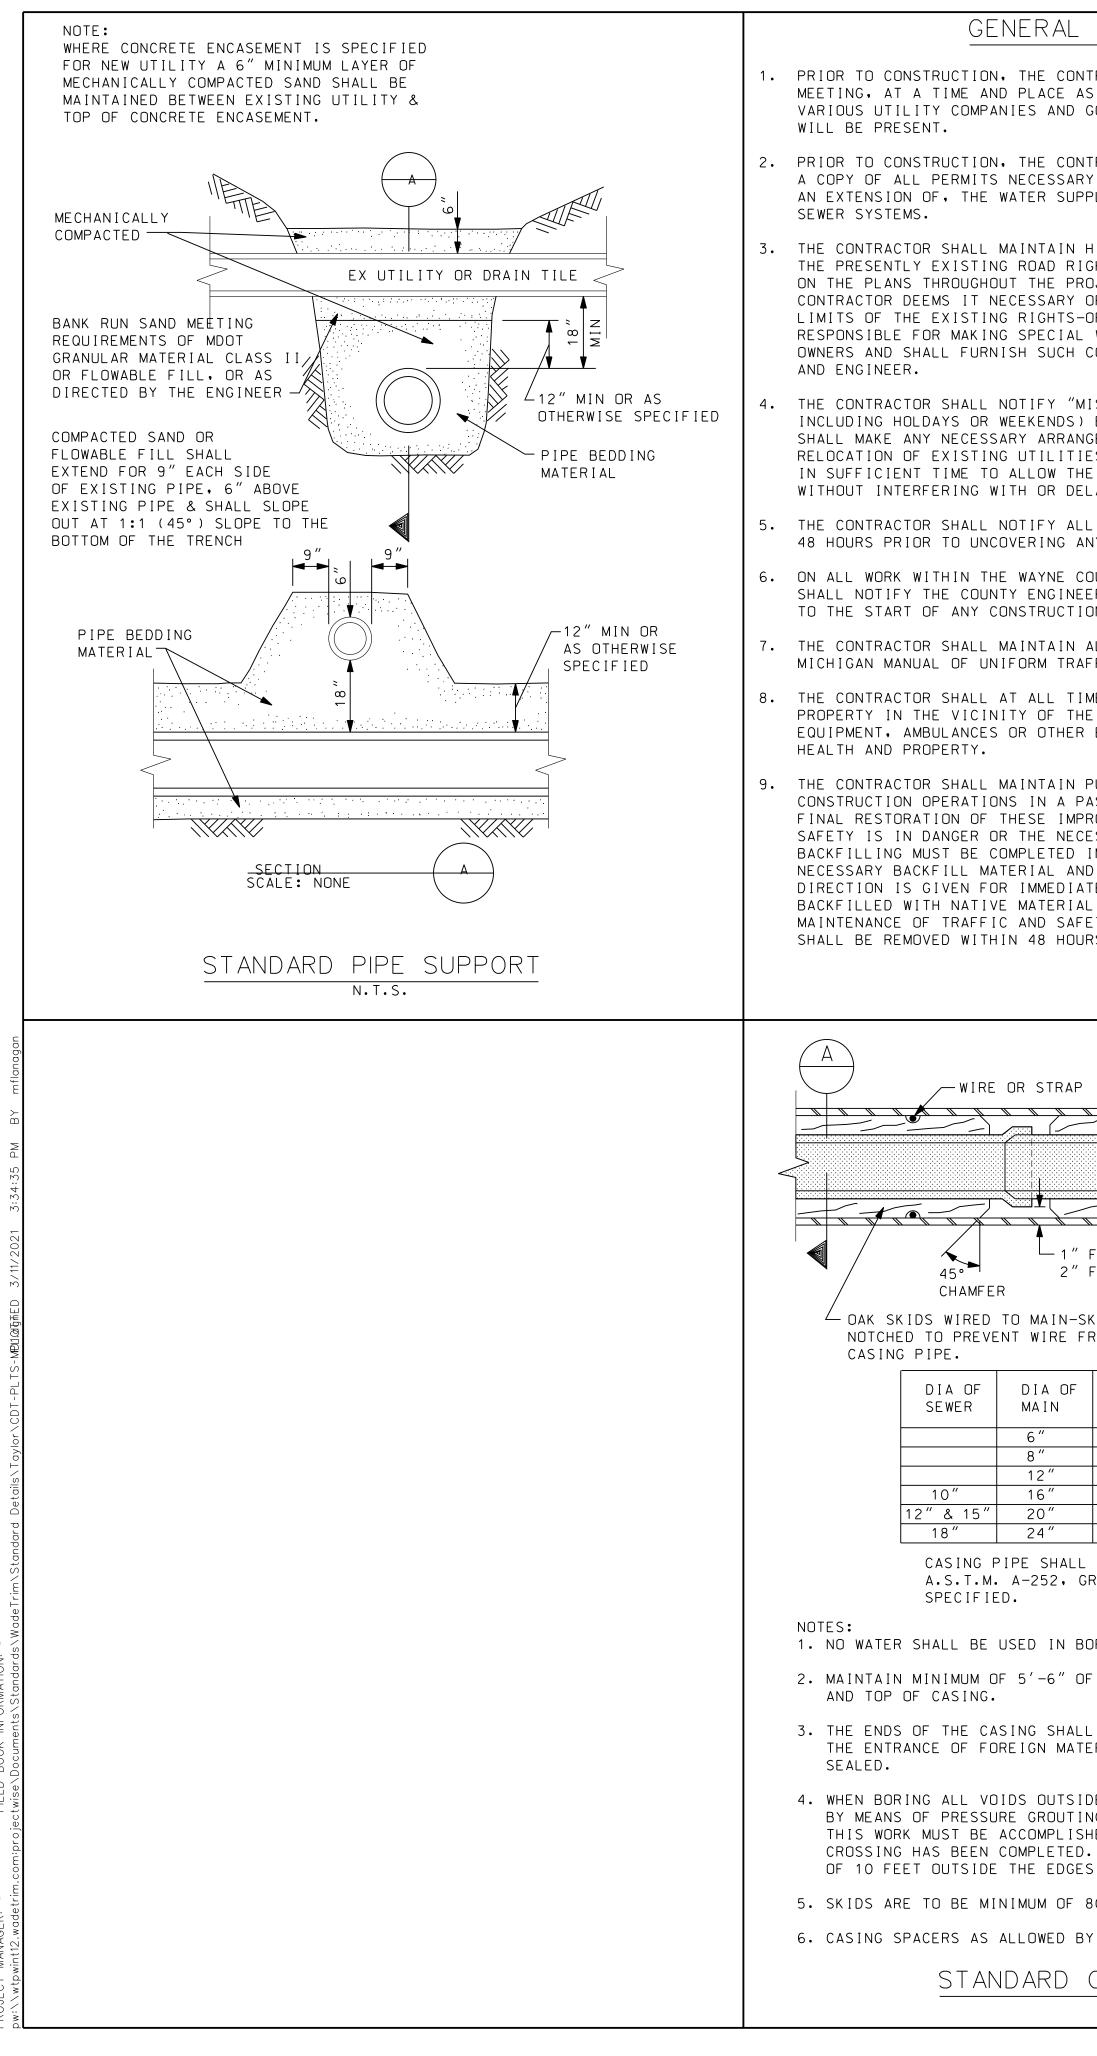
E	PLANTING SIZE	MATURE SIZE	QUANTITY
US	2'-0" HT.	4' - 6' HT	24
TALIS	2'-0" HT.	4'-0" HT	45
TALIS N'	5'-0" HT.	12'-0" HT	11
		TOTAL:	80
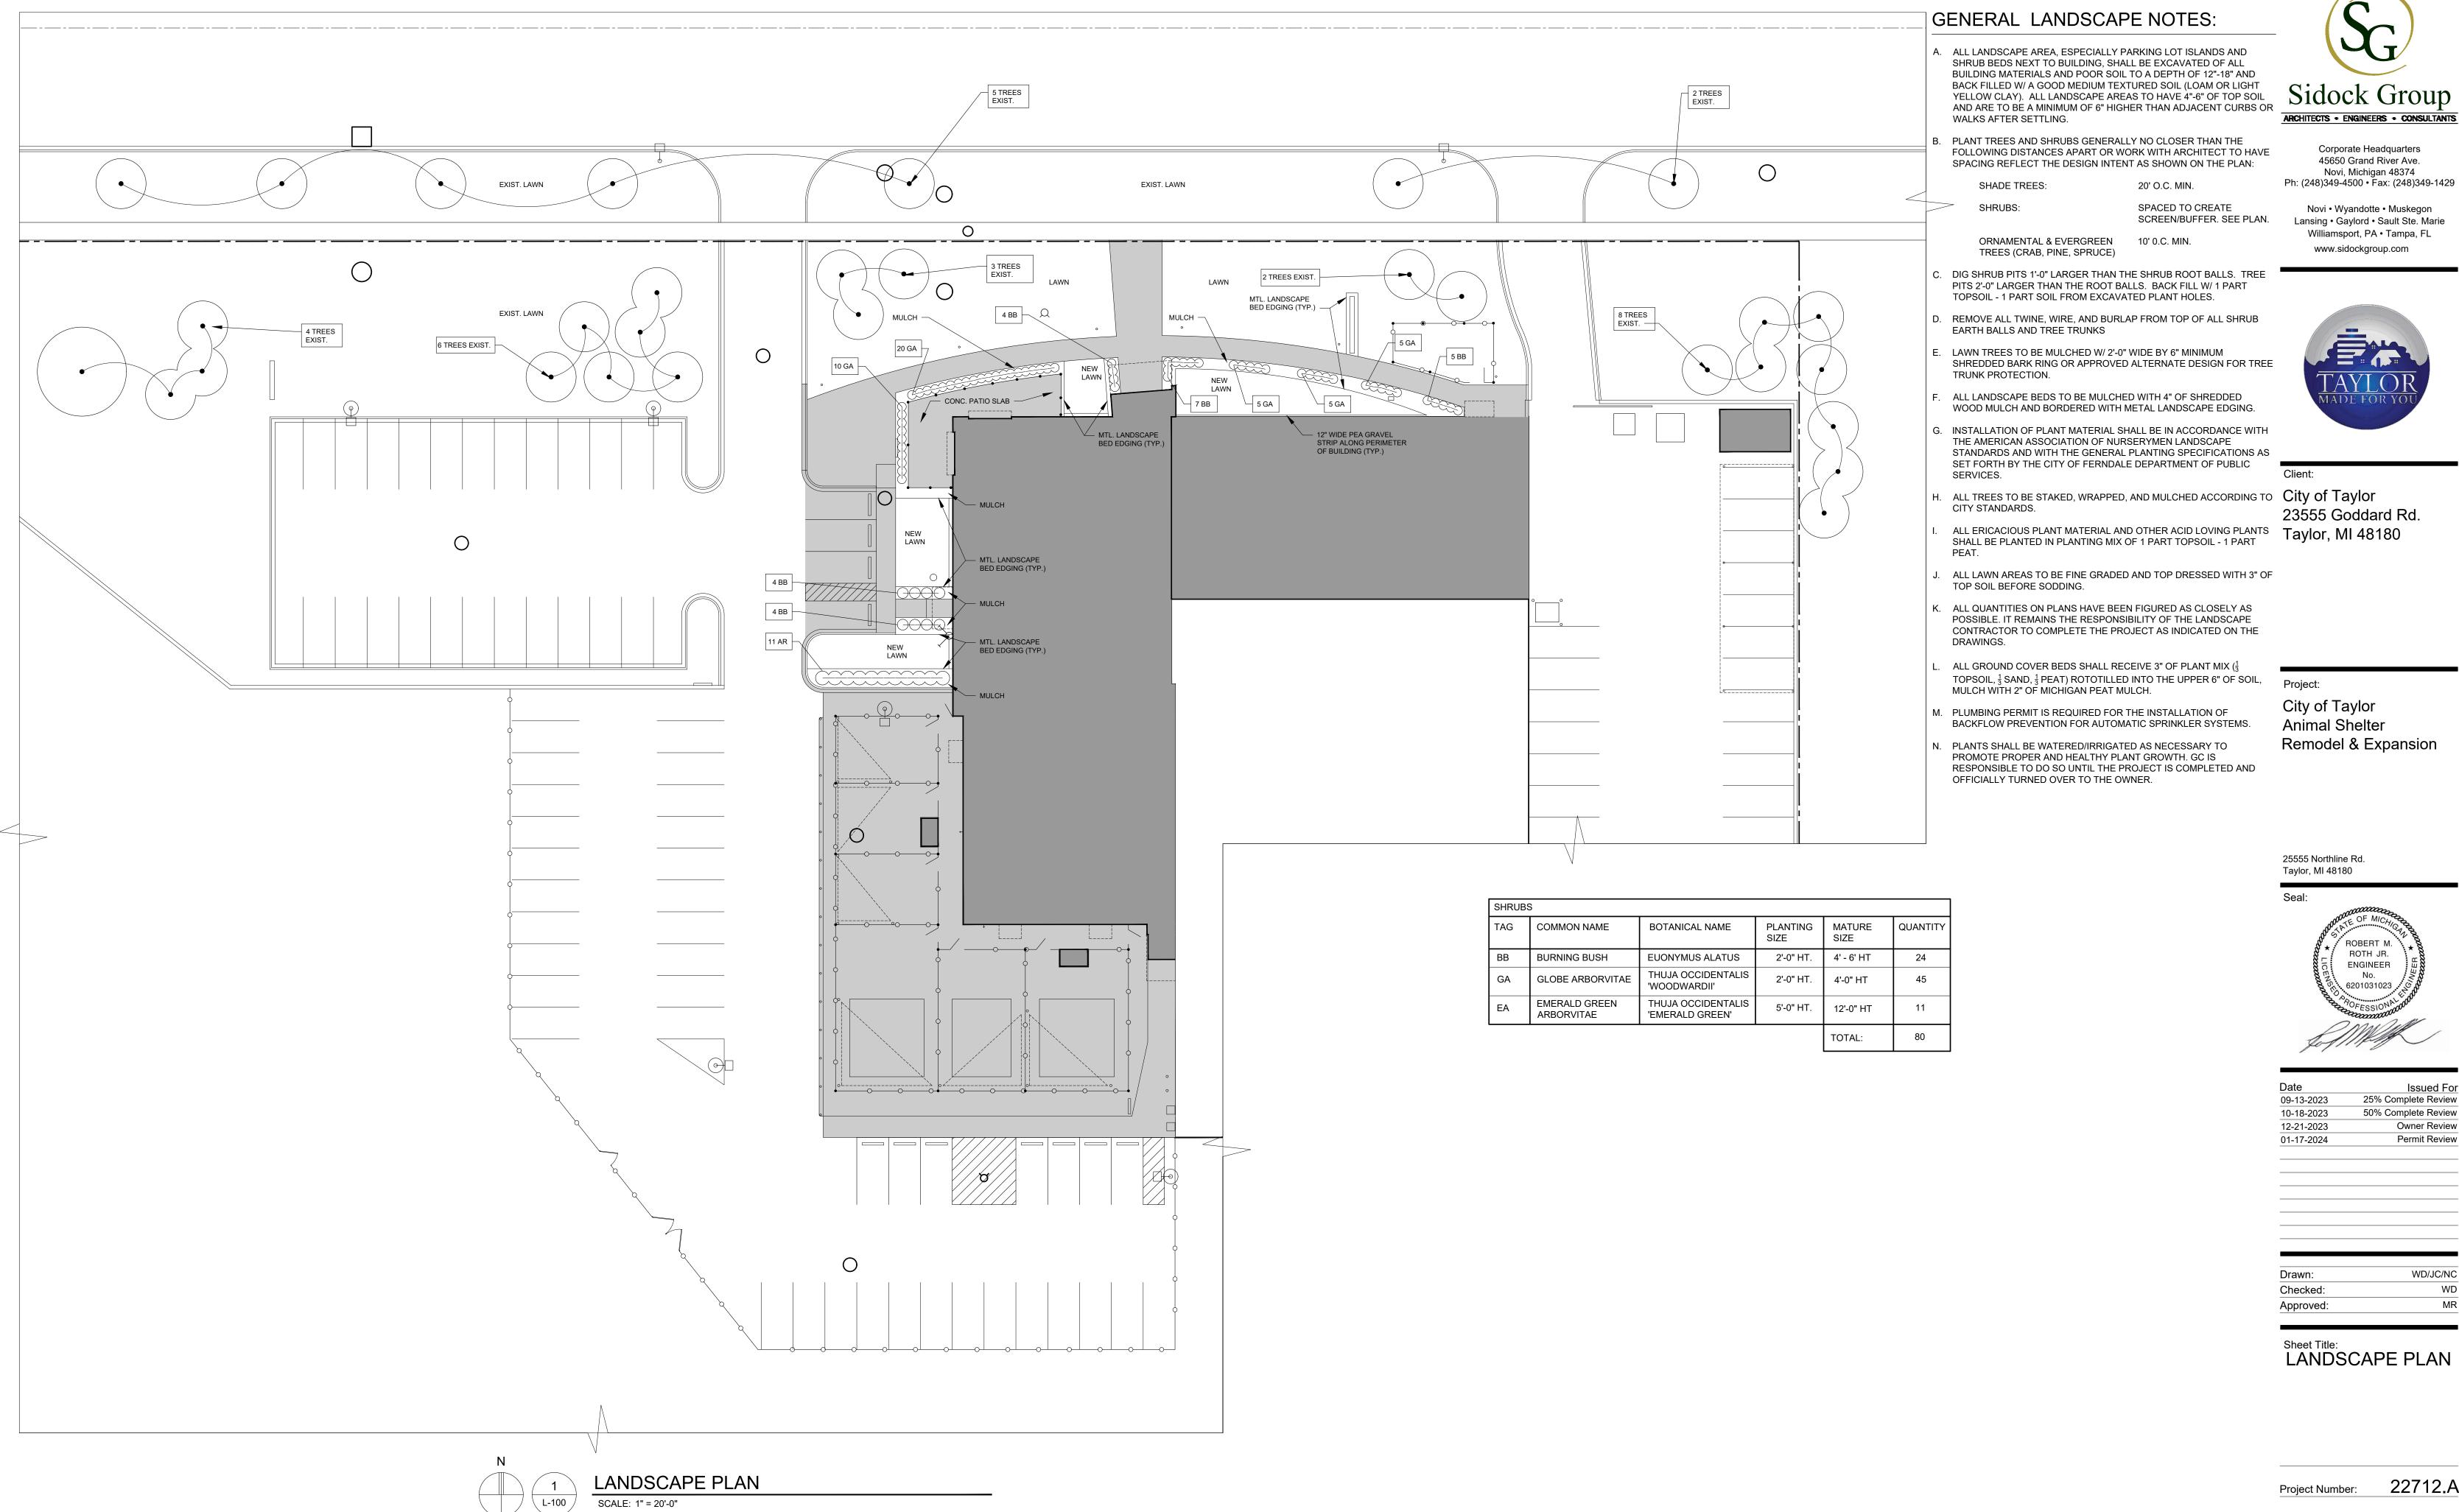
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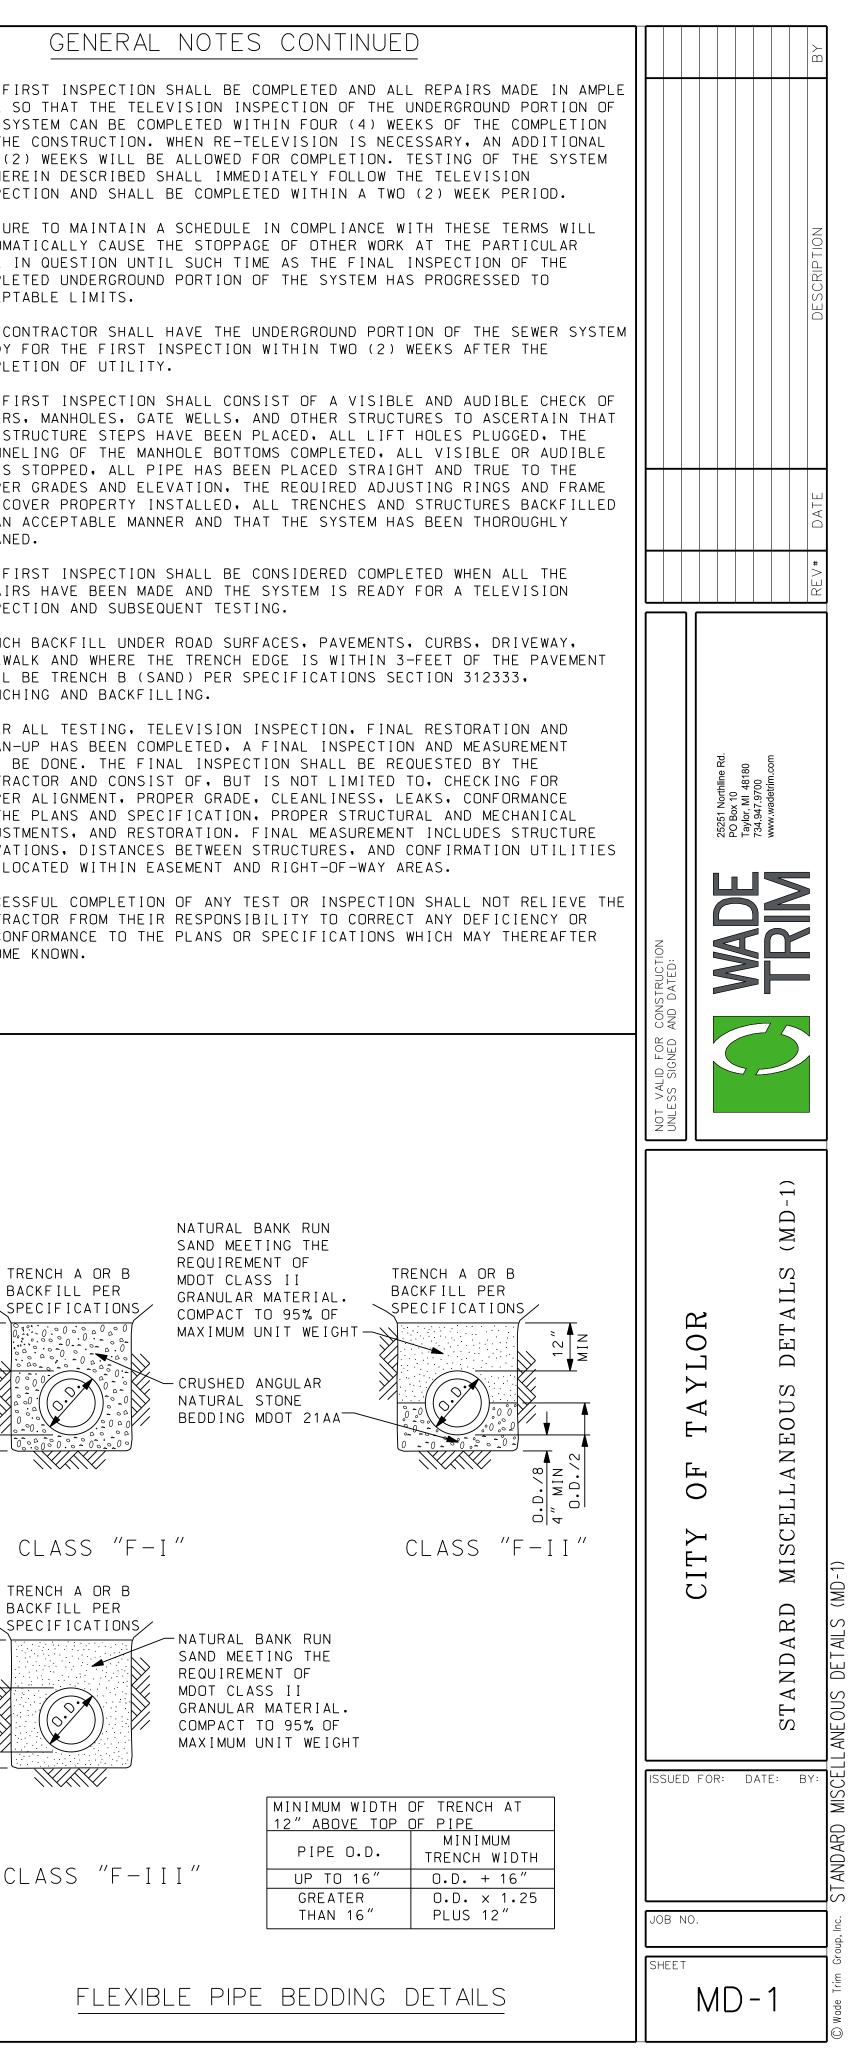
WD


MR

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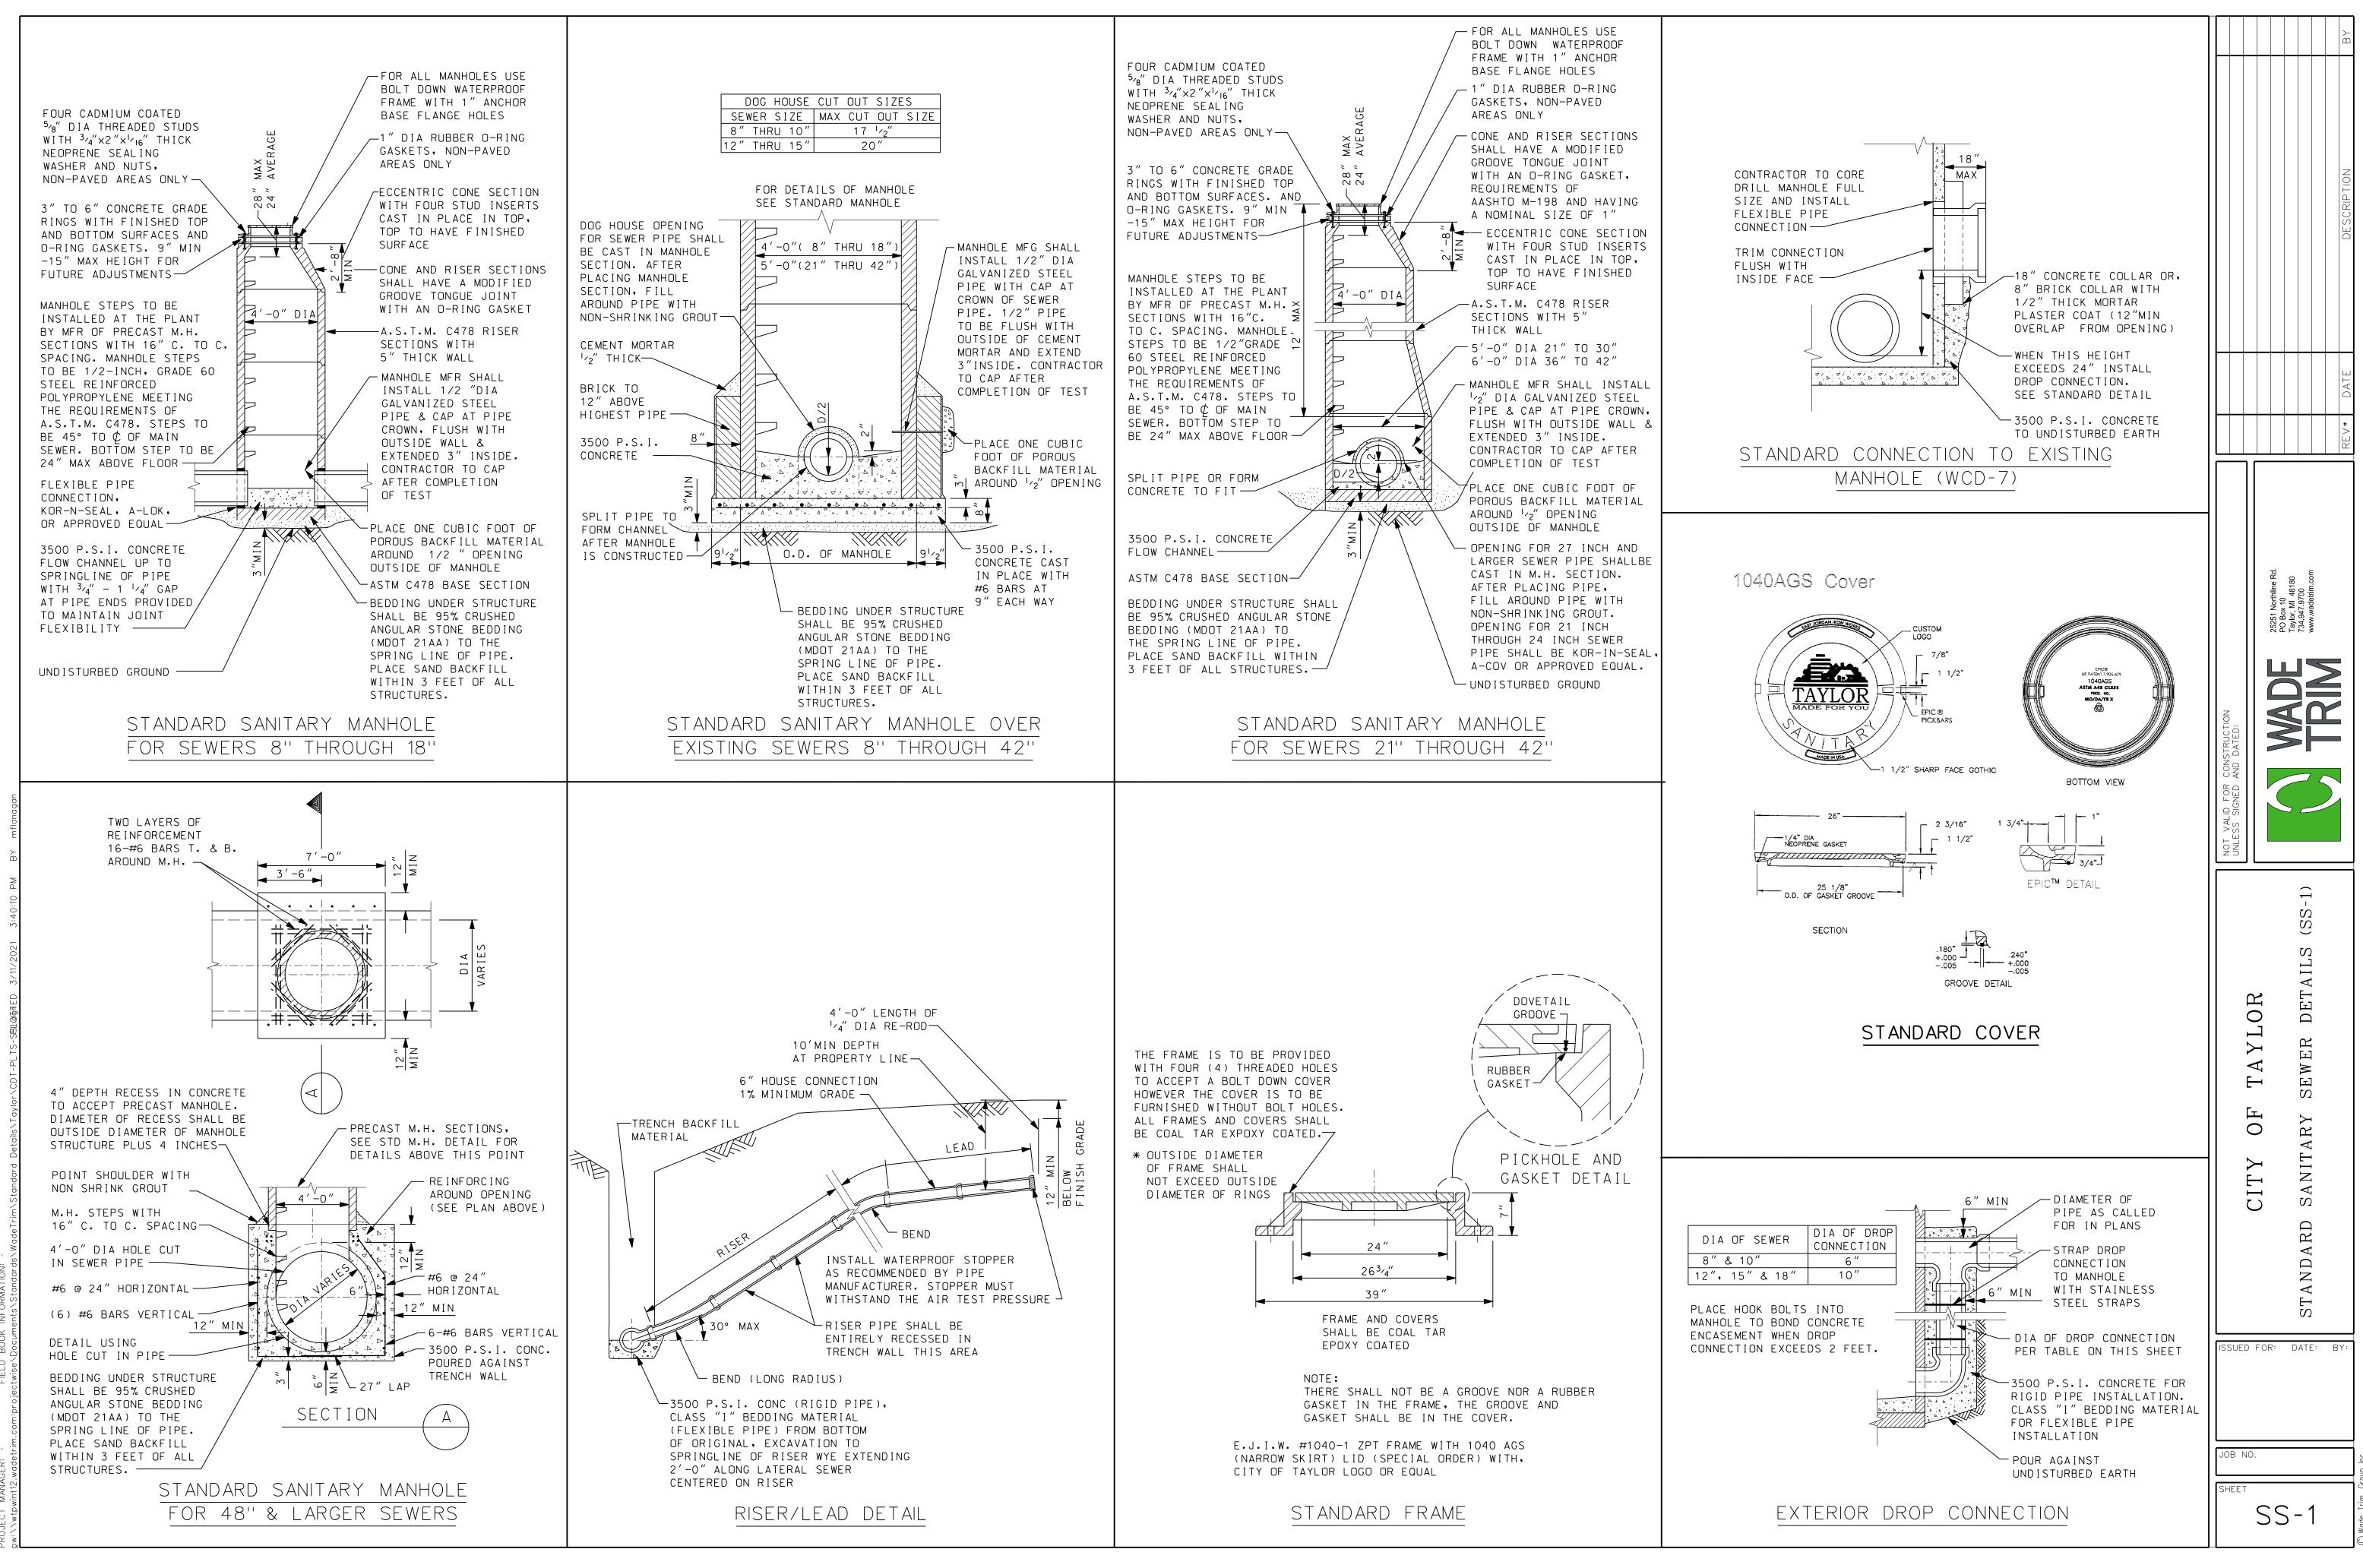


_ NOTES	general notes continued	
ONTRACTOR SHALL ATTEND A PRECONSTRUCTION AS ARRANGED BY THE COMMUNITY, IN WHICH O GOVERNMENTAL AGENCY REPRESENTATIVES	10. NO STREET, ROAD OR SECTION THEREOF SHALL BE CLOSED TO THROUGH TRAFFIC UNLESS AUTHORIZED BY THE AGENCY WITH JURISDICTION OVER THE ROADS. PRIOR TO CLOSING A STREET, ROAD, OR SECTION THEREOF, THE CONTRACTOR SHALL PROVIDE THE ENGINEER WITH A COPY OF A DETOUR PLAN APPROVED BY THE AGENCY HAVING JURISDICTION OVER THE ROADS.	19. THE FIF TIME SC THE SYS OF THE TWO (2
ONTRACTOR MUST HAVE IN HIS POSSESSION ARY TO CONSTRUCT A CONNECTION TO, OR JPPLY, SANITARY SEWER, OR STORM	11. IN THE EVENT ROADS ARE TO BE CLOSED, THE CONTRACTOR SHALL NOTIFY THE LOCAL FIRE DEPARTMENT, POLICE DEPARTMENT, LOCAL ROAD AUTHORITY, AMBULANCE AND EMERGENCY SERVICES, DEPARTMENT OF PUBLIC WORKS, PUBLIC TRANSIT AUTHORITY, PUBLIC SCHOOL SYSTEM, LOCAL TRASH PICKUP	AS HERE INSPEC 20. FAILURE AUTOMA
N HIS CONSTRUCTION OPERATIONS WITHIN RIGHTS-OF-WAY AND EASEMENTS AS NOTED PROJECT. IN THE EVENT THAT THE Y OR ADVISABLE TO OPERATE BEYOND THE S-OF-WAY OR EASEMENTS, HE SHALL BE AL WRITTEN AGREEMENTS WITH THE PROPERTY	AUTHORITY, AND PUBLIC AND PRIVATE UTILITIES DAILY AS TO WHAT STREETS WILL BE PARTLY BLOCKED OR CLOSED, THE LENGTH OF TIME THE STREETS WILL BE BLOCKED OR CLOSED AND WHEN THE STREETS WILL BE REOPENED TO TRAFFIC. 12. PAVED STREETS AND DRIVEWAYS SHALL BE MAINTAINED IN A REASONABLE	SITE IN COMPLE ACCEPTA 21. THE CON READY F
"MISS DIG" (800-482-7171) 3 DAYS (NOT S) BEFORE STARTING CONSTRUCTION, HE ANGEMENTS WITH UTILITY COMPANIES FOR	STATE OF CLEANLINESS AND THE CONTRACTOR SHALL REMOVE ACCUMULATIONS OF DEBRIS CAUSED BY HIS OPERATIONS. THE CONTRACTOR SHALL HAVE, AS A MINIMUM, AN OPERATING SWEEPER BROOM ON THE SITE AT ALL TIMES. THE PAVEMENT SHALL BE CLEANED AT THE CLOSE OF EACH DAYS OPERATION AND AS OFTEN AS NECESSARY BEFORE THAT TIME. FAILURE TO COMPLY SHALL BE CAUSE TO STOP CONSTRUCTION. CONTRACTOR SHALL ALSO COMPLY WITH THE	COMPLE 22. THE FIF SEWERS THE STF CHANNEL
TIES. THESE ARRANGEMENTS SHALL BE MADE THE RELOCATION WORK TO BE COMPLETED DELAYING THE SEWER CONSTRUCTION. ALL UTILITY COMPANIES AND THE ENGINEER ANY EXISTING UTILITIES.	LOCAL AIR POLLUTION CONTROL ORDINANCE. 13. ALL GRAVEL AND DIRT ROADS, STREETS OR DRIVEWAYS USED SHALL BE MAINTAINED BY GRADING, PLACING DUST PALLIATIVES, AND MAINTENANCE GRAVEL IN SUFFICIENT QUANTITIES TO ELIMINATE DUST AND MAINTAIN TRAFFIC AS DIRECTED BY THE AGENCY.	LEAKS S PROPER AND COV IN AN A CLEANE
COUNTY RIGHT-OF-WAY, THE CONTRACTOR NEER AND THE COMMUNITY 72 HOURS PRIOR TION.	14. CONTRACTOR SHALL PROVIDE ALL NECESSARY SHEETING, SHORING, DEWATERING, BRACING, TRENCH BOXES, ETC., TO PERFORM WORK SAFELY AND PROTECT EXISTING UTILITIES AND IMPROVEMENTS.	INSPEC
N ALL TRAFFIC AT ALL TIMES AS PER THE RAFFIC CONTROL DEVICES.	15. THE FLOW IN THE EXISTING SEWERS SHALL BE MAINTAINED AT ALL TIMES DURING CONSTRUCTION.	24. TRENCH SIDEWAL SHALL E TRENCH
TIMES PROVIDE EMERGENCY ACCESS TO THE CONSTRUCTION FOR POLICE AND FIRE ER EMERGENCY VEHICLES TO PROTECT LIFE,	 16. CULVERTS, DITCHES, DRAIN TILES, TILE FIELD, DRAINAGE STRUCTURES, ETC., THAT ARE DISTURBED BY THE CONTRACTOR'S OPERATIONS SHALL BE IMMEDIATELY RESTORED. 17. ALL DRODEDIX, LOONS AND MONUMENTS, LE DISTURDED OD DESTROYED BY THE 	25. AFTER A Clean-l Will Be
N PUBLIC ROADS AFFECTED BY THE PASSABLE CONDITION UNTIL SUCH TIME AS MPROVEMENTS CAN BE MADE. IF THE PUBLIC ECESSITY EXISTS FOR MAINTAINING TRAFFIC.	 17. ALL PROPERTY IRONS AND MONUMENTS, IF DISTURBED OR DESTROYED BY THE CONTRACTOR'S OPERATION, SHALL BE REPLACED BY A LICENSED LAND SURVEYOR AT THE CONTRACTOR'S EXPENSE. 18. AFTER ALL THE PIPE, STRUCTURES, ETC., HAVE BEEN LAID, CONSTRUCTED, 	CONTRAC PROPER TO THE ADJUSTN ELEVAT
) IMMEDIATELY. IN THE EVENT THAT THE AND EQUIPMENT ARE NOT AVAILABLE WHEN LATE BACKFILL, THE TRENCH SHALL BE LAL TO PROVIDE FOR THE NECESSARY AFETY; HOWEVER, THE NATIVE MATERIAL DURS AND THE TRENCH PROPERLY BACKFILLED.	AND BACKFILLED, THE SYSTEM SHALL BE TESTED AND FINAL INSPECTED. THE INSPECTION AND TESTING SHALL CONSIST OF A FIRST INSPECTION, TELEVISION INSPECTION (IF APPLICABLE) TESTING, AND FINAL INSPECTION AND MEASUREMENT. THE CONTRACTOR SHALL PROVIDE THE NECESSARY SUPERVISION, LABOR, TOOLS, EQUIPMENT, AND THE MATERIALS NECESSARY FOR THE TESTS WHICH SHALL BE CONDUCTED IN THE PRESENCE OF THE ENGINEER. THE ENGINEER SHALL BE NOTIFIED TWO (2) WORKING DAYS IN ADVANCE OF ALL TESTING.	ARE LOO 26. SUCCESS CONTRAC NONCONF BECOME
AP TOTAL STREAM OF THE LENGTH. AP AP AP AP AP AP AP AP AP AP	NATURAL BANK RUN SAND MEETING THE REQUIREMENT OF MODT CLASS II GRANULAR MATERIAL. COMPACT TO 95% OF MAXIMUM UNIT WEIGHT SPECIFICATIONS SECONCRETE ARCH CRUSHED ANCULAR NATURAL STORE BEDDING MODT 21AA CLASS "R-A" TRENCH A OR B BACKFILL PER SPECIFICATIONS THENCH A OR B BEDDING MODT 21AA CLASS "R-A" TRENCH A OR B BACKFILL PER SPECIFICATIONS TRENCH A OR B BACKFILL PER SPECIFICATIONS THENCH A OR B BACKFILL PER NATURAL BANK RUN SAND MEETING THE SPECIFICATIONS TRENCH A OR B BACKFILL PER SPECIFICATIONS TRENCH A OR B BACKFILL PER SPECIFICATIONS TRENCH A OR B BACKFILL PER SPECIFICATIONS TRENCH A OR B BACKFILL PER SPECIFICATIONS MAXIMUM UNIT WEIGHT MAX WIDTH OF TRENCH AT 12" ABOVE TOP OF PIPE 6" THRU 12" PIPE - 30" WIDE 15" THRU 36" PIPE - 0.D. +16" 42" THRU 60" PIPE - 0.D. +16" 42" THRU 60" PIPE - 0.D. +16" ABOVE THE OF PIPE SHALL BE 6" ON EACH SIDE OF PIPE	TR BA NIM NIM NIM NIM NIM NIM NIM NIM NIM NIM
CASING SECTON	RIGID PIPE BEDDING DETAILS	
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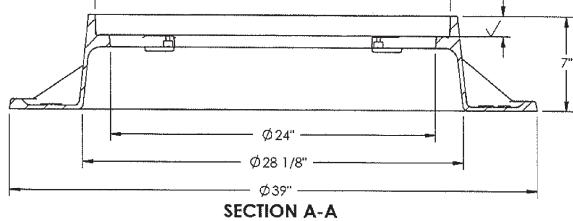




ROSION AND SEDIMENTATION CONTROL NOTES			B
D IT BE NECESSARY FOR THE CONTRACTOR TO DEWATER THE GROUND IN OURSE OF CONSTRUCTING THE PROPOSED UTILITY. THE CONTRACTOR FILTER ALL DISCHARGE THROUGH A DISCHARGE FILTER BAG. THAT WILL R ALL DISCHARGED WATER FROM THE DEWATERING OPERATION. IN NO NCE SHALL THE DEWATERING DISCHARGE BE PERMITTED TO FLOW TERED FROM THE CONSTRUCTION SITE.			
ONTRACTOR SHALL CONTROL THE DUST ON THE SITE DURING THE LIFE E CONTRACT. IN ACCORDANCE WITH THE SPECIFICATIONS AND THE REMENTS OF THE COMMUNITY THIS DUST CONTROL SHALL BE ACCOMPLISHED E APPLICATION OF A POSITIVE DUST PICK-UP METHOD WITH WATER ON SURFACES. SUCH DUST CONTROL MATERIALS SHALL BE APPLIED AS OFTEN NECESSARY IN THE OPINION OF THE COMMUNITY TO CONTROL THE DUST.			DESCRIPTION
D THE SOIL EROSION CONTROL REQUIREMENTS BE NEGLECTED OR NOT ATELY FOLLOWED, THE COMMUNITY MAY REQUIRE THE CONTRACTOR TO CONSTRUCTION OPERATIONS AND TO APPLY HIS ENTIRE FORCE TO MEET EQUIREMENTS BEFORE PROCEEDING FURTHER WITH THE PROJECT.			
EROSION AND SEDIMENTATION CONTROL SHALL BE IN ACCORDANCE WITH 91 SOIL EROSION AND SEMIMENTATION CONTROL(SESC), OF THE AL RESOURCES AND ENVIRONMENTAL PROTECTION ACT (NREPA), PA 451, AS AMENDED.			
ON AS POSSIBLE, COMPLETE FINAL GRADING AND PLACING OF PERMANENT EROSION CONTROL DEVICES, AFTER ESTABLISHMENT OF PERMANENT ATION, REMOVE ALL TEMPORARY SOIL EROSION CONTROL MEASURES.			REV # DA.
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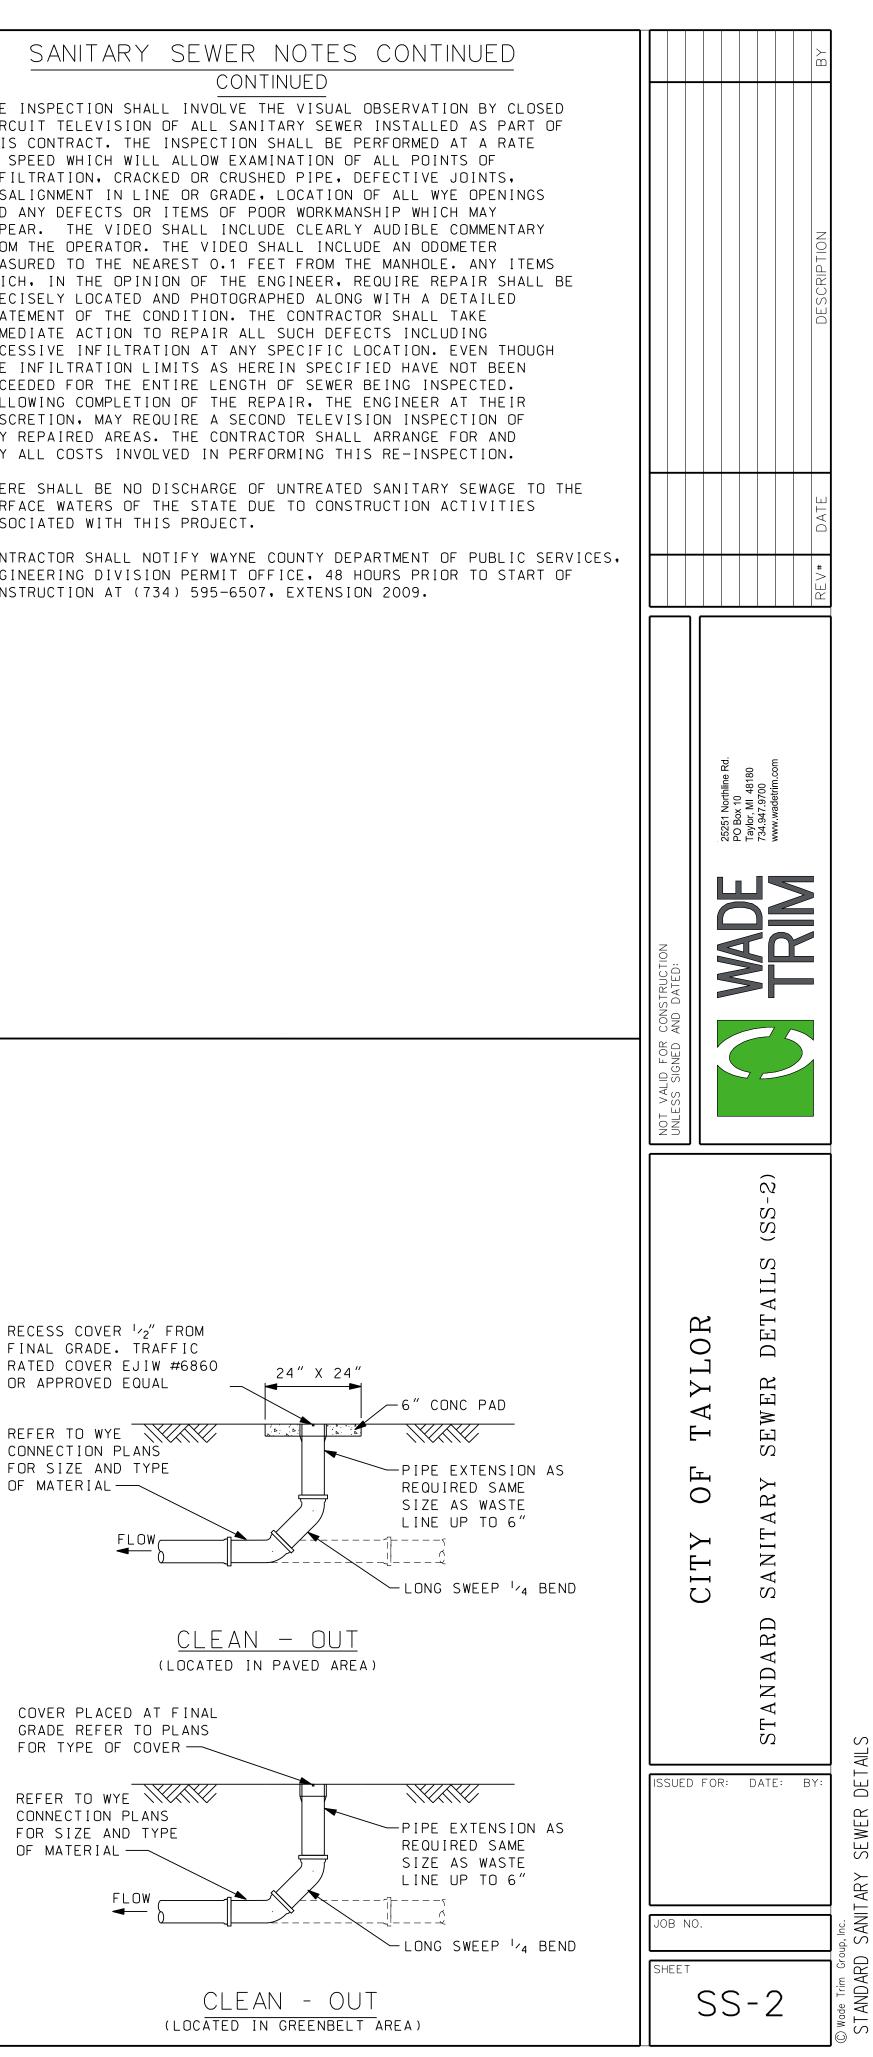


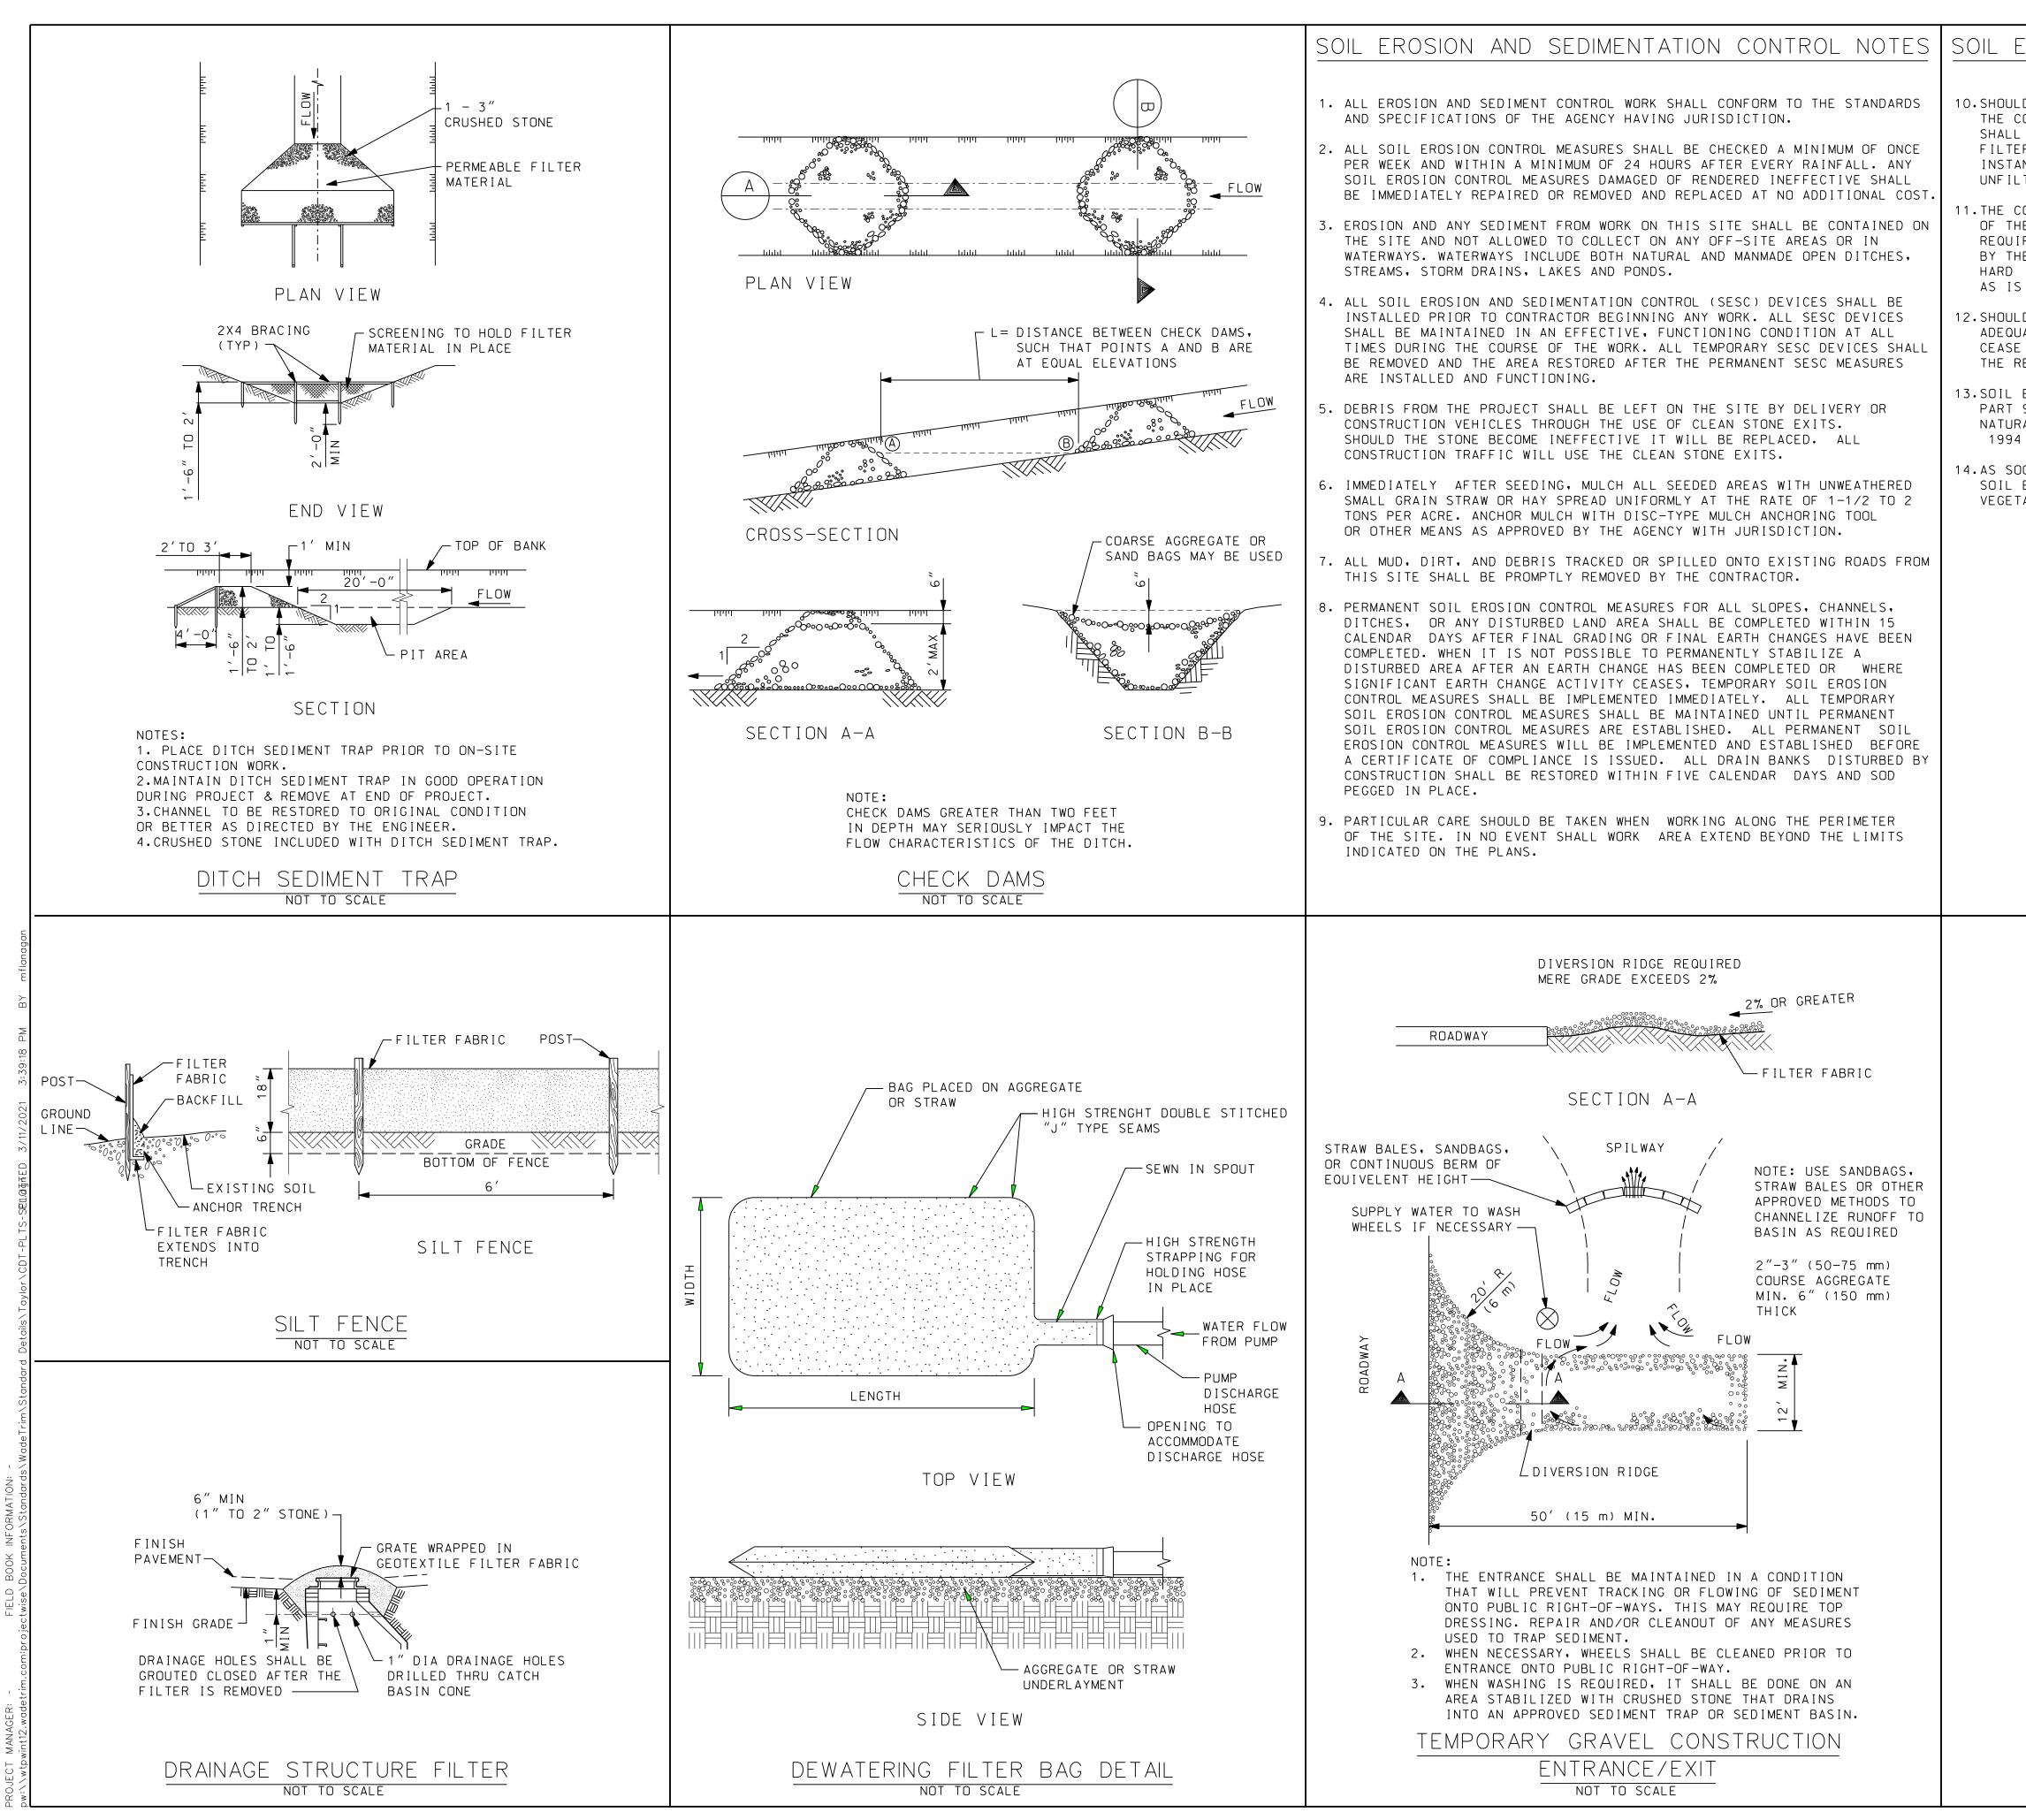
	CITY OF TAYLOR NOTES		SANITARY SE
۱.	SANITARY SEWER MAIN PIPE SHALL BE A MINIMUM OF 10-INCH DIAMTER: -REINFORCED CONCRETE ASTM C76, CL-IV WITH PREMIUM RUBBER JOINTS -VITRIFIED CLAY, ASTM C700 E.S., WITH RUBBER JOINTS PER ASTM C425	1.	ALL SEWER SYSTEM CONSTRUCTION SH AND GENERAL SPECIFICATION OF THE OTHER AGENCY HAVING JURISDICTION
	-PVC TRUSS PIPE PIPE, ASTM 02680, WITH ROBBER 001RTS PER ASTM 03212 -PVC SOLID WALL PIPE, ASTM 03034, SDR 26 FOR SIZES 8-INCH THROUGH 15-INCH PIPE, OR ASTM F679 FOR SIZES 18-INCH THROUGH 27-INCH. PLASTIC PIPE SHALL NOT BE USED IN INDUSTRIAL AREAS.	2.	DETAILS ARE FOR STRUCTURES WITH 180° APART. LARGER DIAMETER STRU CONFIGURATIONS.
•	SANITARY SEWER LEADS SHALL BE: C700 ES VITRIFIED CLAY PIPE WITH PREMIUM JOINTS FOR INDUSTRIAL USE AND PVC PIPE, ASTM D3034, SDR 23.5, 6-INCH, AND SDR 26 FOR 8-INCH FOR	3.	THE MANHOLE STRUCTURE REQUIRES A BETWEEN PIPE OPENINGS. LARGER DI WHERE PIPE ENTERING THE STRUCTUR DIRECTION.
	COMMERCIAL AND RESIDENTIAL USE. THE REQUIRED PIPE BEDDING IS MAXIMUM 3/4-INCH DIAMTER CRUSHED STONE.	4.	CONSTRUCTION SHALL NOT COMMENCE OWNER PRESENT.
•	TRENCH "A" BACKFILL MATERIAL USED MUST BE FREE OF LARGE LUMPS OF CLAY, DEBRIS, AND ROCKS.	5.	ALL MANHOLES SHALL USE ECCENTRIC THE ROAD UNLESS DIRECTED OTHERWI
•	TRENCH "B" SAND BACKFILL IS REQUIRED FOR SANITARY SEWER TRENCH LOCATED UNDER OR WITHIN THREE FEET OF PAVEMENT.	6.	ALL MANHOLES SHALL BE PROVIDED W RIMS SHALL BE SET TO GRADE OR AS
	THE MINIMUM SLOPE FOR THE BUILDING LEAD IS 1.0 PERCENT.	7.	
•	ALL PRECAST PRODUCTS SHALL CONFORM TO THE REQUIRMENTS OF ASTM C-478.	8.	DIFFERENTIAL OF EXCAVATION AROUN SIX FEET.
•	CLEANOUTS SHALL BE PROVIDED AT EVERY BEND, EVERY 100 LINEAL FEET AND PLACED 5 FEET FROM THE BUILDING. FRAME AND COVERS SHALL BE SPECIFIED AS FOLLOWS:	9.	EXTERIOR DROP CONNECTIONS ARE RE 2.0 FEET OR GREATER ABOVE THE MA DROP CONNECTIONS ARE NOT ALLOWE
	A. FRAME SHALL BE EJ 1040-1ZPT B. COVER SHALL BE 1040AGS (SANITARY) WITH CITY LOGO	10.	NO SEWERS SHALL BE CONSTRUCTED L SPECIFIC APPROVAL OF THE COMMUNI
		11.	ALL RIGID SANITARY SEWER PIPE SH FLEXIBLE PIPE SHALL BE CLASS "F- NOTED ON THE PLANS, SEE SHEET MD
		12.	PLACE ONE 6-INCH WYE FOR EACH LO WIDTH OR EVERY 100 FEET FOR LOTS ON SANITARY SEWERS UNLESS OTHERW
		13.	NO CONNECTION RECEIVING STORM WA WATER SHALL BE MADE TO SANITARY
			NO FOOTING DRAINS SHALL BE CONNE
		15.	RISERS ON SANITARY SEWERS SHALL WHERE SEWER IS OVER 12 FEET.
		16.	PRIOR TO THE BACKFILLING OF A SE SHALL BE PLACED FROM A POINT IMM CONNECTION TO 2-FOOT BELOW THE F THE MARKER ON ANY PORTION OF THE
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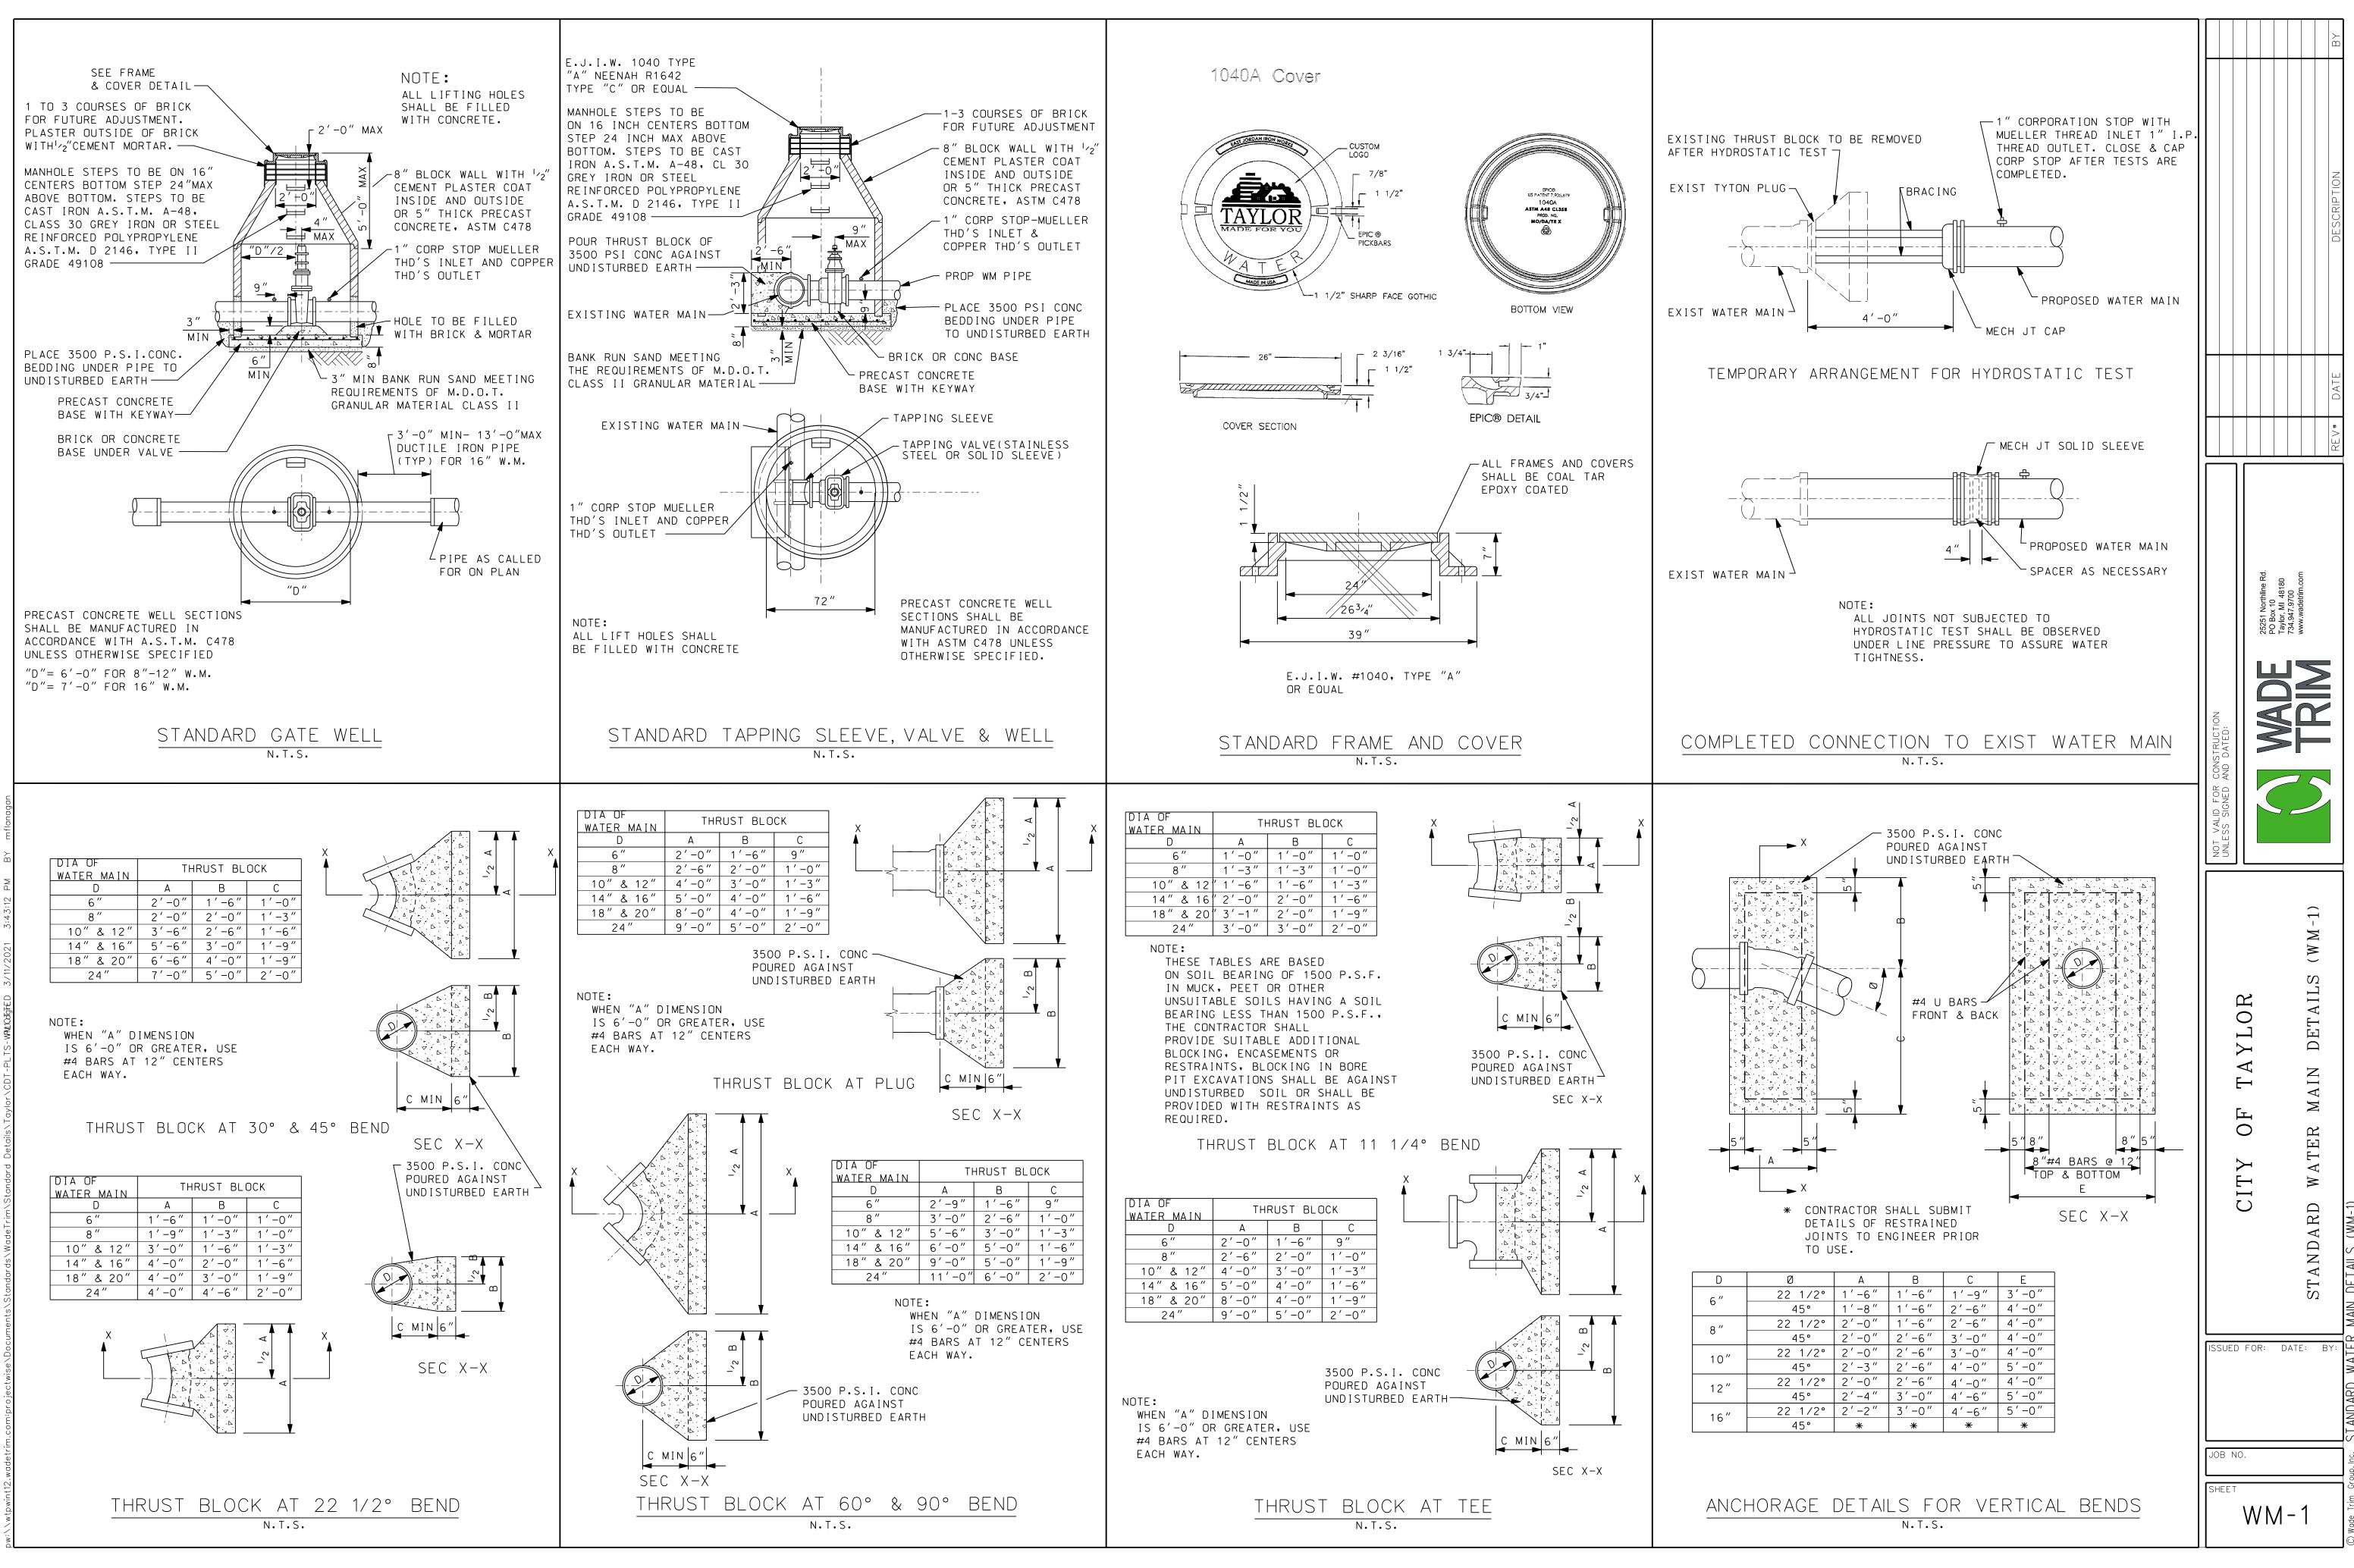



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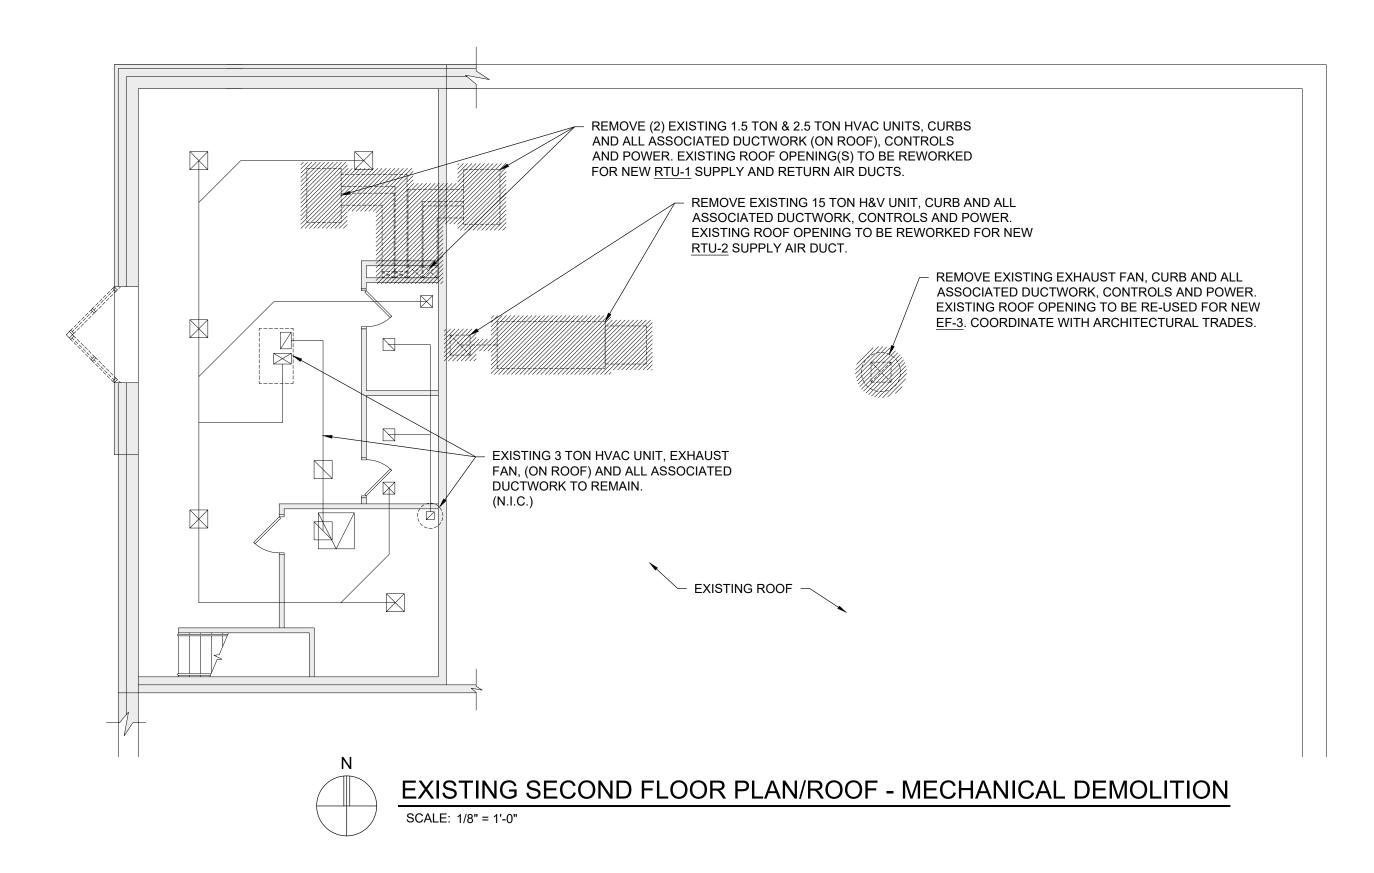
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 Construction of the construction of the construction	SHALL CONFORM TO THE CURRENT STANDARDS THE COMMUNITY SEWER DEPARTMENT AND ANY		C	IRCU
 All seves below is consistent with the seven is set to be a set to be set to	TH NO MORE THAN TWO PIPES ENTERING, TRUCTURES MAY BE REQUIRED FOR DIFFERENT	EXCEED 100 GALLONS PER INCH DIAMETER PER MILE OF SEWER PER 24 HOURS AND SHALL INCLUDE THE INFILTRATION FROM ALL MANHOLES AND OTHER	OF I N M	F SP NFIL ISAL
 a M. Hall A Rescalations Let 11:11 - 2013 - 2014 - 2	S A MINIMUM OF 8 INCHES OF CONCRETE WALL DIAMETER STRUCTURES MAY BE REQUIRED TURE ARE LESS THAN 90° APART IN ANY	TESTS, OR A COMBINATON OF SAME, PRIOR TO ACCEPTANCE. ALL SEWERS OVER 24-INCH DIAMETER SHALL BE SUBJECTED TO INFILTRATION TESTS. ALL SEWERS OF 24-INCH DIAMETER OR SMALLER, WHERE THE GROUND WATER LEVEL ABOVE THE TOP OF THE SEWER IS OVER SEVEN FEET, SHALL BE SUBJECTED	AF FF ME WF PF	PPEA ROM EASU HICH RECI
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 HECH DREW HERE WERE AVER 1 TO THE AND ALL AND ALL		CONTRACTOR SHALL DETERMINE THE LOCATION OF THE LEAKS, REPAIR THEM, AND RETEST THE SEWER. THE TEST SHALL BE REPEATED UNTIL SATISFACTORY RESULTS ARE OBTAINED. TELEVISION INSPECTION SHALL BE CONSIDERED	SI AS	URFA SSOC
 23. THE OPERATION SHALL SHOULD STATE WITHOUT INTO A CONTRACTOR SHALL PROVIDE UP TO THE CONTRACT TO THE CONTRACT	MANHOLE FLOW CHANNEL INVERT. INTERIOR	THE INSTALLATION RETELEVISED AND THE SYSTEM IS ACCEPTABLE FOR THE	EN	NGIN
 A ALL SPESSION MULTES STUTEWESS WIT OF BALLING DEVISION A ALL SPESSION TO FEEST ON THE SECOND THE SECOND	D LESS THAN 10-INCH DIAMETER WITHOUT JNITY SEWER DEPARTMENT.	SANITARY SEWER LINES. ALL SANITARY LEADS FOR COMMERCIAL AND INDUSTRIAL SITES OVER 100 FEET IN LENGTH MUST BE AIR TESTED AND		
 CHEER ANTER. THE CHEMPAGE TRACK TOTAL FUNCTION AND ALL DUPLIESS ANTERNATION AND ALL DUPLIESS AND AND ALL DUPLIESS ANTERNATION AND ALL DUPLIESS AND AND AND ALL DUPLIESS AND ALL DUPLIESS AND ALL DUPLIESS AND ALL DUP	"F-I" BEDDING, UNLESS OTHERWISE MD1 FOR BEDDING DETAILS. LOT OR PARCEL 100 FEET OR LESS IN	PRIOR TO PLACING THE SEWER IN SERVICE. COPIES OF THE TELEVISION RECORDING (DVD FORMAT) NEED TO GO TO THE COMMUNITY AND THE ENGINEER PRIOR TO THE CONTRACTOR LEAVING THE SITE. THE TELEVISION INSPECTION		
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LL BE THETALLED TO A DEPTH OF TO FEET SUPPLICIENCE A 27 MY 27 PTICL DU KUCD SERVICE CONSTRUCTION OF STOREST UNIT STRUCT CONSTRUCT OF STOREST UNIT STRUCT OF STOREST	NNECTED TO THE BUILDINGS SANITARY SEWER.	26. THE TELEVISION INSPECTION SHALL BE OBERVED BY REPRESENTATIVES OF		
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OLES EQUALLY OLES EQUALLY Ø333/4"B.C. UDUE CATERNAL FRAME SEAL DETAIL OLES EQUALLY OLES EQUALLY OLES EQUALLY TWO LAYERS. 6 MIL POL YETHYLENE. LAP ALL JOINTS 1-FOOT MINIMUM (OUTER LAYER) BACKFILL WITH COMPACTED SAND 1/2 " HYDRAULIC CEMENT MORTAR COAT INSIDE AND OUT PRECAST CONCRETE MANHOLE CONE SECTION * OUTSIDE DIAMETER OF FRAME SHALL NOT EXCEED OUTSIDE DIAMETER OF STUDIANCUS PAYED AREAS. ALL OTHER AREAS SHALL USE BOLT DOWN FRAMES WITH RUBBER O-RINGS AS SHOWN ON MANHOLE DETAILS. EXTERNAL FRAME SEAL DETAIL		RINGS RUBBER COATING		OF
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MANHOLE CONE SECTION —/ * OUTSIDE DIAMETER OF FRAME SHALL NOT EXCEED OUTSIDE DIAMETER OF RINGS NOTE: THIS DETAIL TO BE USED IN CONCRETE OR BITUMINOUS PAVED AREAS. ALL OTHER AREAS SHALL USE BOLT DOWN FRAMES WITH RUBBER O-RINGS AS SHOWN ON MANHOLE DETAILS. <u>EXTERNAL FRAME SEAL DETAIL</u>		MORTAR COAT INSIDE AND OUT		G
NOTE: THIS DETAIL TO BE USED IN CONCRETE OR BITUMINOUS PAVED AREAS. ALL OTHER AREAS SHALL USE BOLT DOWN FRAMES WITH RUBBER O-RINGS AS SHOWN ON MANHOLE DETAILS. EXTERNAL FRAME SEAL DETAIL	-	MANHOLE CONE SECTION —/		
THIS DETAIL TO BE USED IN CONCRETE OR BITUMINOUS PAVED AREAS, ALL OTHER AREAS SHALL USE BOLT DOWN FRAMES WITH RUBBER O-RINGS AS SHOWN ON MANHOLE DETAILS. EXTERNAL FRAME SEAL DETAIL	n 	FRAME SHALL NOT EXCEED OUTSIDE DIAMETER OF RINGS		F١
		THIS DETAIL TO BE USED IN CONCRETE OR BITUMINOUS PAVED AREAS, ALL OTHER AREAS SHALL USE BOLT DOWN FRAMES WITH RUBBER		
FOR PAVED AREAS ONLY		EXTERNAL FRAME SEAL DETAIL		
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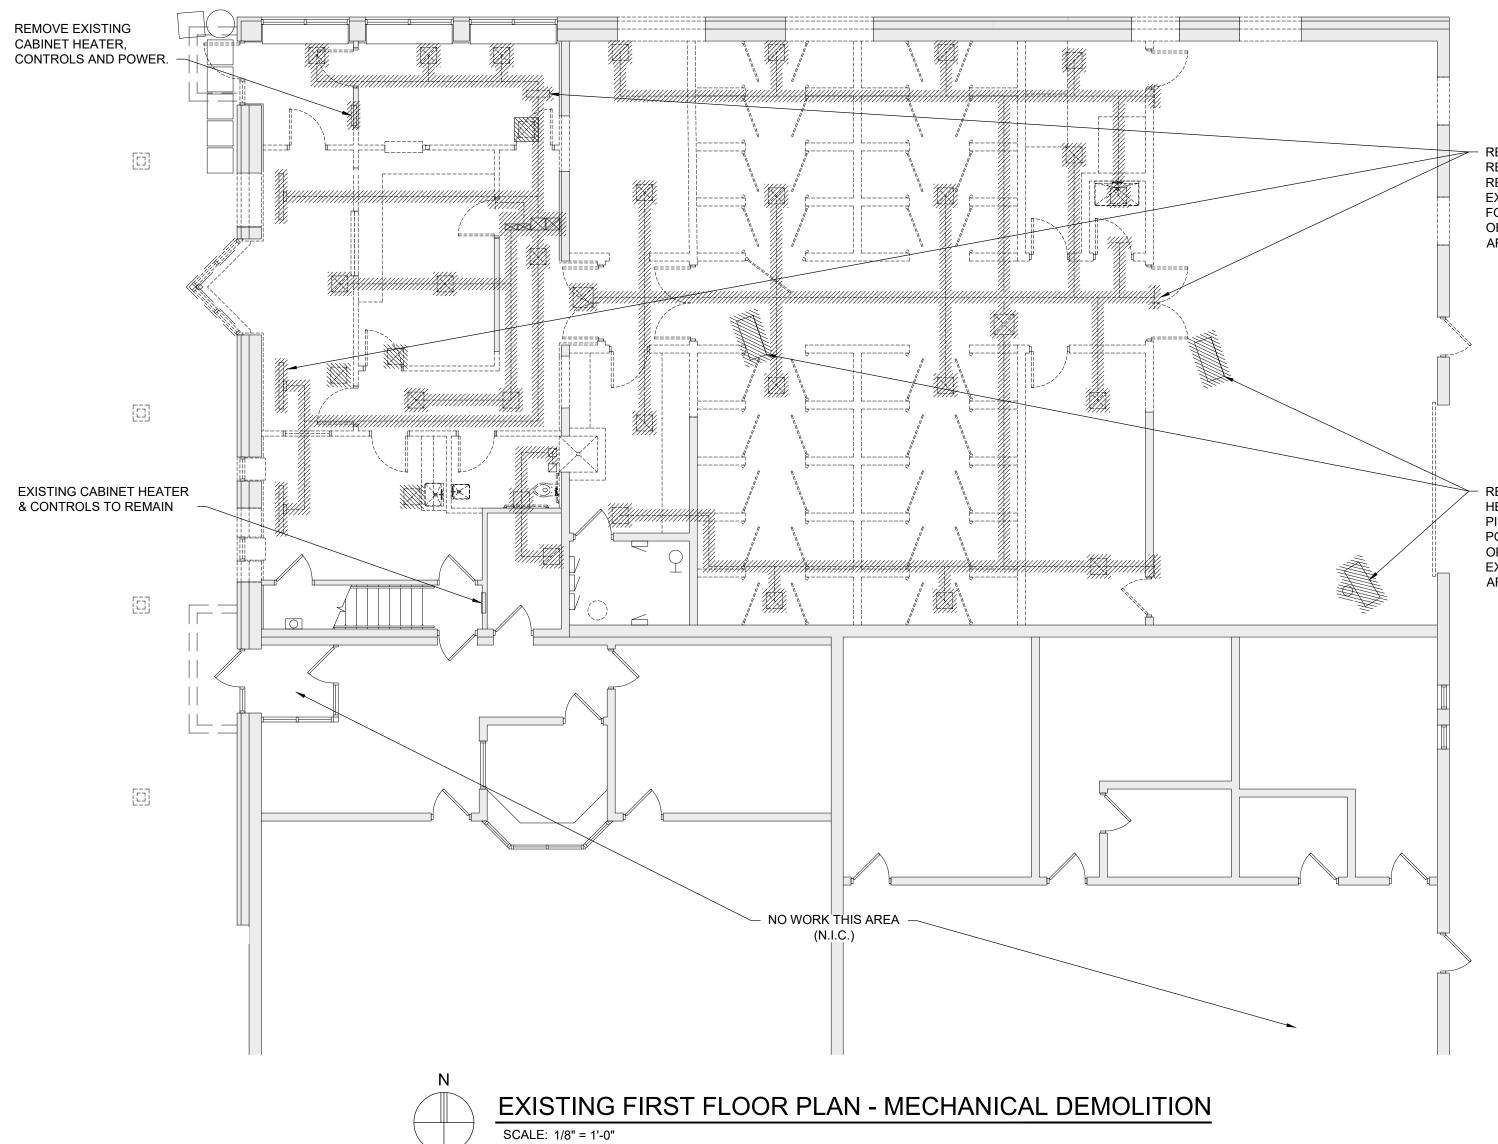








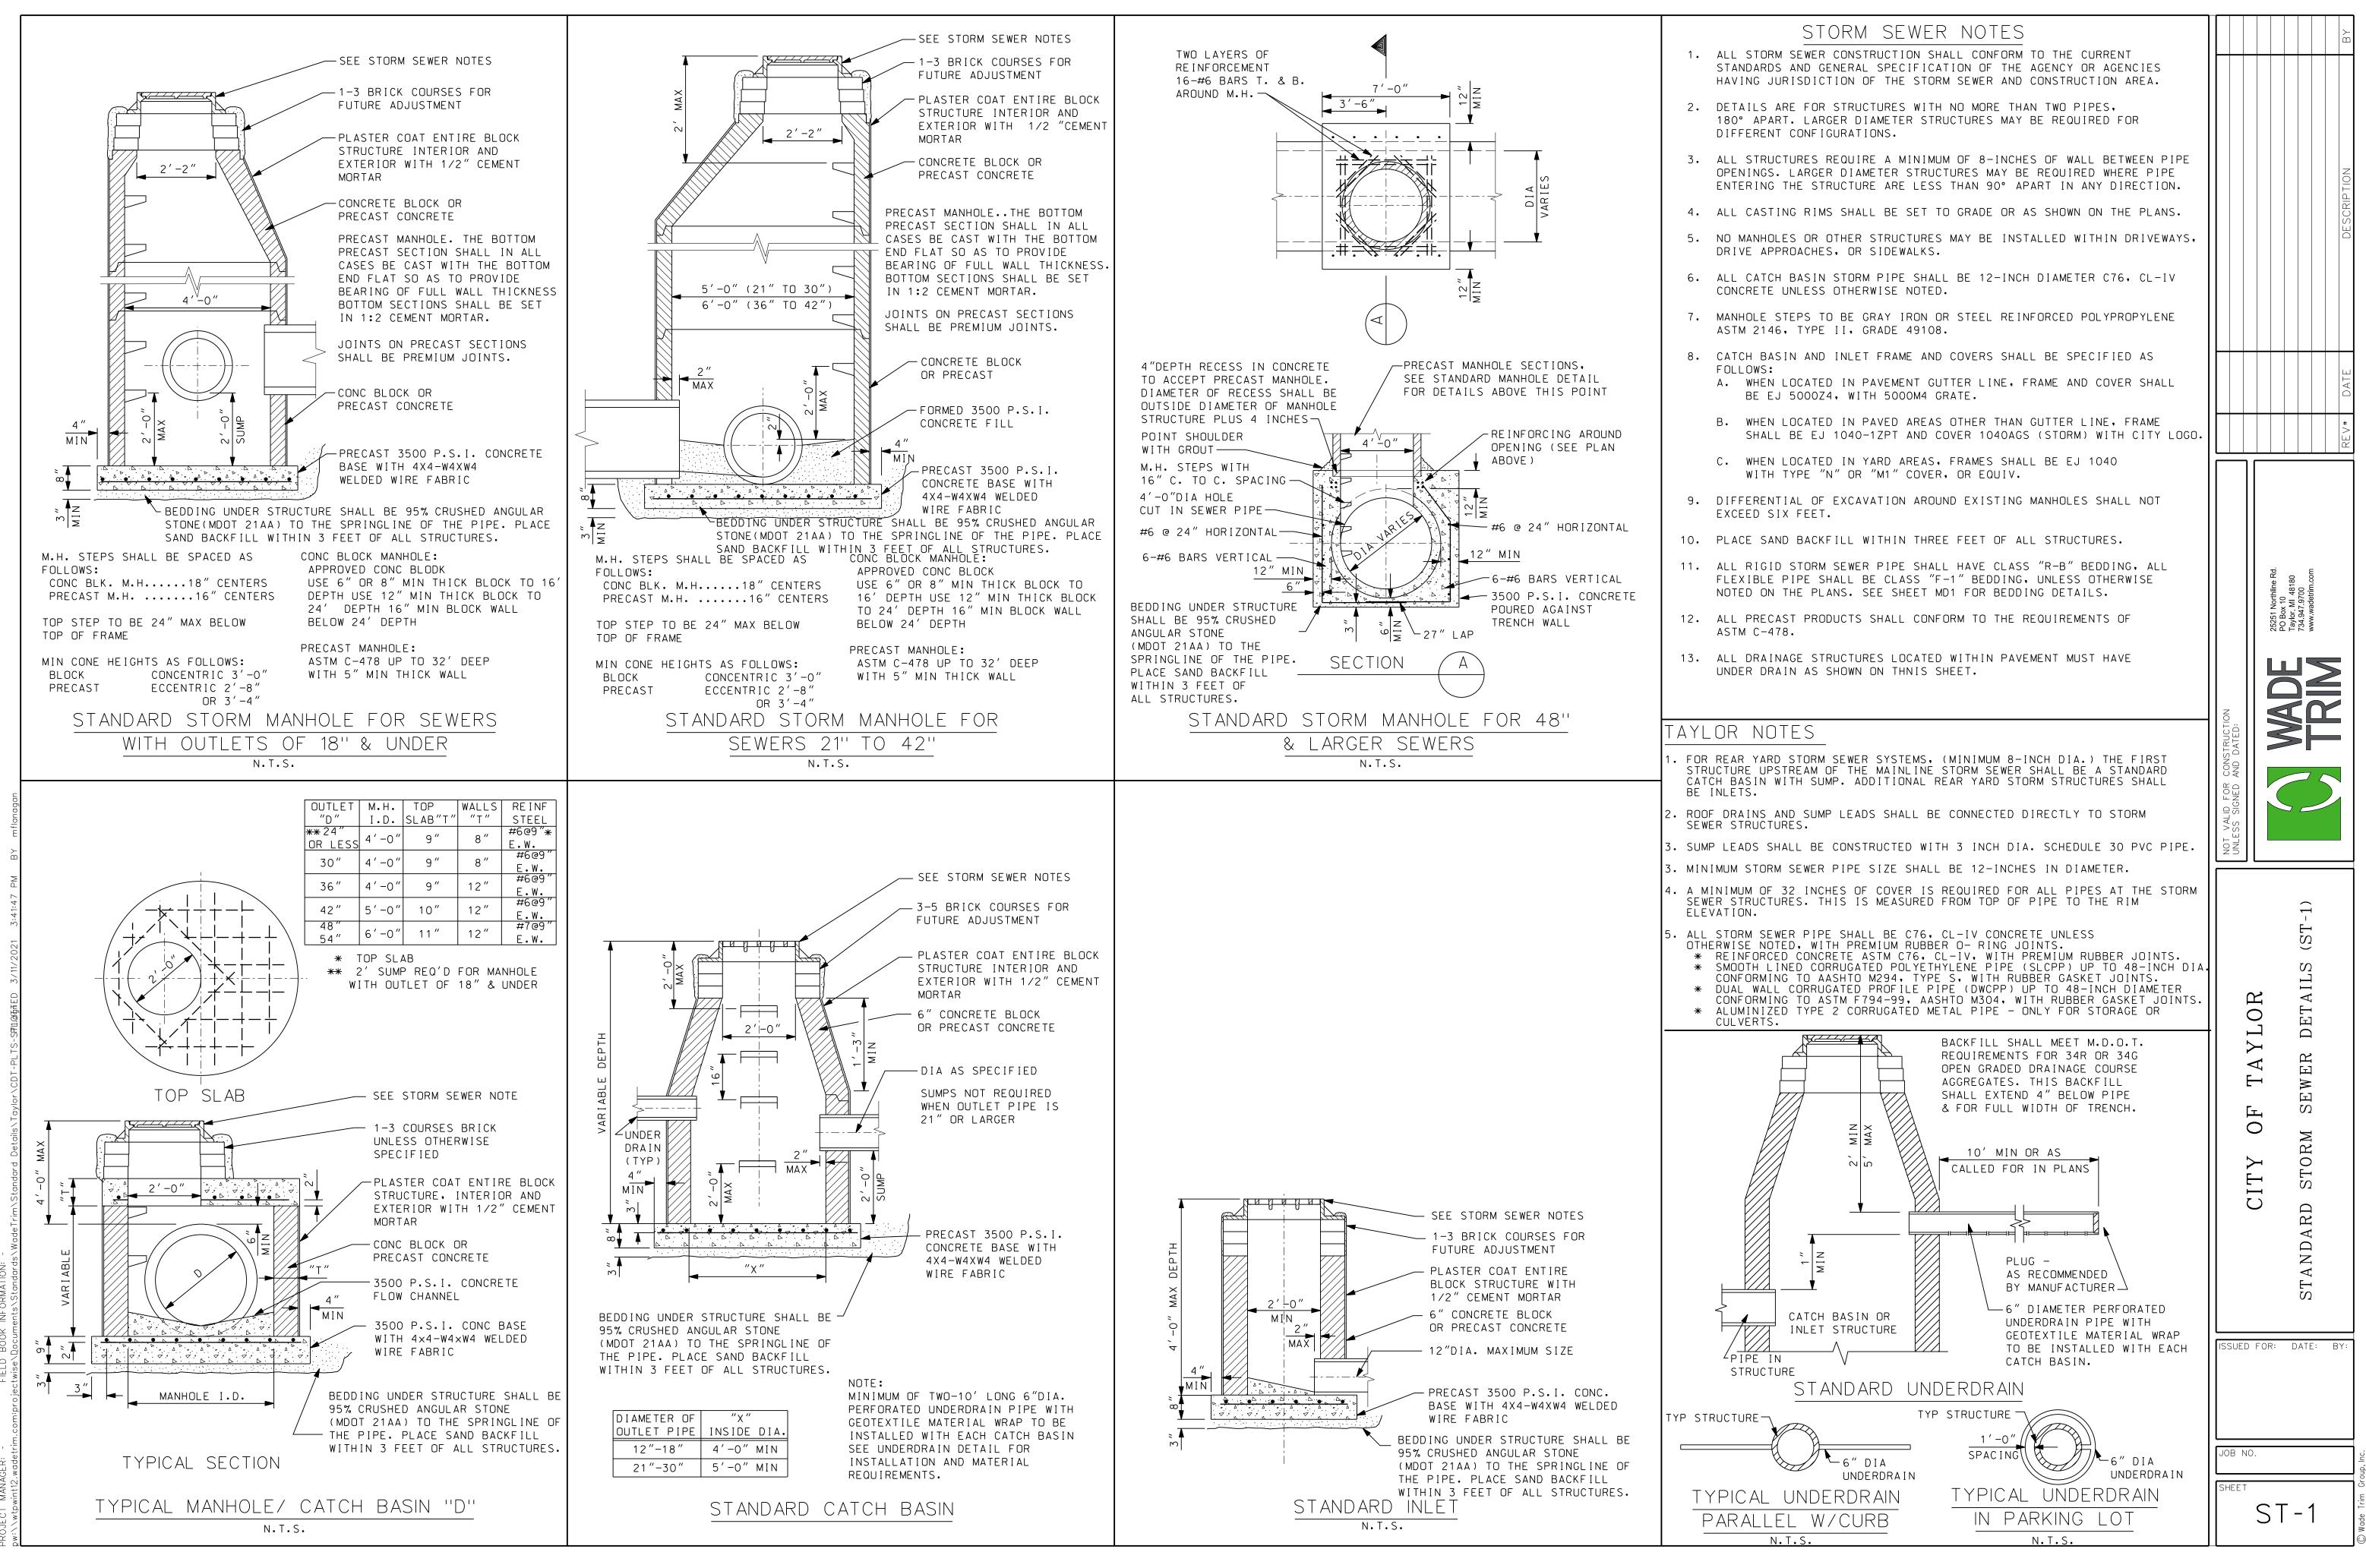

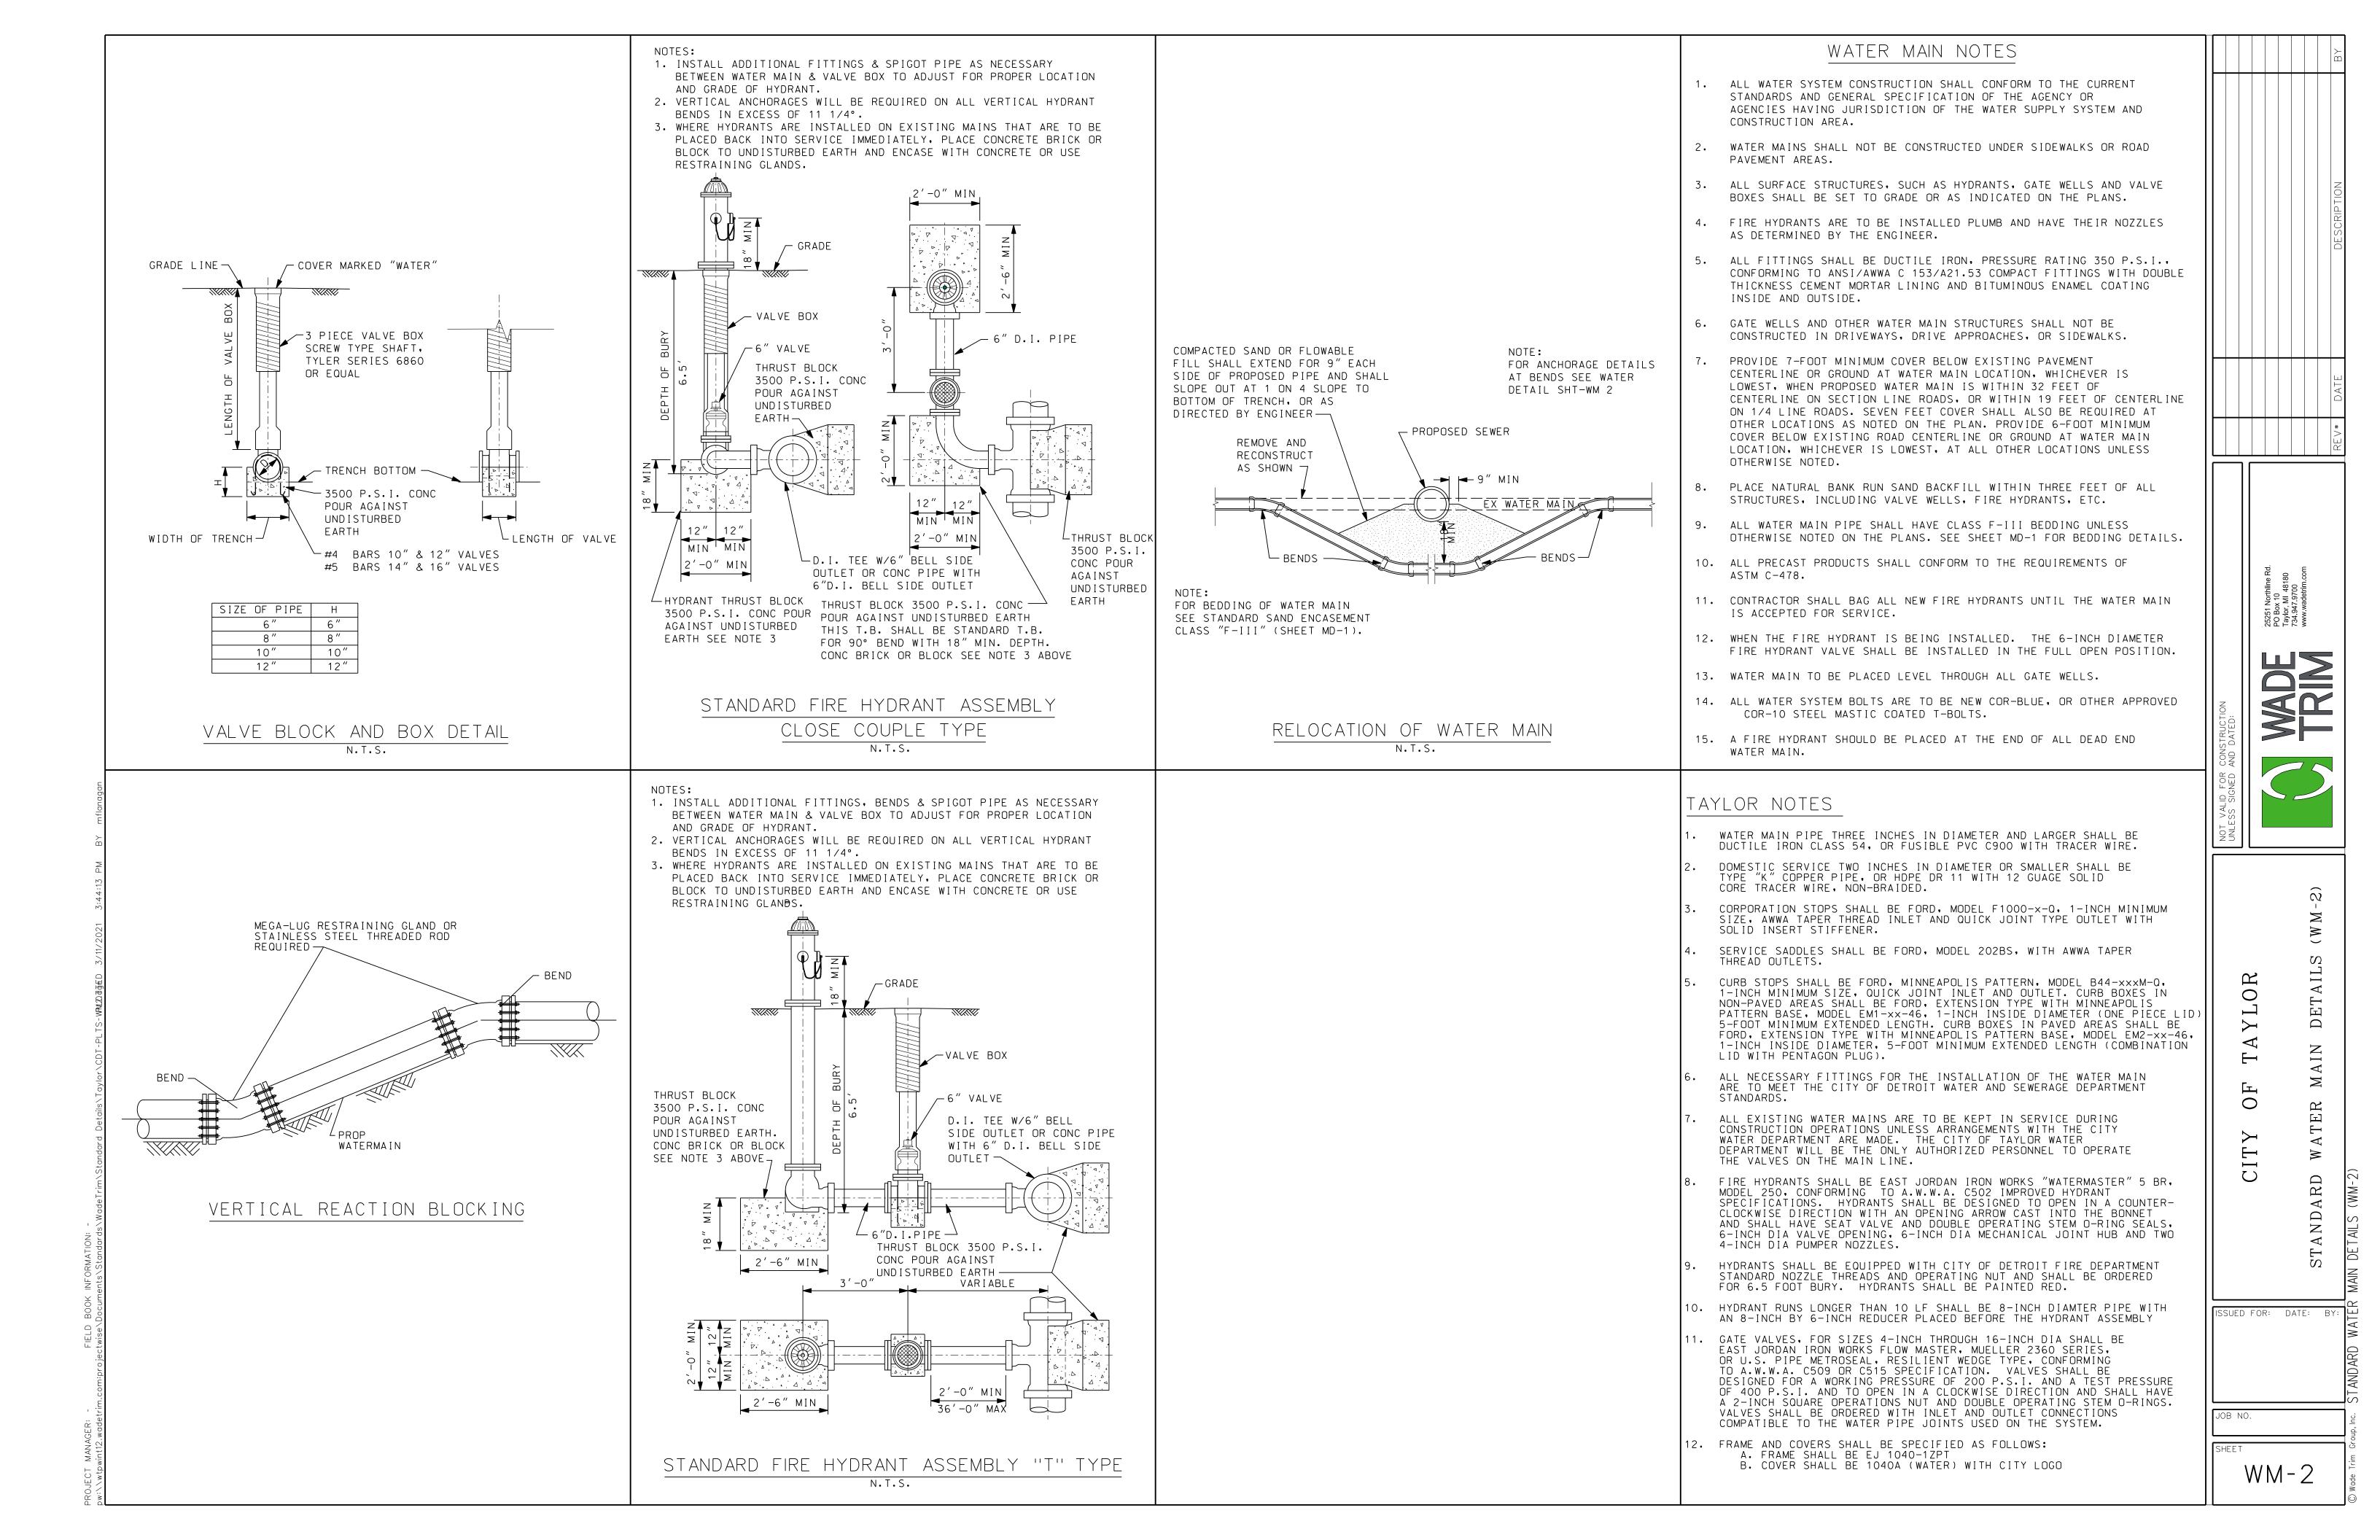



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Client: City of Taylor 23555 Goddard Rd. Taylor, MI 48180

Project:

25555 Northline Rd. Taylor, MI 48180

Seal:

City of Taylor Animal Shelter Remodel & Expansion

REMOVE ALL EXISTING SUPPLY, RETURN AND EXHAUST DUCTWORK, REHEAT COIL, CONTROLS AND POWER. EXISTING FLOOR OPENINGS TO REMAIN FOR RE-USE. COORDINATE PATCHING OF WALL OPENINGS AS REQUIRED WITH ARCHITECTURAL TRADES.

> REMOVE EXISTING GAS FIRED UNIT HEATER AND ALL ASSOCIATED FLUE PIPING, GAS PIPING, CONTROLS AND POWER. PATCH EXISTING ROOF OPENING AND ROOF TO MATCH EXISTING. COORDINATE WITH ARCHITECTURAL TRADES.

Date 12/21/2023 01/17/2024


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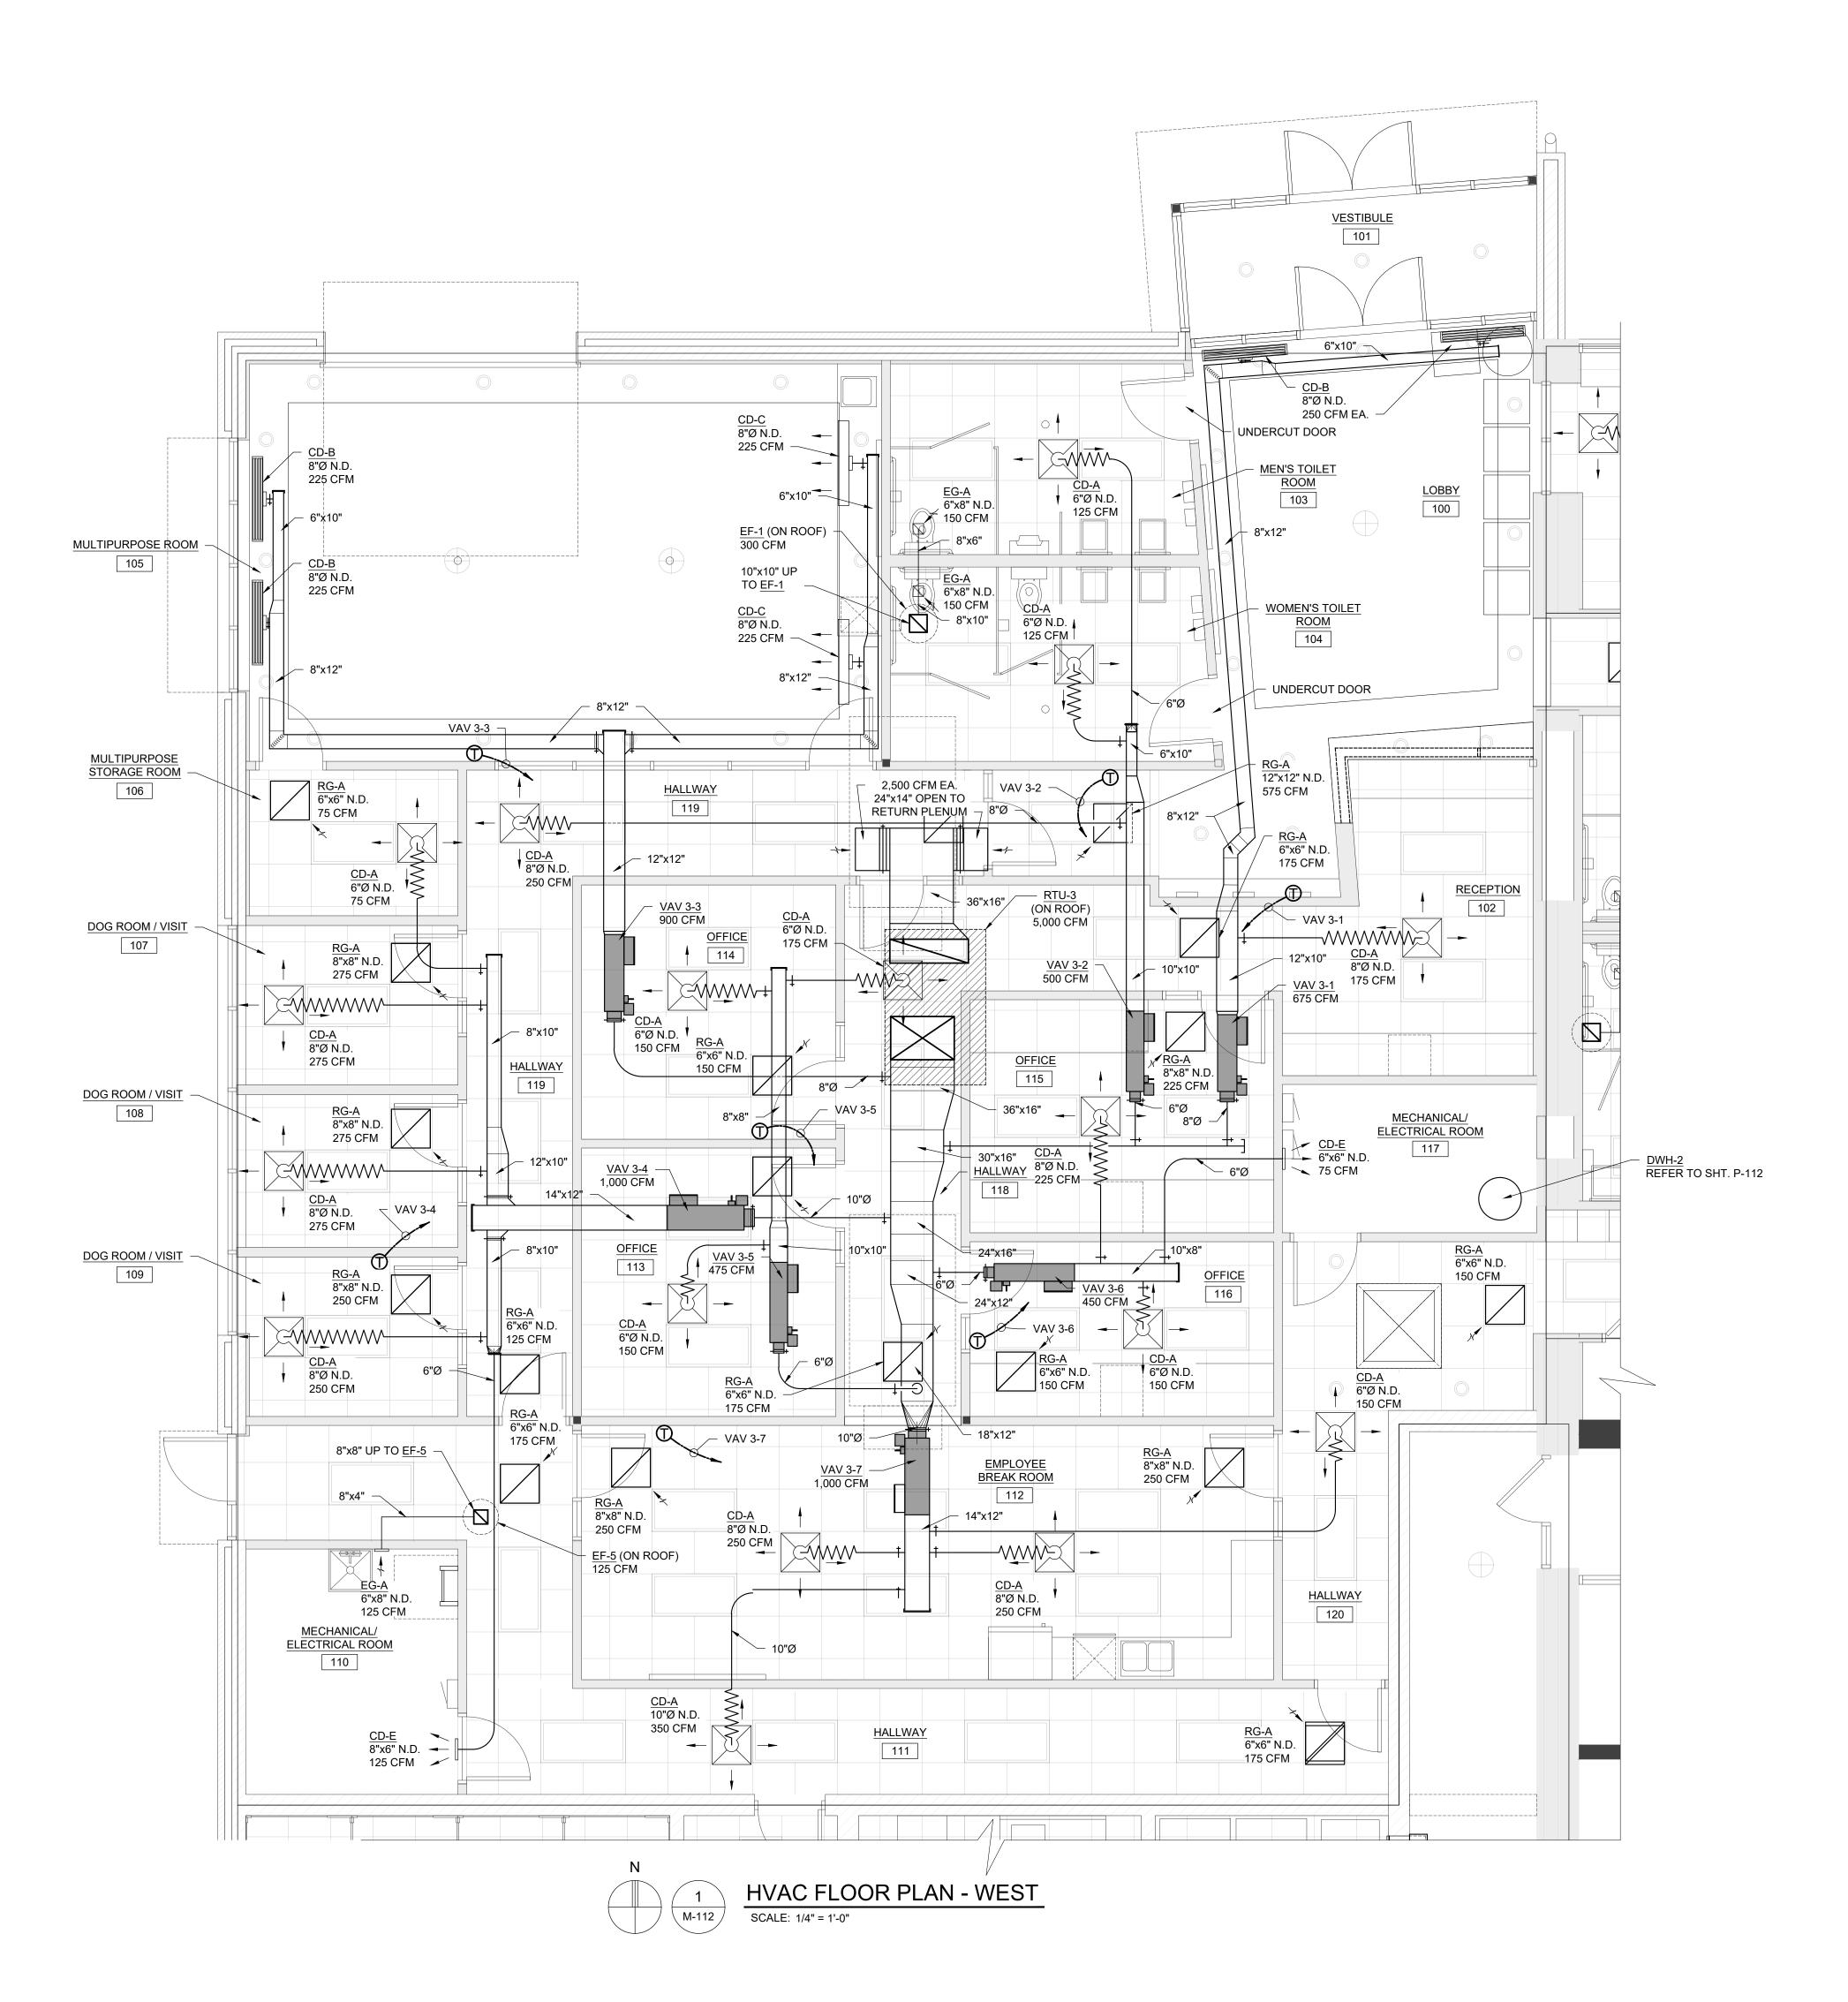
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Sheet Title: MECHANICAL DEMOLITION FLOOR PLANS

Project Number: 22712.A

Sheet Number: MD-110 THIS MATERIAL IS THE EXCLUSIVE PROPERTY OF SIDOCK GROUP, INC. AND CANNOT BE REPRODUCED, COPIED, OR USED IN ANY MANNER WITHOUT THE PRIOR WRITTEN CONSENT OF SIDOCK GROUP, INC. \bigcirc 2023





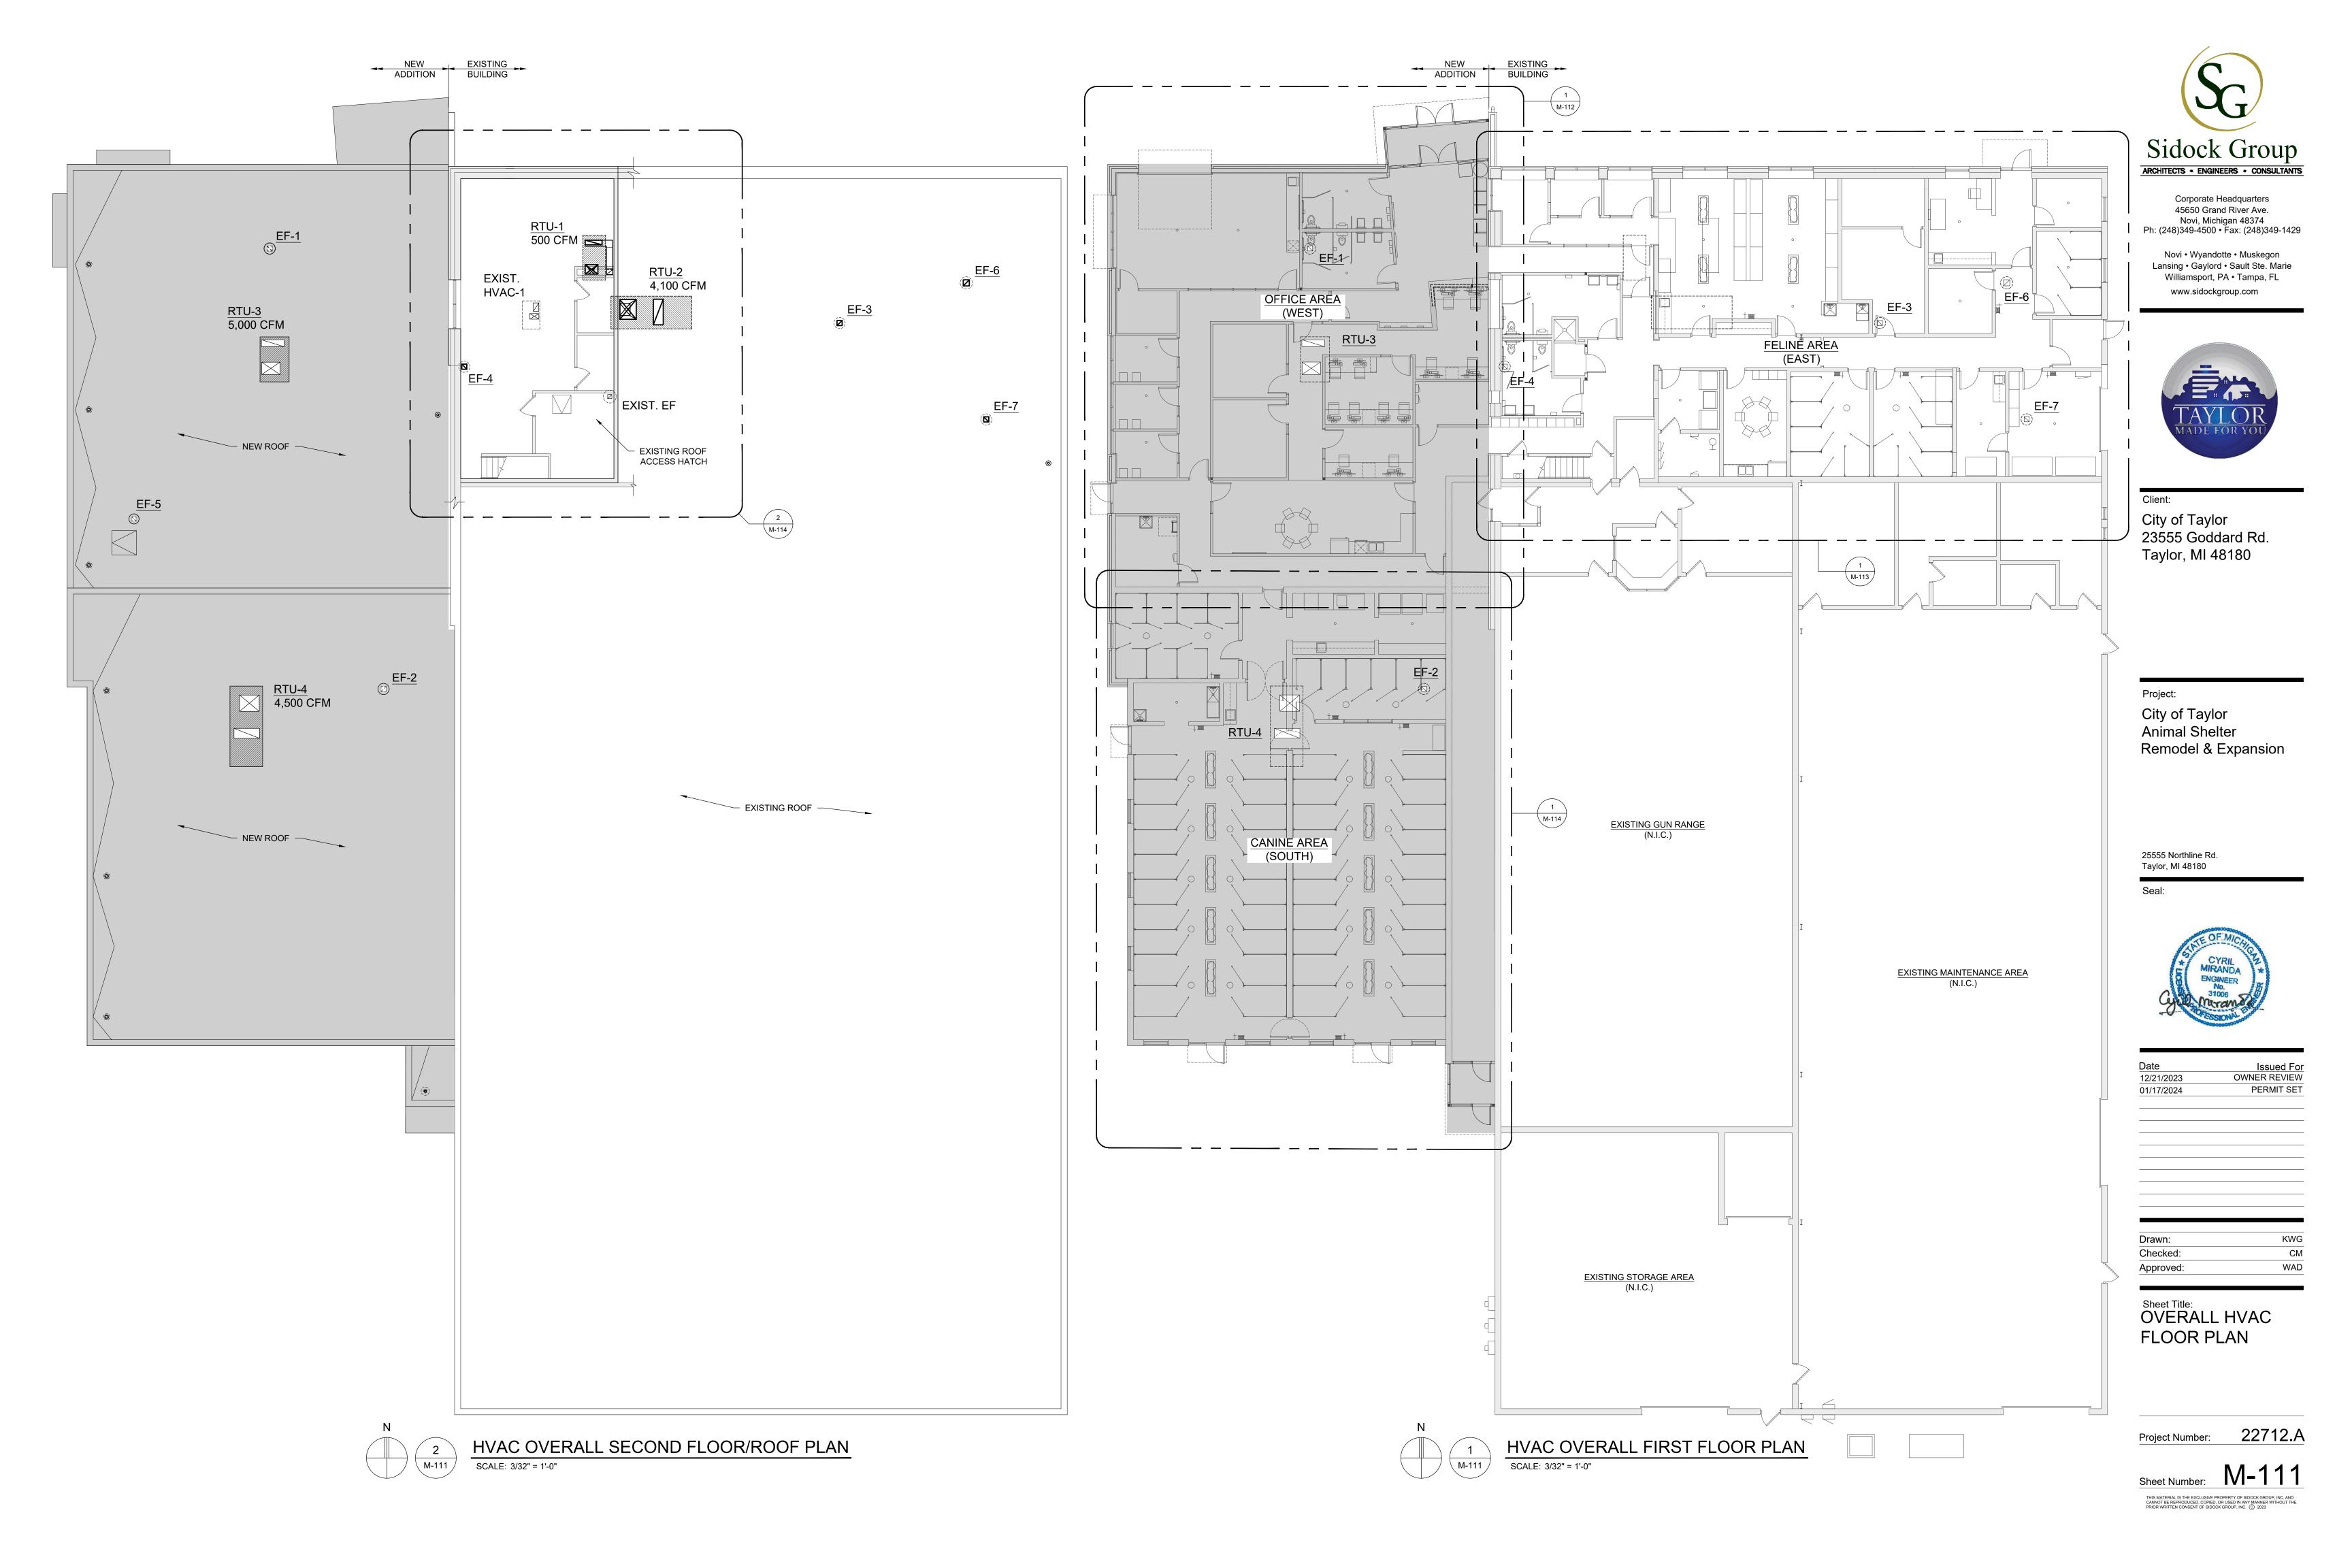

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^{Client:} City of Taylor 23555 Goddard Rd. Taylor, MI 48180

Project:

City of Taylor Animal Shelter Remodel & Expansion

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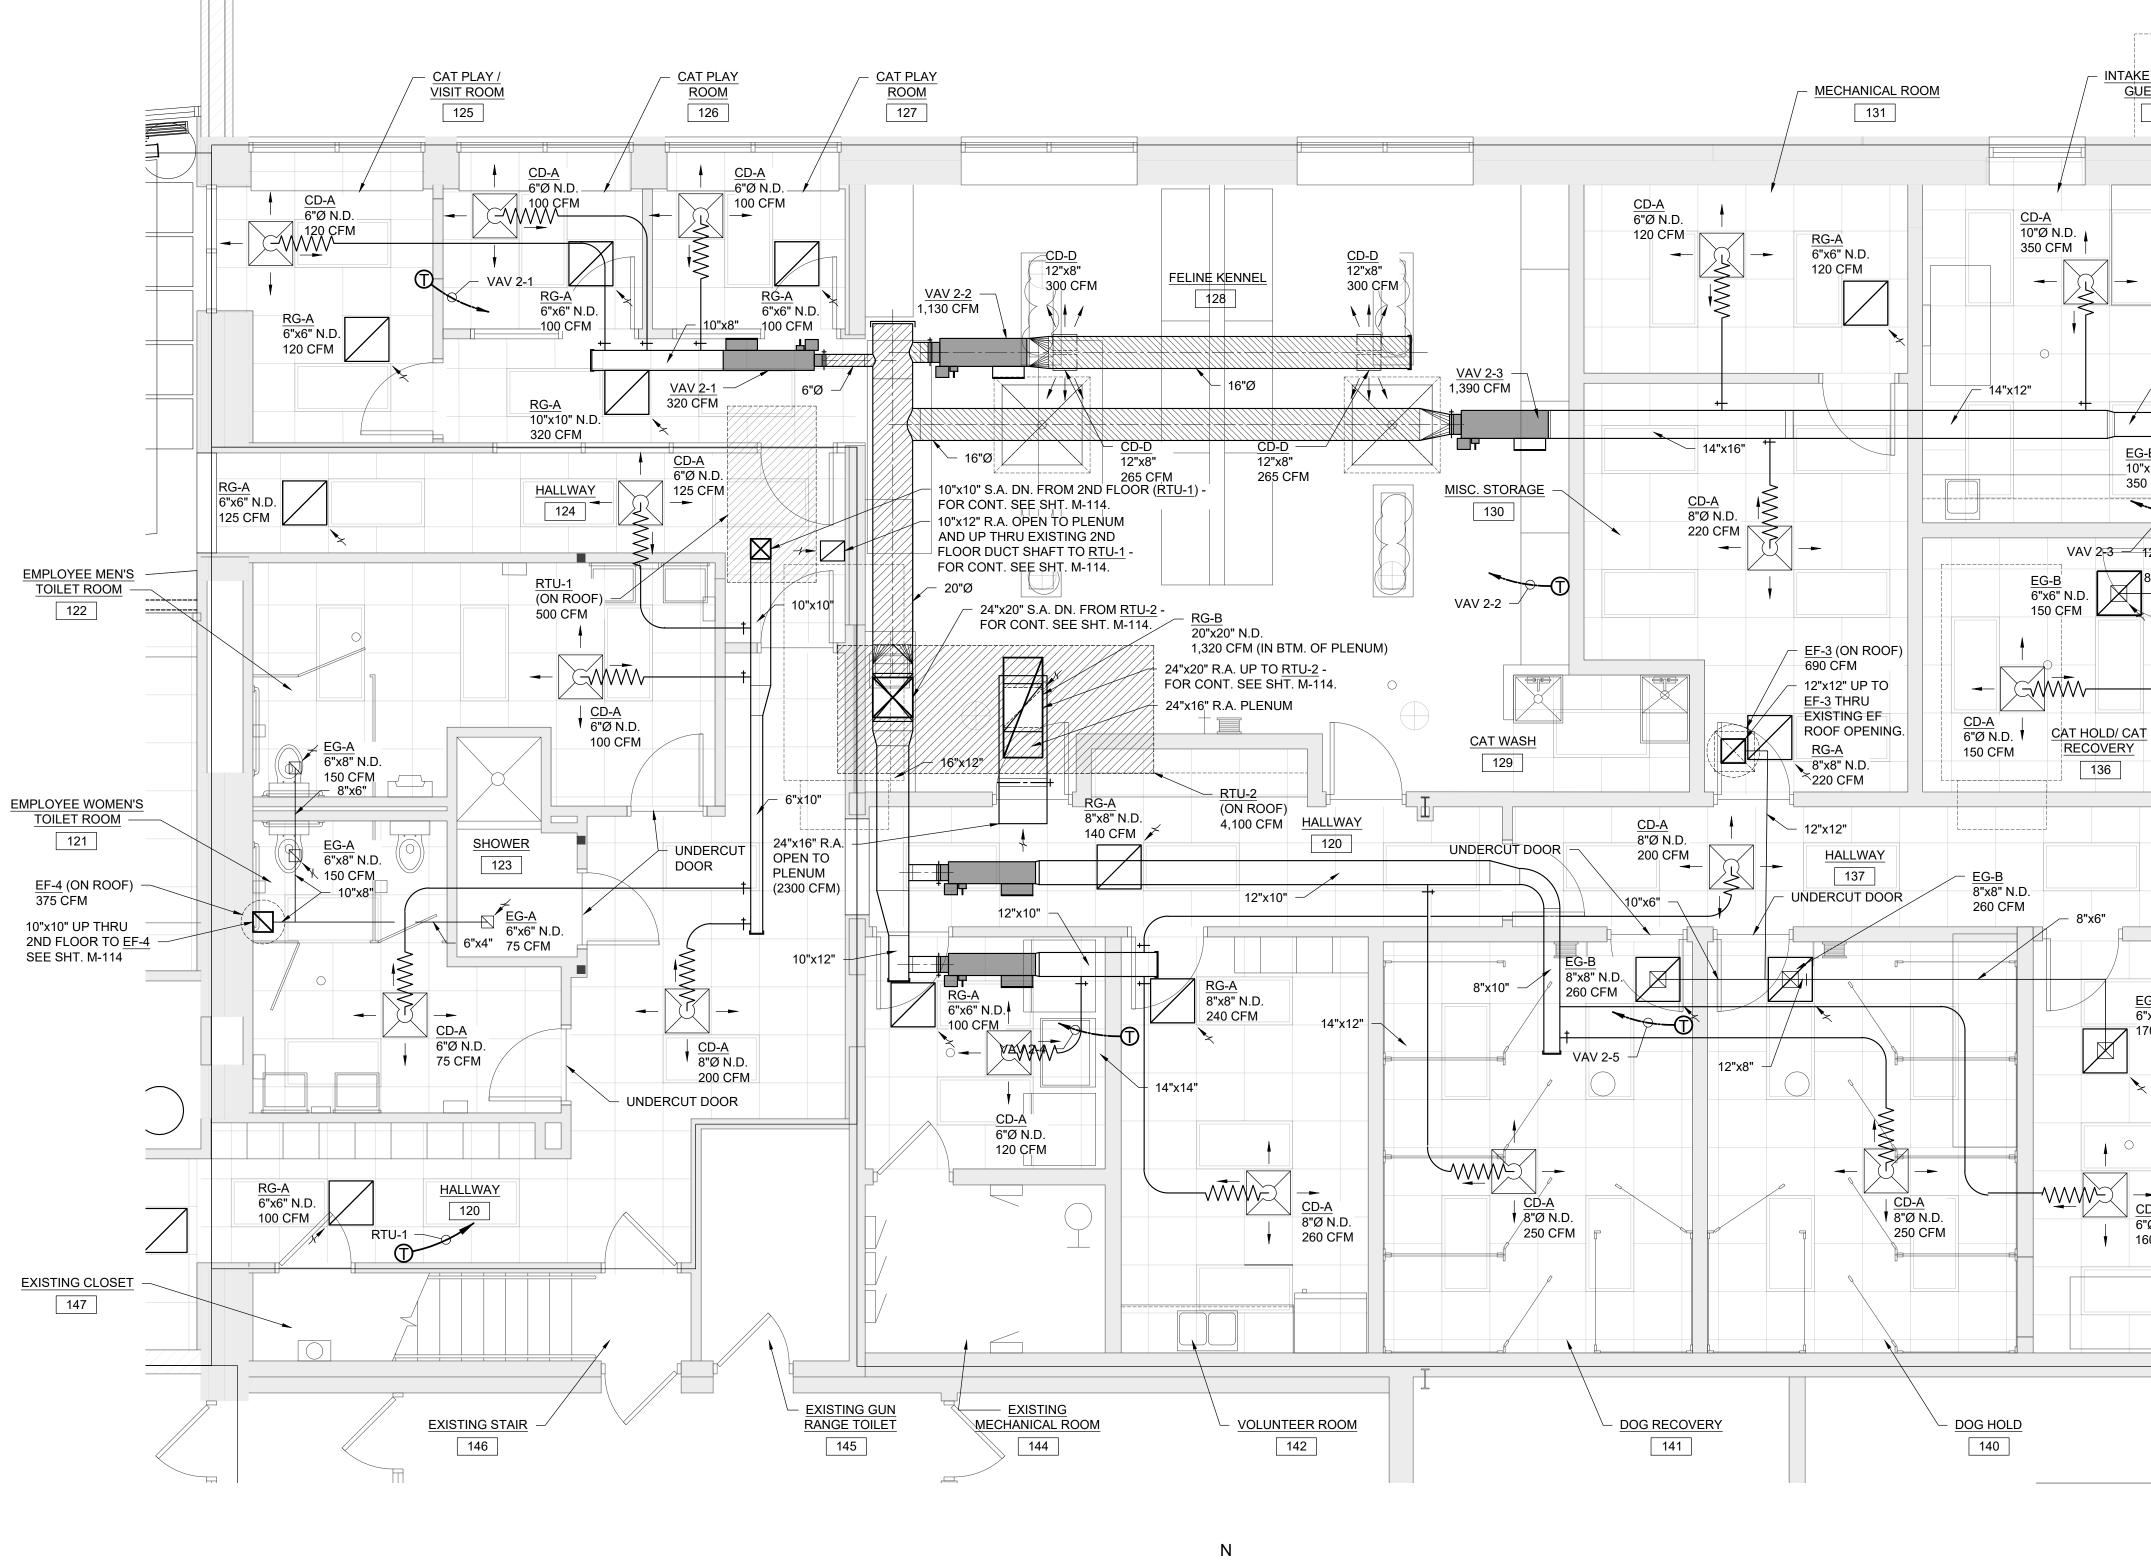
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Checked:	СМ
Approved:	WAD

^{Sheet Title:} HVAC FLOOR PLAN -WEST

Project Number: 22712.A

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HVAC FLOOR PLAN - EAST M-113 SCALE: 1/4" = 1'-0"

1



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Client:

City of Taylor 23555 Goddard Rd. Taylor, MI 48180



City of Taylor Animal Shelter **Remodel & Expansion**


25555 Northline Rd. Taylor, MI 48180

Seal:



Date	Issued For
12/21/2023	OWNER REVIEW
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Sheet Title: HVAC FLOOR PLAN -EAST

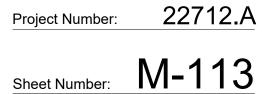



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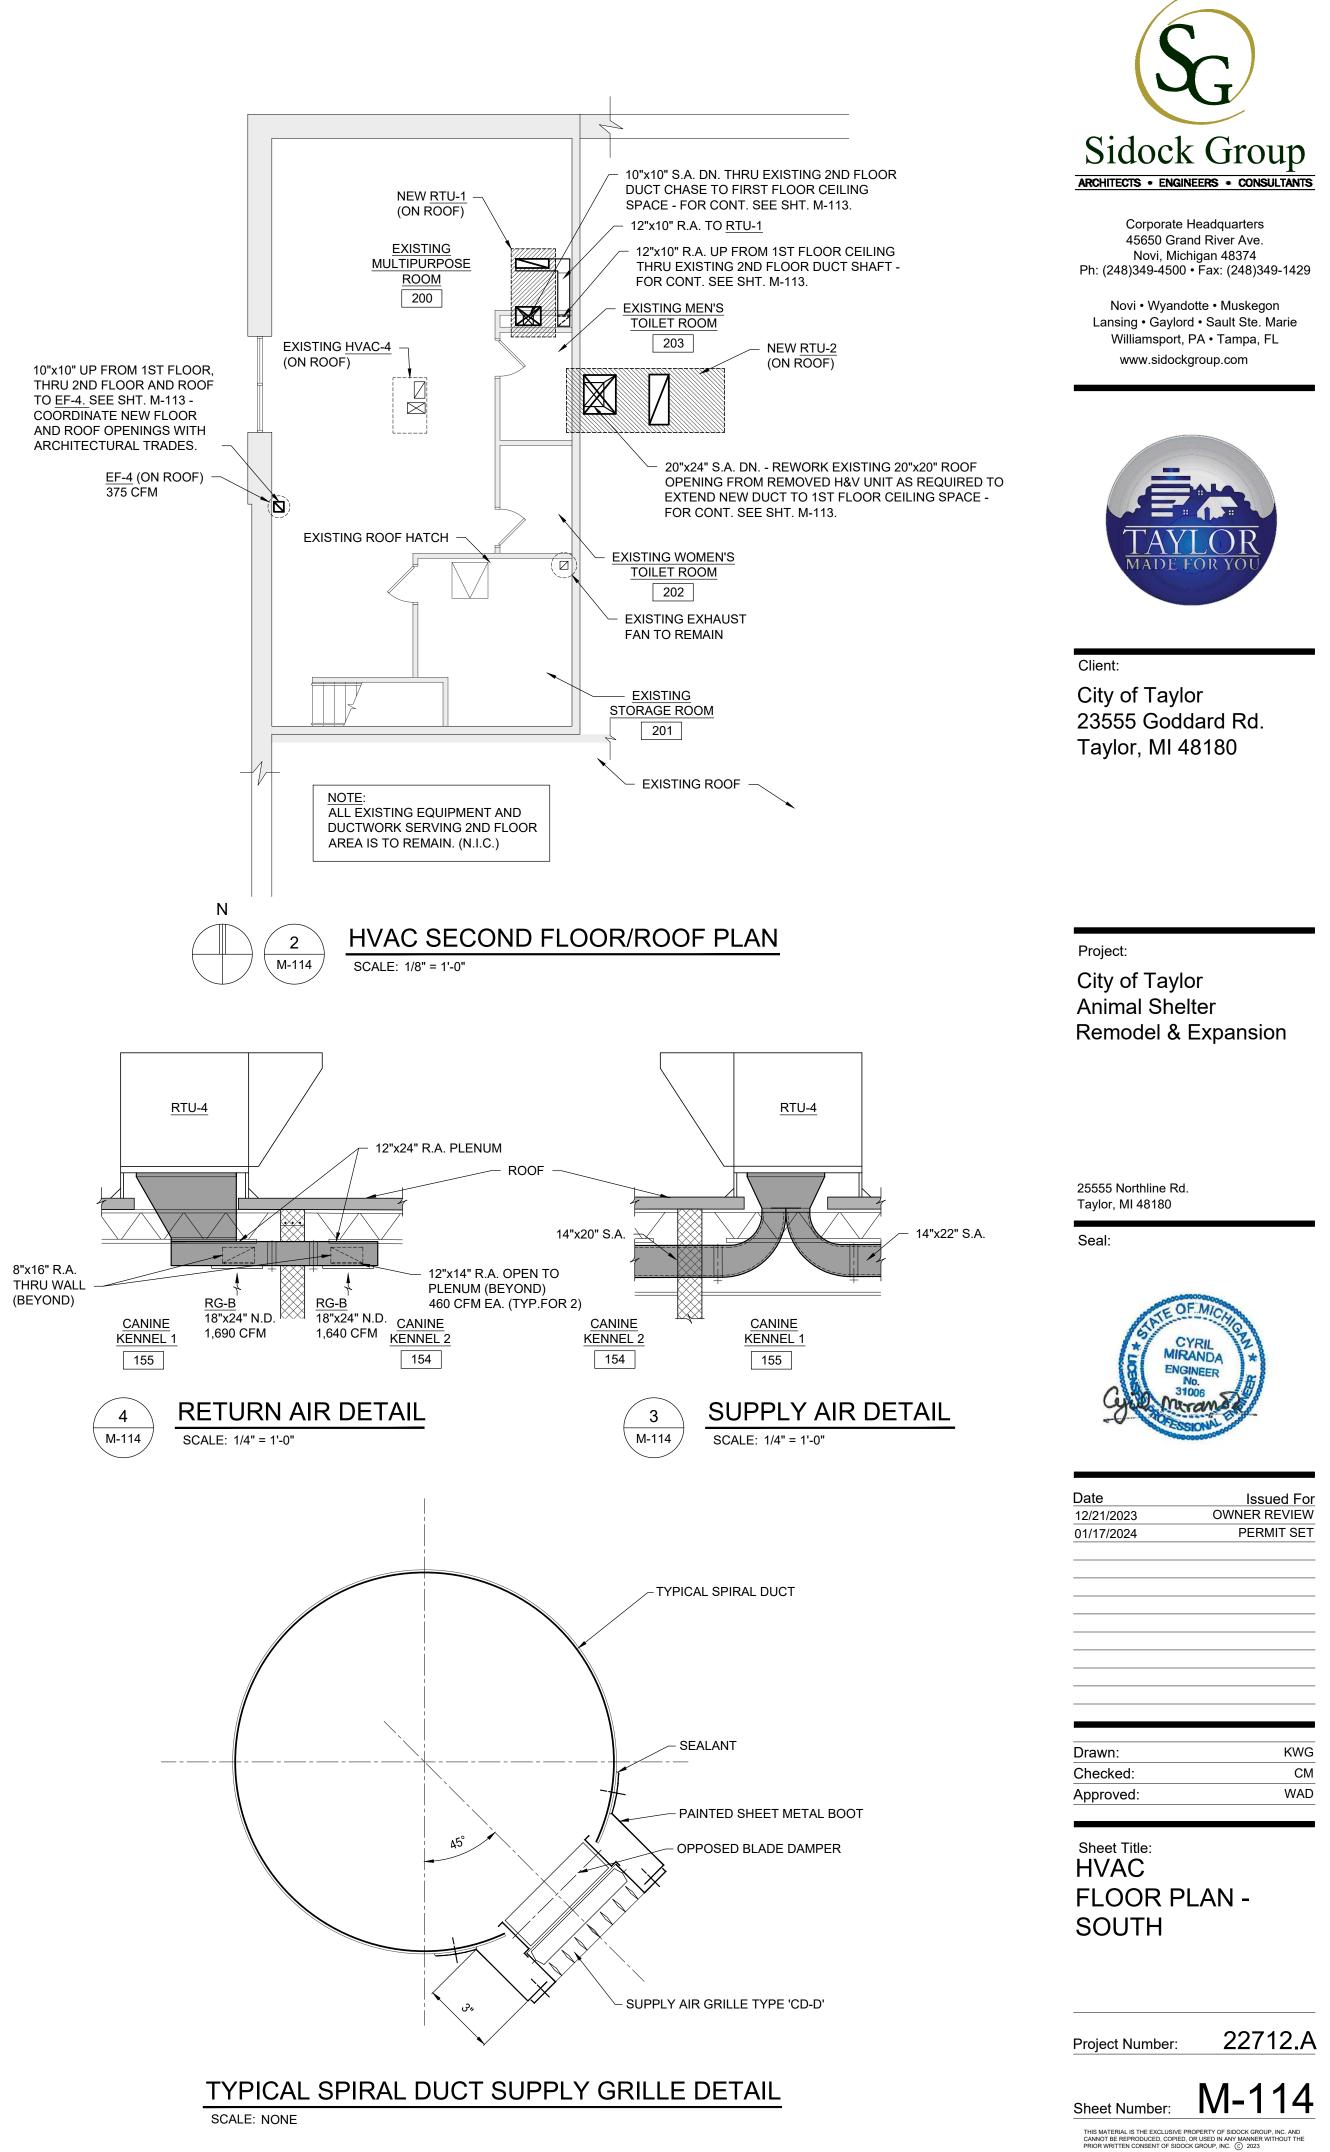
- <u>CAT ISO.</u> 133 <u>CD-A</u> 6"Ø N.D. 170 CFM EG-B 8"x8" N.D. 170 CFM 8"x6" ─ 12"x10" 10"x10" <u>EG-B</u> __10"x10" N.D. 350 CFM \mathbf{I} <u>CD-A</u> 8"Ø N.D. <u>EF-6</u> (ON ROOF) 930 CFM 8"Ø N.D. 260 CFM - <u>DOG ISO.</u> 12"x12" UP TQ 🗕 🔾 134 EF-6 ON ROOF VAV 2-3 - 12"x10" -- 8"x8" X EG-B 8"x8" N.D. 260 CFM 8"x8" -CD-A 6"Ø N.D. 120 CFM \leq <u>RG-A</u> 6"x6" N.D. - ENTRY FOYER 135 150 CFM \bigcirc <u>EG-B</u> 6"x6" N.D. GUH-1 170 CFM Ø EF-7 (ON ROOF) 300 CFM 10"x10" UP TO <u>EF-7</u> - <u>DELIVERY/ PICK-UP/</u> <u>STORAGE</u> 138 <u>CD-A</u> 6"Ø N.D. 160 CFM GUH-1 3"Ø 'B'-VENT THRU ROOF w/ BREIDERT CAP – <u>EUTH ROOM</u> 139

- INTAKE CHECK-IN/ GUEST VET.

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SUPPLY	MIN.		SUPPLY F	FAN DATA					DX C		OIL DATA				HEATING SE	ECTION (IND	IRECT GAS-	FIRED)	F	LTER DATA	\			AI	IR-COOLED (ONDENSIN	G SECTION						DESIG	N BASIS			EL	ECTRICAL	
TAG LOCATION SERVING AIR (CFM)	OUTDOOR AIR (CFM) WHEEL TYPE	(QTY) E FAN DIA x WIDTH	ESP TSP	MOTOR HP	MOTOR RPM	DRIVE TYPE FA SPE (RP	AN EAT EED DB PM) (°F)	EAT WB (°F)	LAT DB (°F)	NET TOTAL (MBH)	NET SENS (MBH)	FACE FA VEL AR (FPM) (SQ	CE EA .FT) / FPI	S EAT (°F)	LAT OUTF (°F) (MB	PUT INPUT 3H) (MBH)	GAS CONS. F (CFH)	GAS GA PRESS. COM (PSIG) ("D	AS PRE-FIL [®] NN. TYPE IA.) EFFICIEI		FILTER PE & NO CIENCY	D. OF RE DMPR. T	efrig. A Type ti	MBIENT EMP (°F)	NO. OF COND. FANS	N DIA. F CHES) T	AN AIR QT YPE (CFM		DRIVE TYPE	RPM	MAKE & MODEL	EER @AHRI COND.	TYPE	SIZE (L''xW''xH'')) INCHES	WEIGHT (LBS)	VOLT PHA	ASE UNIT MCA	UNIT MOP
RTU-1 NOMINAL 3 TON UNITROOF MOUNTEDEXISTING OFFICE AREA500125	375 BC - PLENUN	л (1) 19"ø	0.75" 1.41"	" 1	1,760	DIRECT 1,2	269 89	72	50 48.8	35.5	21.9	102 5.	.3 3/14	20.9	104.8 48.	8.6 60	60	0.5 (2) 1	1/2" 2" PLEA ⁻ (MERV		LEATED RV 13)	1 R-	R-410A	95	1	Pf	ROP	1/3	DIRECT	^{1,100} R	AAON RQ-003-8-V-EA09-31B	11.2	DOWN DISCHARGE	82 1/2 x 44 1/4 x ADD 17 1/2 (L) FOR OUT		875	208 3	3 22	30 NOTE
RTU-3 NOMINAL 15 TON UNITROOF MOUNTEDNEW OFFICE AREA5,0004,250	750 BC - PLENUM	л (1) 22"ø	1.0" 2.81"	" 7.5	1,760	DIRECT 1,7	760 80	67	55.6 53.6	170	128	343 14	l.6 4/14	53.9	97 234	34 293	293	0.5 (2) 3	3/4" 2" PLEA ⁻ (MERV	ED 4" PLE 3) (MEF	EATED RV 13)	2 R-	R-410A	95	2	26 PF	ROP. 6,700	1.0	DIRECT	^{1,100} R	AAON RN-015-8-0-GA05-2G4	11.4	DOWN DISCHARGE	88 1/4 x 58 1/4 x ADD 22 3/8 (L) FOR OUT ADD 37 1/2 (L) FOR CON	ISIDE AIR HOOD	D 2,050	208 3	3 100	125 NOTE

NOTE 1: INCLUDES THROUGH THE BASE ELECTRICAL WITH NON-FUSED DISCONNECT SWITCH; GFCI, 120V/15A, 2 PLUG FACTORY WIRED CONVENIENCE OUTLET

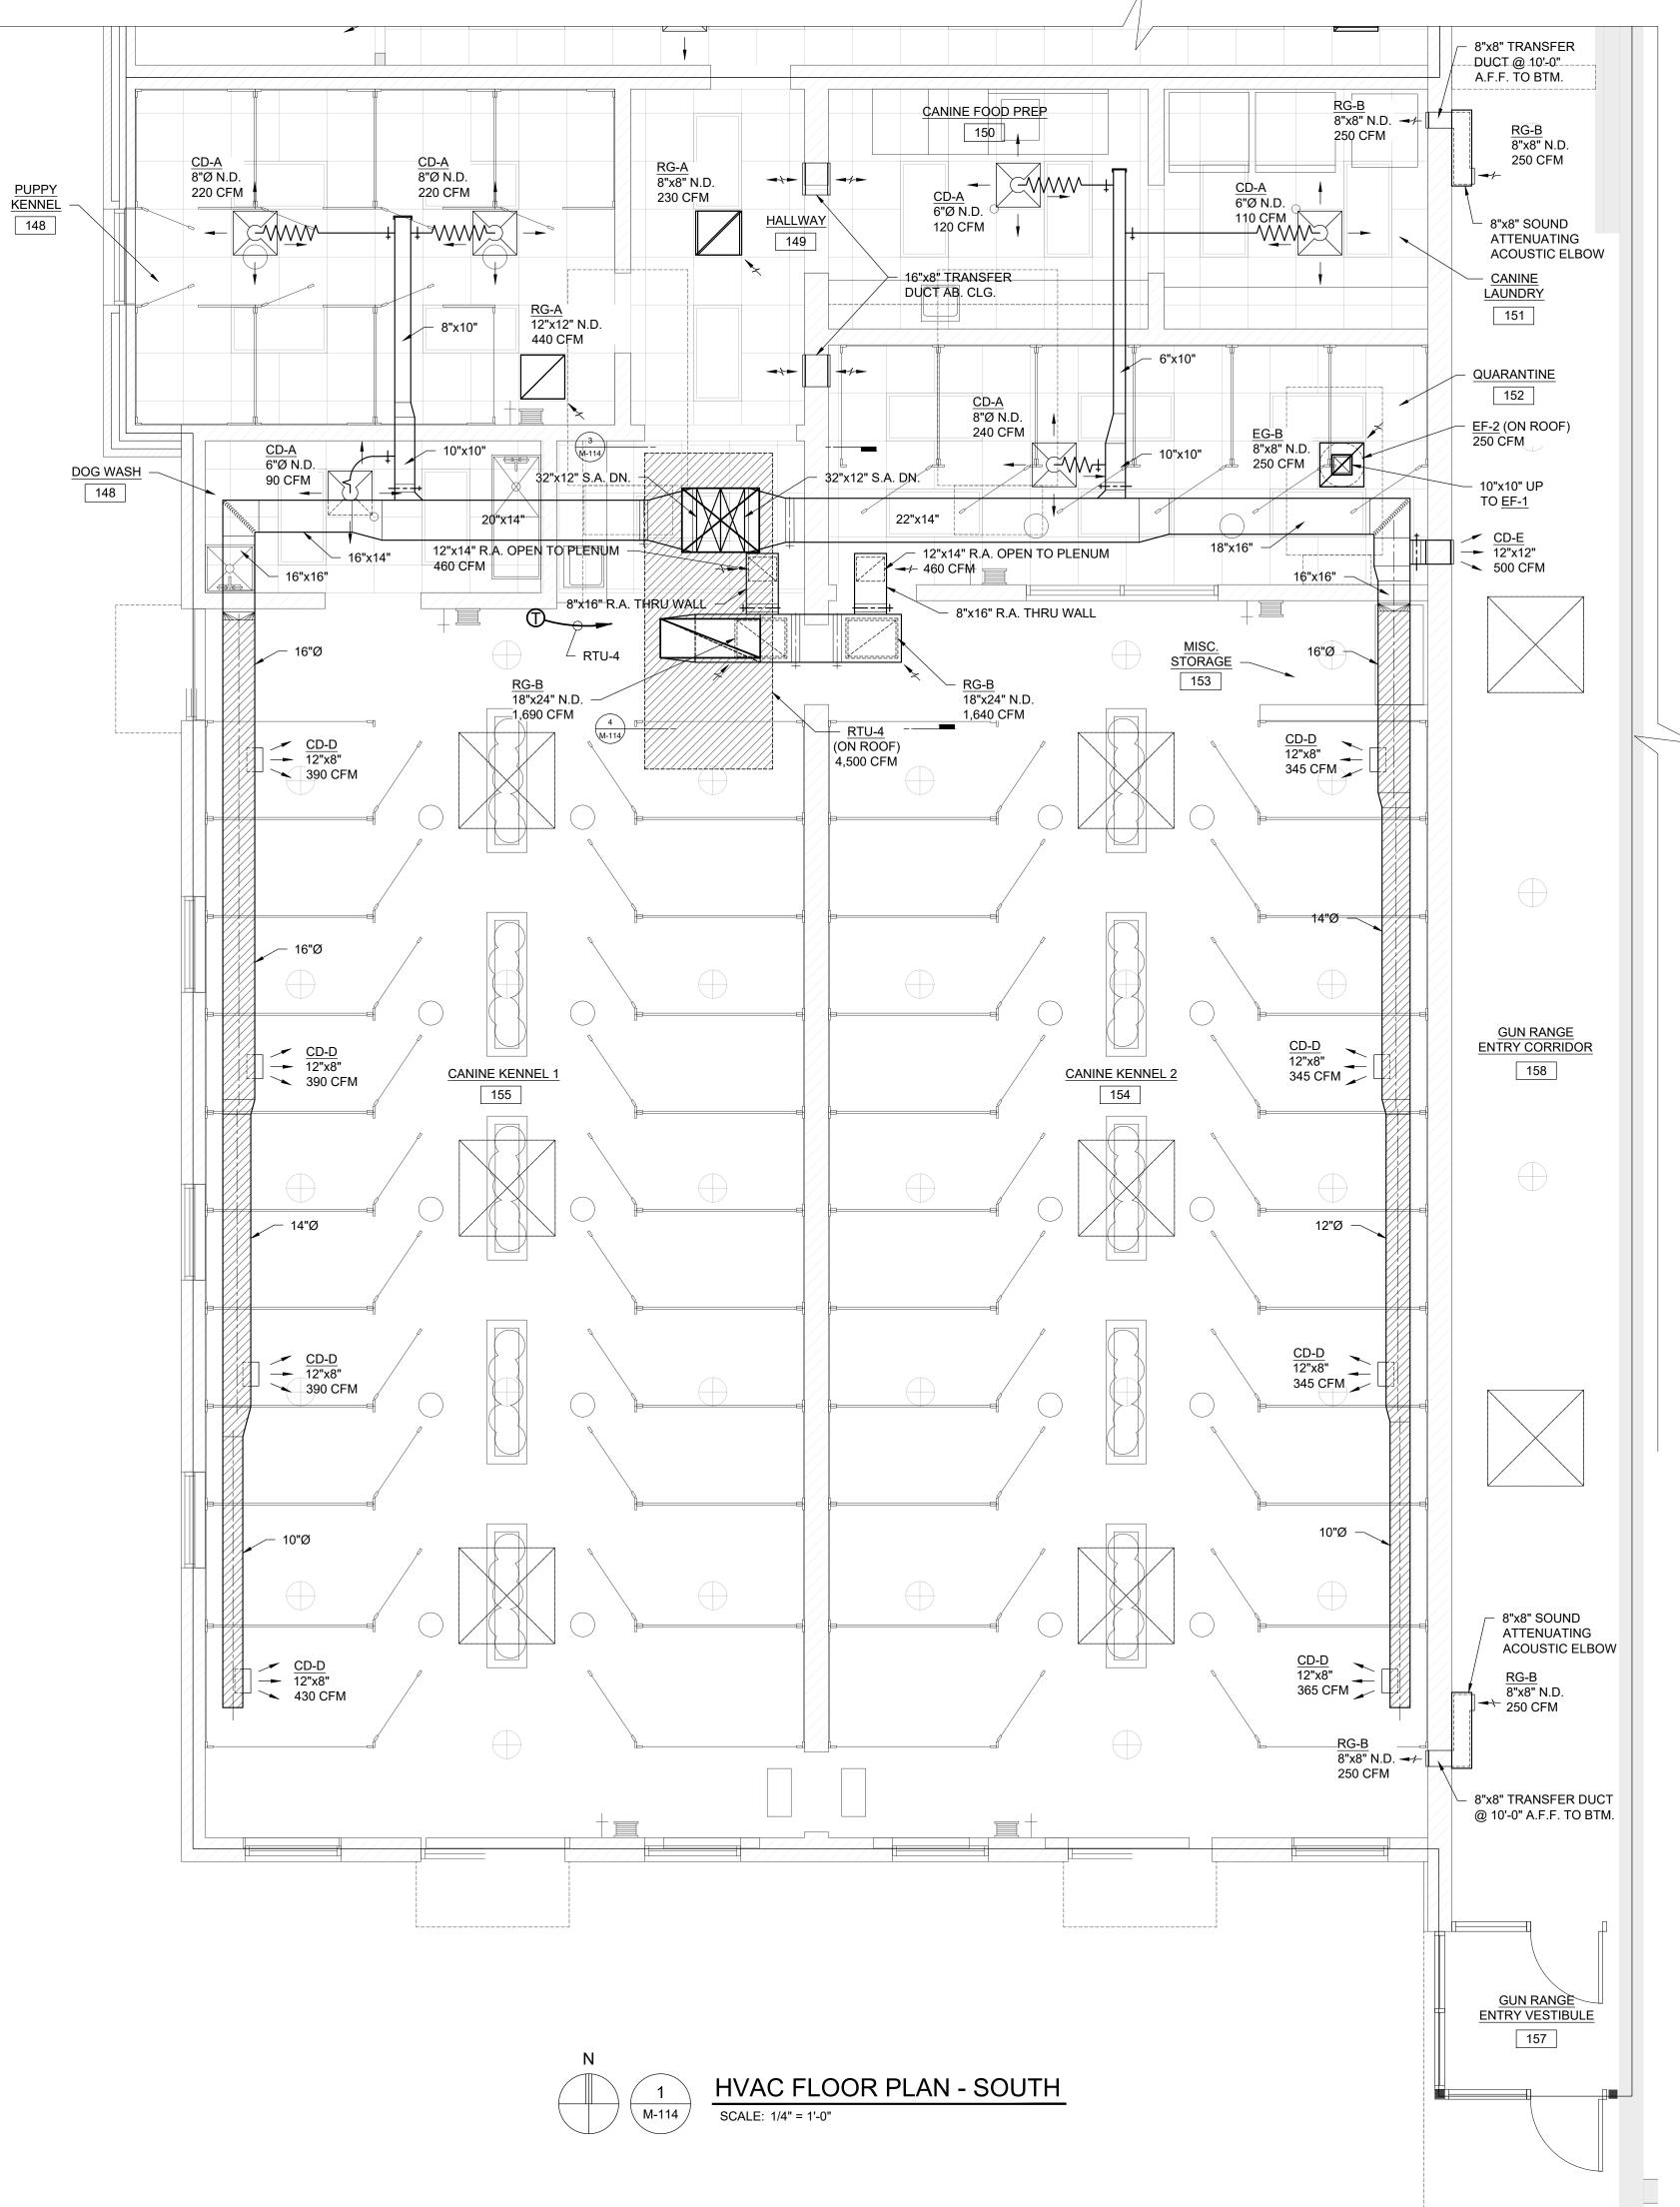										ROOI	FTOP A	AIR HA		IG UNI	т ѕсн	EDUL	E (WIT	H ENER	GY RECOV	ERY WH	EEL)P	PART 1												
											ENERGY R	RECOVERY	(ENTHALP	/) WHEEL SI	ECTION										SUPPLY	FAN					EXHAUST F	ΔN		
MARK	LOCATION	SYSTEM AND/OR SERVICE	ENERGY RECOVERY MAKE &	ENERGY RECOVERY WHEEL	MODE		IDE AIR ENT FHALPY WH			AIR LEAVINO) ENTHALPY	•		IST AIR ENT THALPY WH		(EXHA	JST AIR LE NUST FROM HALPY WH	/I RTU)	ENERGY RECOVERED	REQUIRED ADDITIONAL	TOTAL COOLING	REQUIRED ADDITIONAL MECH. (GAS)	TOTAL HEATING	AIR				τοτοι		AIR					
			MODEL	MOTOR HP		CFM	DB (DEGF)	WB (DEGF)	CFM	DB (DEGF)	WB (DEGF)	CFM	DB (DEGF)	WB (DEGF)	CFM	DB (DEGF)	WB (DEGF)		MECH. COOLING	COOLING	HEATING	HEATING	QTY (CFM)	BLOWER TYPE	FAN SIZE	EXT SP	TOTAL SP	3HP HP	QTY (CFM)	TYPE	FAN SIZE	EXT TOTA SP SP	BHP	HP
RTU-2	ROOF	EXIST (RENOVATED)	AIR EXCHANGE	0.67	SUMMER (COOLING)	4,100	95.0	75.0	4,100	80.3	66.5	4,100	75.0	62.0	4,100	89.5	71.1	125.1 MBH / 10.42 TONS	185.5 MBH / 15.46 TONS	310.6 MBH / 25.88 TONS			- 4.100	DIRECT DRIVE BACKWARD	24" DIA	1.5"	2 24"	3 00 7 5	5 4,100	DIRECT DRIVE BACKWARD	22" DIA.	1.0" 1.78	." 1.8	2
		ANIMAL SHELTER AREA	ERC-5255C-4M	0.07	WINTER (HEATING)	4,100	0.0	0.0	4,100	50.1	39.0	4,100	70.0	51.0	4,100	18.3	17.8	220.4 MBH			328.1 MBH	548.5 MBH	4,100	CURVED PLENUN WITH VFD		1.5	3.24	5.09 7.0	4,100	CURVED PLENUM WITH VFD		1.0 1.70	1.0	
RTU-4	ROOF	NEW ADDITION -	AIR EXCHANGE	0.74	SUMMER (COOLING)	4,500	95.0	75.0	4,500	80.3	66.7	4,500	75.0	62.0	4,500	89.4	70.9	134.5 MBH / 11.2 TONS	208.8 MBH / 17.4 TONS	343.3 MBH / 28.6 TONS			- 4,500	DIRECT DRIVE BACKWARD	, 27" DIA.	1 5"	2 42"	2.01 7.5	5 4,500	DIRECT DRIVE BACKWARD	22" DIA.	1.0" 1.88		5
RI0-4	RUUF	ANIMAL SHELTER AREA	ERC-5255C-4M	0.74	WINTER (HEATING)	4,500	0.0	0.0	4,500	50.9	39.8	4,500	70.0	51.0	4,500	15.4	15.2	241.8 MBH			328.1 MBH	570 MBH	4,500	CURVED PLENUN WITH VFD		1.5	3.42	5.91 7.5	4,500	CURVED PLENUM WITH VFD	22 DIA.	1.0 1.00	5 3.91	5

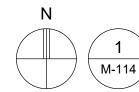								R	OOFT		R HAN	DLING	UNIT	SCH	EDULI	E (WIT	H ENERG	BY REC	OVER	Y WH	EEL)	P/	ART 2					
		SYSTEM AND/OR	FILT	TERS				D	X COOLING		ΓΑ					А	IR COLLED CON	DENSING SI	ECTION DA	ΤΑ			ELECTRIC	AL	DESIGN E	BASIS		
MARK	LOCATION	SERVICE	PRE-FILTER	FINAL FILTER	EAT DB	EAT WB	LAT DB	LAT WB	TOTAL	SENS	FACE	FACE	ROWS	FINS PER	NO. OF	REFRIG.	NO. OF	FAN DIA.	FAN	AIR QTY	HP			MCA MOP	MAKE & MODEL	SIZE		REMARKS
			PRE-FILTER		(DEGF)	(DEGF)	(DEGF)	(DEGF)	(MBH)	(MBH)	VEL (FPM)	AREA (SQ.FT)	RUWS	INCH	COMPR.		CONDENSER FANS	(INCHES)	FAN TYPE	(CFM)	(EACH)	VOLT	PHASE UNIT FLA			L"xW"xH"	wт	
RTU-2	ROOF	EXIST (RENOVATED) ANIMAL SHELTER AREA		4" PLEATED / MERV 13	80.3	66.5	50.1	49.8	185.5	123.7	206	19.9	4	14	2	R-410A	2	30	PROP.	7,540	1.0	208	3 109	116 125	AAON RN 018 8 0 GA05 38B	158x101x60	3,800 LBS	
RTU-4	ROOF	NEW ADDITION - ANIMAL SHELTER AREA	2" PLEATED / MERV 8	4" PLEATED / MERV 13	803	66.7	49.8	49.5	209	136	227	19.9	4	14	2	R-410A	2	30	PROP.	7,540	1.0	208	3 122	130 150	AAON RN 020 8 0 GA05 38B	158x101x60	3,800 LBS	

VARIABLE AIR VOLUME TERMINAL UNIT SCHEDULE (OUTSIDE AIR COMPLIANCE AS PER 2015 MICHIGAN MECHANICAL CODE, TABLE 403.3)

			GENER	RAL											VAV TERM	INAL UNIT DA	ТА						ELECT	RIC REHEA	AT COIL DAT	A				
MARK	PART OF	SERVING	AREA (FT ²)	BASE VENTILATION RATE (CFM/FT ²)		CFM PER PERSON	BASE MINIMUM OUTSIDE AIR REQUIRED IN UNOCCUPIED MODE (CFM)	BASE MINIMUM OUTSIDE AIR REQUIRED IN OCCUPIED MODE (CFM)	OUTSIDE AIR C	OF EXCESS DUTSIDE AIR SUPPLIED (CFM)	COOLING MODE MAXIMUM COOLING SETTING AT THE BOX	COOLING MODE CFM/FT ² AT MAXIMUM COOLING SETTING AT	COOLING MODE MINIMUM COOLING SETTING AT THE BOX	COOLING MODE MINIMUM COOLING SETTING AT THE BOX	HEATING MODE DESIGN AIR QUANTITY (CFM)	VAV TERMINAL UNIT DESIGN BASIS MAKE & MODEL	INLET SIZE	DISCHARGE DIMENSION W/O OUTLET PLENUM (W"xH")	VAV TERMINAL UNIT APPROXIMATE DIMENSIONS WITH ELEC REHEAT COIL (W"xH"xL")	VAV TERMINAL UNIT WEIGHT WITH ELEC REHEAT COIL (LBS)	CALCULATED HEAT LOAD	EAT (°F)	LAT (°F)		DLT ELECTF HEATE CONTR		M/ MCA FU SI			
			A _z	R _a	Pz	R_{p}	R _a A _z	$V_{bz} = R_a A_z + R_p P_z$			(CFM)	THE BOX	(CFM)	(% OF FULL)							мвн кw									
VAV 2-1	RTU-2	125 CAT PLAY / VISIT ROOM; 126 CAT PLAY ROOM; 127 CAT PLAY ROOM	300	0.06	1	5	18	23			320	1.07	75	23%	160	TRANE VCEF	6	11 x 10	11 x 10 x 46.5	67	5.18 1.52	65	95	2.0 20	08/3 SCR E	H 6.94	8.67 1	5 M-11:	3 SEE NOTE 1 THR	J 4
VAV 2-2	RTU-2	128 FELINE KENNEL	720	0.06	8	5	43	83			1,130	1.57	165	15%	565	TRANE VCEF	10	14 x 12	14 x 12 x 46.5	81	18.31 5.36	65	95	5.5 20	08/3 SCR E	H 13.88	17.35 2	0 M-11:	3 SEE NOTE 1 THR	J 4
VAV 2-3	RTU-2	131 MECHANICAL ROOM; 132 INTAKE / CHECK-IN; 133 CAT ISOLATION; 134 DOG ISOLATION; 135 ENTRY / FOYER & 136 CAT HOLD/ CAT RECOVERY	1156	0.06	8	5	69	109] 100% outside	F AIR UNIT	1,390	1.20	250	18%	695	TRANE VCEF	10	14 x 12	14 x 12 x 46.5	81	22.52 6.60	65	95	7.0 20	08/3 SCR E	H 13.88	17.35 2	0 M-11:	3 SEE NOTE 1 THR	J 4
VAV 2-4	RTU-2	142 VOLUNTEER ROOM; 144 EXIST MECH RM ROOM & 137 HALLWAY	537	0.06	6	5	32	62			600	1.12	100	17%	300	TRANE VCEF	8	11 x 10	11 x 10 x 46.5	67	9.72 2.85	65	95	3.0 20	08/3 SCR E	H 9.72	12.14 1	5 M-11	3 SEE NOTE 1 THR	J4
VAV 2-5	RTU-2	139 EUTH ROOM; 140 DOG HOLD & 141 DOG RECOVERY	595	0.06	5	5	36	61		l l	660	1.11	105	16%	330	TRANE VCEF	8	11 x 10	11 x 10 x 46.5	67	10.69 3.13	65	95	3.5 20	08/3 SCR E	H 9.72	12.14 1	5 M-11:		
	TOT	TAL FOR ALL VAV BOXES (PART OF 16 TON RTU-2)	3,308		28		198	338			4,100	1.24	695	17%	2,050						66 19.46			21.00						
				1						1				1					1	1					1		1 1			
VAV 3-1	RTU-3	LOBBY 100; VESTIBULE 101 & RECEPTION 102	490	0.06	4	5	29	49	50	101%	675	1.38	105	16%	338	TRANE VCEF	8	11 x 10	11 x 10 x 46.5	67	10.94 3.20	65	95	3.5 20	08/3 SCR E	H 9.72	12.14 1	5 M-11	2 SEE NOTE 1 THR	74
VAV 3-2	RTU-3	MEN'S TOILET ROOM 103; WOMEN'S TOILET ROOM 104 & HALLWAY 119	560	0.06	0	5	34	34	50	149%	500	0.89	100	20%	250	TRANE VCEF	6	11 x 10	11 x 10 x 46.5	67	8.10 2.37	65	95	2.5 20	08/3 SCR E	H 6.94	8.67 1	5 M-11	2 SEE NOTE 1 THR	14
VAV 3-3	RTU-3	MULTI PURPOSE ROOM 105	570	0.06	8	5	34	74	75	101%	900	1.58	105	12%	450	TRANE VCEF	8	11 x 10	11 x 10 x 46.5	67	14.58 4.27	65	95	4.5 20	08/3 SCR E	H 12.49	15.61 2	0 M-11	2 SEE NOTE 1 THR	14
VAV 3-4	RTU-3	STOR 106; DOG RMS/VISIT 107 - 109 & HALLWAY 119 & MECH / ELEC 110	424	0.06	7	5	25	60	75	124%	1,000	2.36	165	17%	500	TRANE VCEF	10	14 x 12	14 x 12 x 46.5	81	16.20 4.75	65	95	5.0 20	08/3 SCR E	H 13.88	17.35 2	0 M-11	2 SEE NOTE 1 THR	14
VAV 3-5	RTU-3	OFFICES 113 & 114; HALLWAY 118	511	0.06	3	5	31	46	50	110%	475	0.93	75	16%	238	TRANE VCEF	6	11 x 10	11 x 10 x 46.5	67	7.70 2.25	65	95	2.5 20	08/3 SCR E	H 6.94	8.67 1	5 M-11	2 SEE NOTE 1 THR	14
VAV 3-6	RTU-3	OFFICES 115 & 116; MECH / ELEC 117	359	0.06	8	5	22	62	75	122%	450	1.25	75	17%	225	TRANE VCEF	6	11 x 10	11 x 10 x 46.5	67	7.29 2.14	65	95	2.5 20	08/3 SCR E	H 6.94	8.67 1	5 M-11	2 SEE NOTE 1 THR	14
VAV 3-7	RTU-3	HALLWAY 111; BREAK ROOM 112 & HALL WAY 120	918	0.06	9	5	55	100	100	100%	1,000	1.09	165	17%	500	TRANE VCEF	10	14 x 12	14 x 12 x 46.5	81	16.20 4.75	65	95	5.0 20	08/3 SCR E	H 13.88	17.35 2	0 M-11	2 SEE NOTE 1 THR	14
	то	TAL FOR ALL VAV BOXES (PART OF 15 TON RTU-3)	3,832		39		230	A25	475		5,000	1.30	790	16%	2,500						81 23.73			25.50						

NOTE 1: FACTORY PROVIDED INTERLOCKING DOOR DISCONNECT SWITCH LOCATED ON THE ELECTRIC HEATER CONTROL PANEL - TYPICAL FOR EACH VAV TERMINAL UNIT

NOTE 2: TRANSFORMER SHALL BE AN INTEGRAL COMPONENT OF THE HEATER CONTROL PANEL DEPENDENT ON UNIT LOAD REQUIREMENTS TO PROVIDE 24VAC FOR CONTROLS - TYPICAL FOR EACH VAV TERMINAL UNIT NOTE 3: FOR ELECTRIC HEATER ACCESS, SIDE HINGED DOOR MUST HAVE MINIMUM DISTANCE (CLEARANCE) OF 36 INCHES

NOTE 4: BREATHING ZONE OUTDOOR AIRFLOW REQUIREMENT (Vbz) (2015 MICHIGAN MECHANICAL CODE - SECTION 403.3.1.1.1.1 & TABLE 403.3.1.1)

 $V_{bz} = R_a A_z + R_p P_z \dots (EQUATION 4-1)$

WHERE:

 A_z = ZONE FLOOR AREA \mathbf{P}_{z} = ZONE POULATION

 $\mathbf{R}_{\mathbf{p}}$ = people outdoor air rate R_{a} = area outdoor air rate



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Client: City of Taylor 23555 Goddard Rd. Taylor, MI 48180

Project:

City of Taylor Animal Shelter Remodel & Expansion

25555 Northline Rd. Taylor, MI 48180

Seal:

Date 12/21/2023 01/17/2024



Issued Fo
OWNER REVIEW
PERMIT SET

Drawn:	KWG
Checked:	CM
Approved:	WAD



Project Number: 22712.A

Sheet Number: M-900

					E	XHAUS	ST FAN	SCHE	DULE	Ξ					
										ELEC	TRICAL	DESIGN	BASIS		
TAG	SERVING	LOCATION	FAN TYPE	AIR QUANTITY (CFM)	EXT. ST. PR. (IN. W.C.)	RPM	DRIVE	BHP	HP	VOLT	PHASE	MAKE	MODEL	DRAWING NUMBER	REMARKS
EF-1	PUBLIC TOILET ROOMS 103 & 104	ROOF	DOWNBLAST	300	0.375	1,550	DIRECT	0.06	1/20	120	1	GREENHECK	G-080-D	M-112	PRE-FAB ROOF CURB, GRAVITY E DAMPER. INTERLOCK w/ R
EF-2	QUARANTEEN 152	ROOF	DOWNBLAST	250	0.375	1,300	DIRECT	0.04	1/30	120	1	GREENHECK	G-085-G	M-114	PRE-FAB ROOF CURB, GRAVITY E DAMPER. INTERLOCK w/ R
EF-3	EUTH. 139, DOG RECOVERY 140 & 141	ROOF	DOWNBLAST	690	0.375	1,285	DIRECT	0.11	1/6	120	1	GREENHECK	G-099-B	M-113	PRE-FAB ROOF CURB, GRAVITY E DAMPER. INTERLOCK w/ R
EF-4	EMPLOYEE TOILETS 121 & 122 AND SHOWER 123	ROOF	DOWNBLAST	375	0.375	1,300	DIRECT	0.05	1/25	120	1	GREENHECK	G-095-G	M-113	PRE-FAB ROOF CURB, GRAVITY E DAMPER. INTERLOCK w/ R
EF-5	MECHANICAL ROOM 110	ROOF	DOWNBLAST	125	0.375	1,550	DIRECT	0.02	1/30	120	1	GREENHECK	G-065-D	M-112	PRE-FAB ROOF CURB, GRAVITY E DAMPER. INTERLOCK w/ R
EF-6	CHECK-IN 132, CAT ISO. 133, DOG ISO. 134 & Cat Recovery 136	ROOF	DOWNBLAST	930	0.375	1,350	DIRECT	0.14	1/6	120	1	GREENHECK	G-103-b	M-113	PRE-FAB ROOF CURB, GRAVITY E DAMPER. INTERLOCK w/ R
EF-7	DELIVERY/PICK-UP/STORAGE 138	ROOF	DOWNBLAST	300	0.375	1,550	DIRECT	0.06	1/20	120	1	GREENHECK	G-080-D	M-113	PRE-FAB ROOF CURB, GRAVITY E DAMPER. MANUAL WALL SWITCH

		D	IFF	USER, I	REG	SIS	TE	R	AN	DC	GR	IL	LE	SC	HE	EDI	JLE
				ACCESSO	RIES		MAT	TER	IAL	FIN	SH		С	OLO	R		
TAG	SERVICE & TYPE	MODEL NUMBERS (DESIGN BASIS)	CONTROL GRID	OPPOSED BLADE DAMPER SQ. TO ROUND ADAPTER	SEPARATE PLASTER FRAME	INLET DAMPER	STEEL	ALUMINUM	OTHER	BAKEU ENAMEL LACQUER	ANODIZED	STANDARD BLACK	CLEAR OR LACQUER	STD OFF-WHITE	MATCH T-BAR	MATCH CEILING	REMARKS
CD-A	LOUVERED FACE CEILING DIFFUSER	TITUS MODEL TDC-AA		x				х	3	x				х			BORDER TYPE - LAY IN
CD-B	PLENUM SLOT DIFFUSER	TITUS MODEL ML-39			х	x	x		3	x				x			(4) 1" SLOTS; 48"L.; MP-39 PLENUM; SURFACE MOUNT w/ PLASTER F
CD-C	PLENUM SLOT DIFFUSER	TITUS MODEL ML-39			х	х	x		3	x				х			(4) 1" SLOTS; 48"L.; FABRICATED DUCT PLENUM; SURFACE MOUNT w/ FRAME
CD-D	DUCT MOUNTED SUPPLY AIR GRILLE	TITUS MODEL 300RL		х			x]	x				x			FABRICATED PAINTED SHEET METAL BOOT; SEE DETAIL, SHT. M
CD-E	SURFACE MOUNTED SUPPLY AIR GRILLE	TITUS MODEL 300RL		x			x		3	x				x			
RG-A	PERFORATED CEILING RETURN AIR GRILLE	TITUS MODEL PAR-AA						х	3	x				x			BORDER TYPE - LAY IN
RG-B	SURFACE MOUNTED RETURN AIR GRILLE	TITUS MODEL 350ZRL						х	3	x				х			0 DEGREE DEFLECTION
EG-A	EXHAUST AIR GRILLE	TITUS MODEL 350		x			x]	x				x			SURFACE CEILING OR DUCT MOUNT
EG-B	PERFORATED CEILING EXHAUST AIR GRILLE	TITUS MODEL PAR-AA		x			x		3	x				x			BORDER TYPE - LAY IN
RG-B EG-A	SURFACE MOUNTED RETURN AIR GRILLE EXHAUST AIR GRILLE PERFORATED CEILING EXHAUST AIR	TITUS MODEL 350ZRL TITUS MODEL 350					x x	x		x x x				x x			0 DEGREE DEFLECTION SURFACE CEILING OR DUCT MOUNT

REFER TO ARCHITECTURAL SPECIFICATIONS, RE

2. REFER TO DRAWINGS FOR NECK SIZES.

NOTES

1. MODEL NUMBERS ARE FOR GENERAL IDENTIFICATION. SPECIFIC MODEL NUMBERS DEPEND ON APPLICABLE NOTES AND ARCHITECTURAL PLANS. VERIFY MOUNTING TYPE AND DIMENSIONS WITH ARCHITECTURAL WORK.



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Client: City of Taylor 23555 Goddard Rd. Taylor, MI 48180

Project:

City of Taylor Animal Shelter Remodel & Expansion

25555 Northline Rd. Taylor, MI 48180 Seal:




Date 01/17/2024

Issued For PERMIT SET

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Checked:	CM
Approved:	WAD



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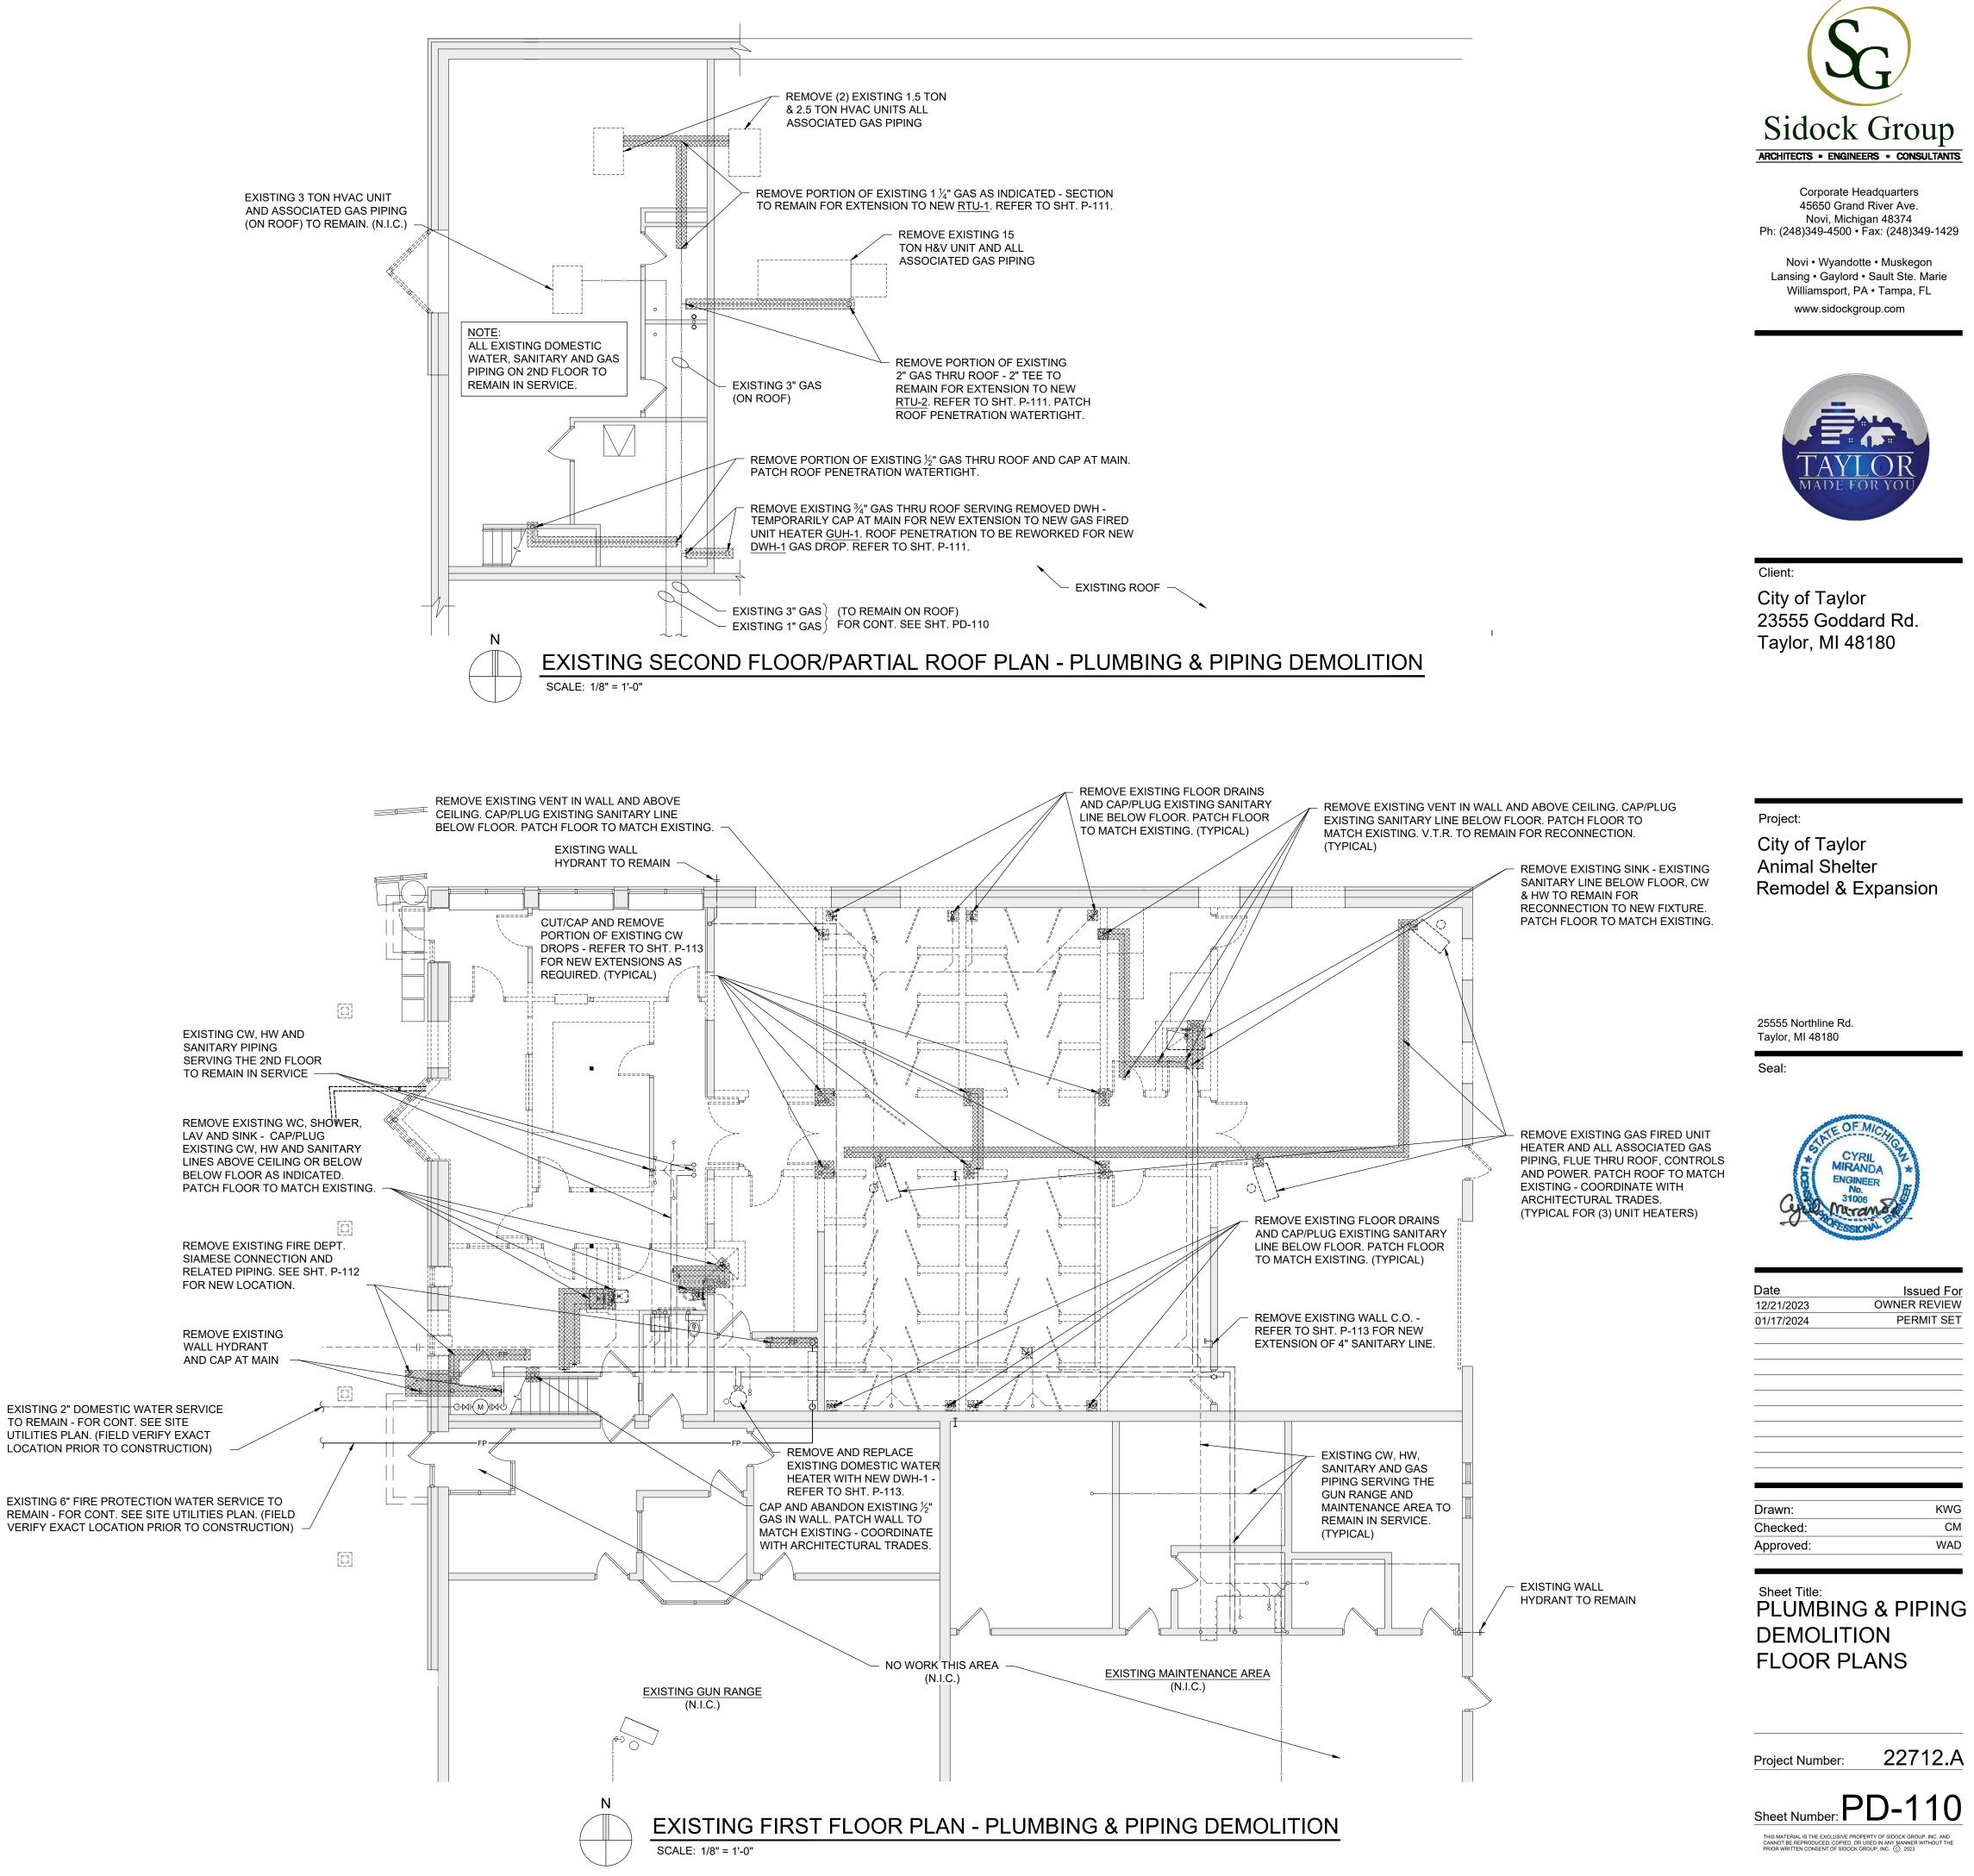


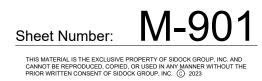RKS

GRAVITY BACKDRAFT RLOCK w/ RTU-3. GRAVITY BACKDRAFT RLOCK w/ RTU-4. GRAVITY BACKDRAFT RLOCK w/ RTU-2. GRAVITY BACKDRAFT RLOCK w/ RTU-1. GRAVITY BACKDRAFT RLOCK w/ RTU-3. , GRAVITY BACKDRAFT RLOCK w/ RTU-2. GRAVITY BACKDRAFT L SWITCH CONTROL.

w/ PLASTER . M-114

ER FRAME










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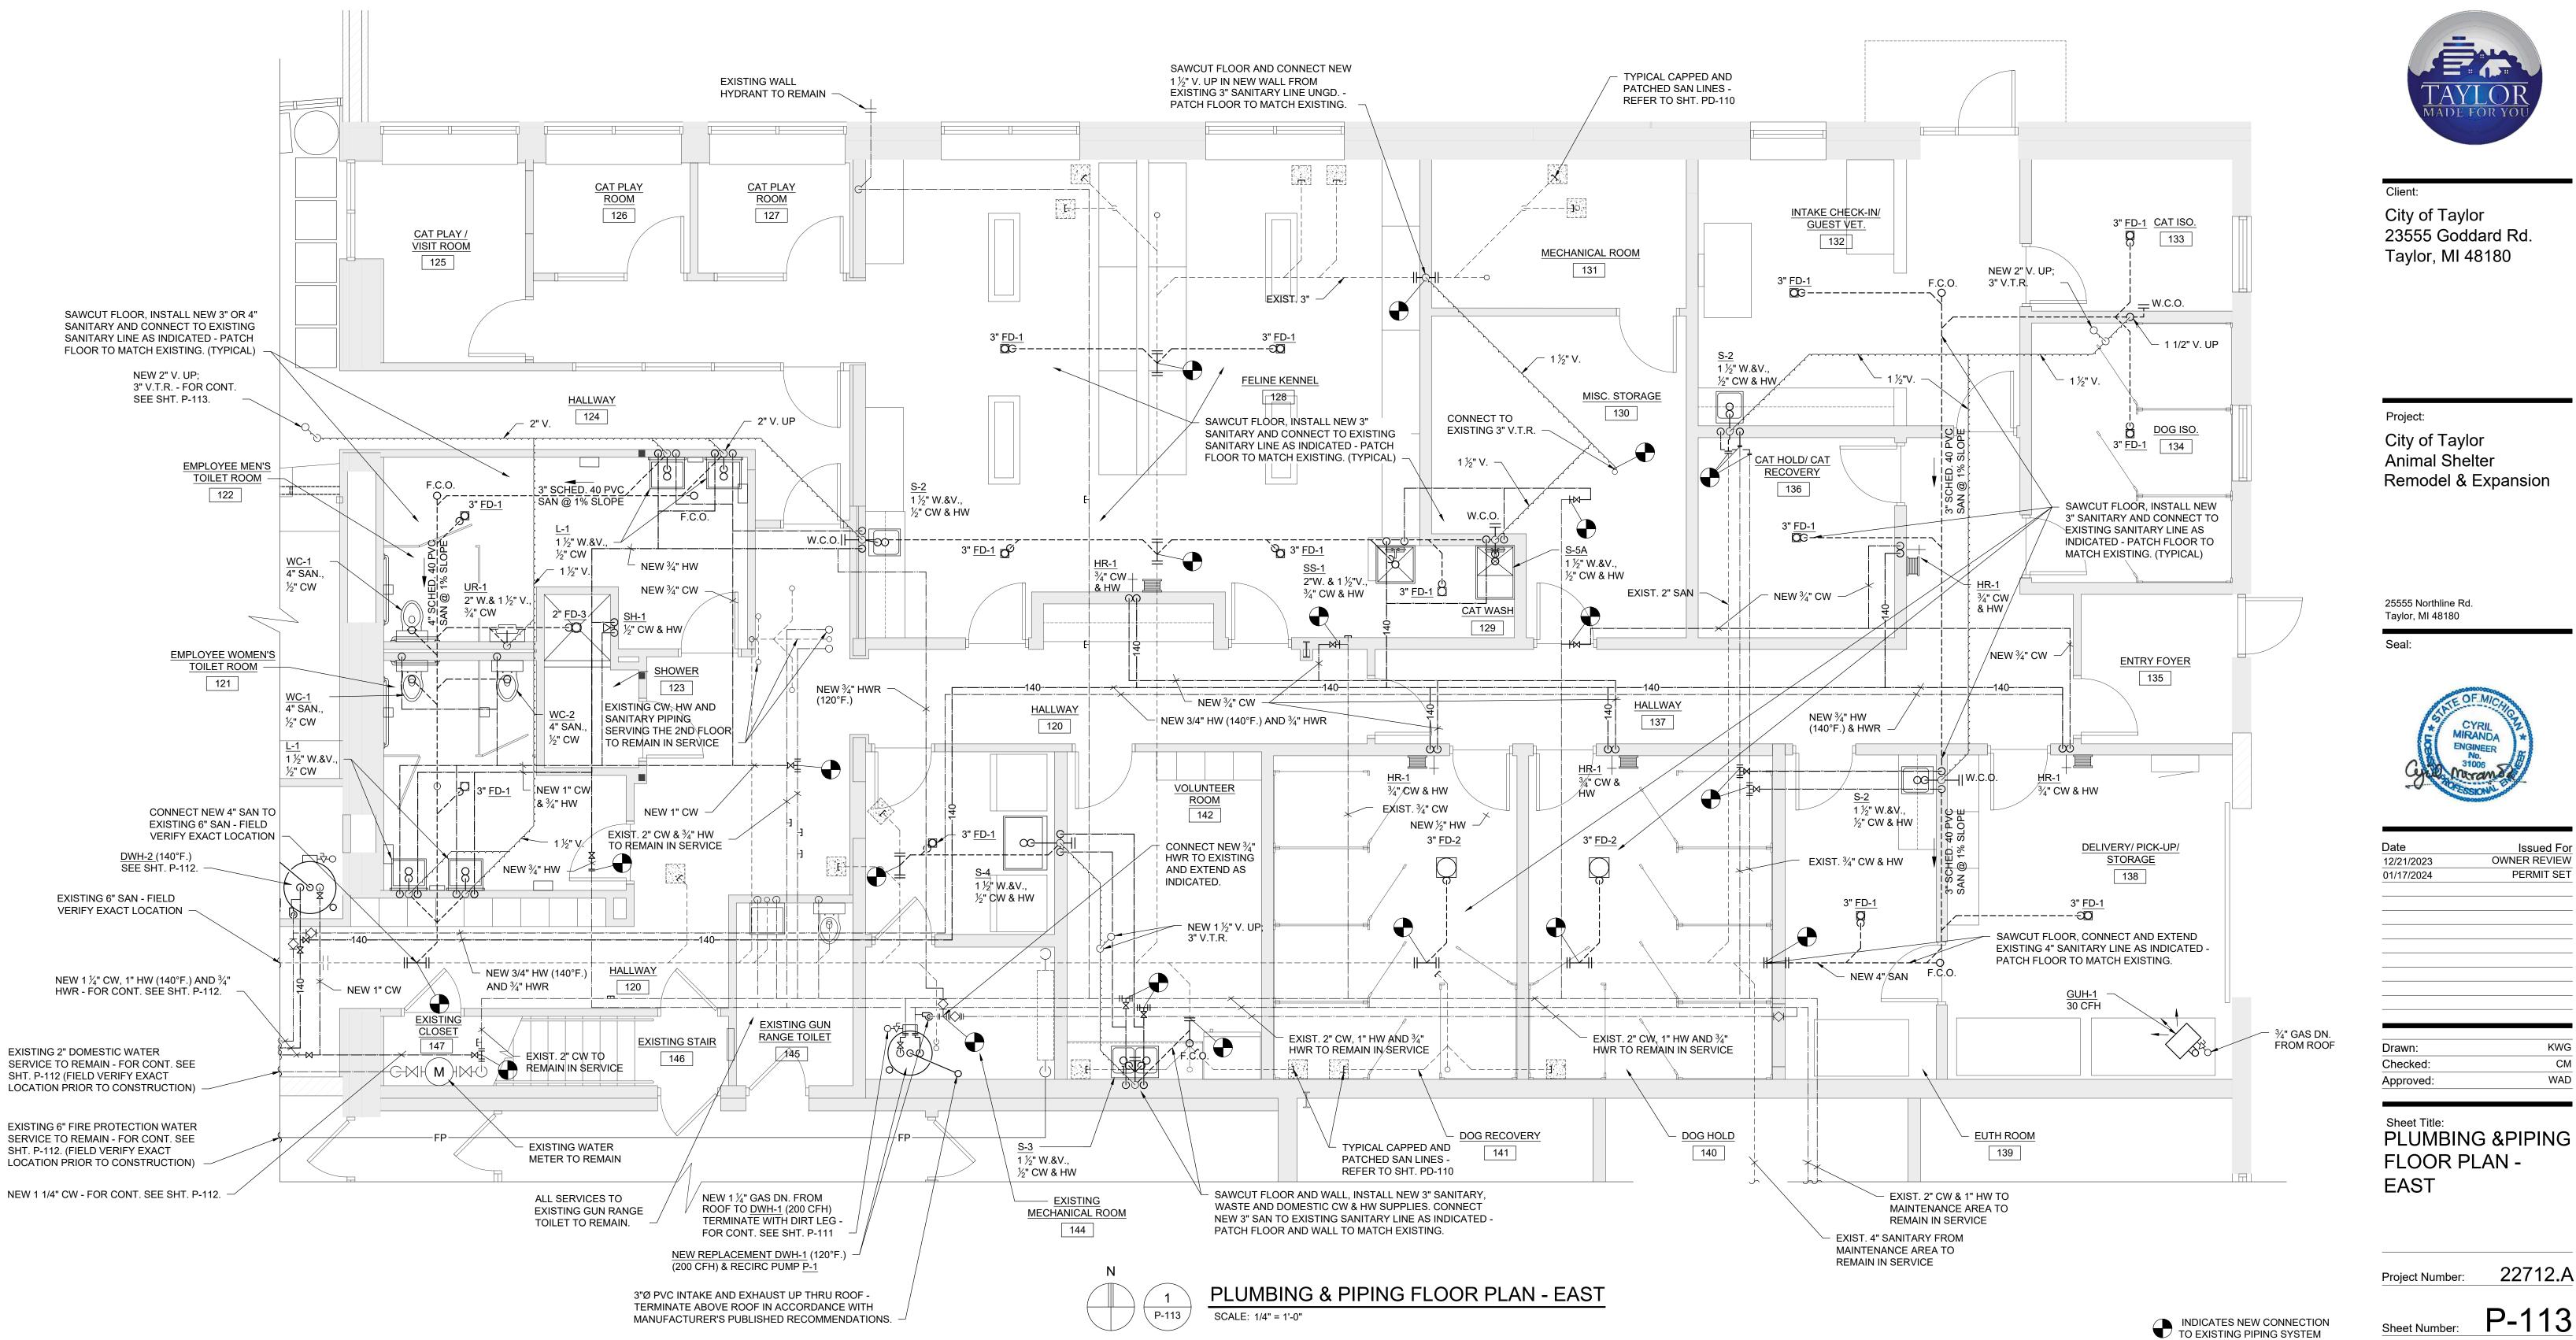
PLUMBING & PIPING OVERALL FIRST FLOOR PLAN



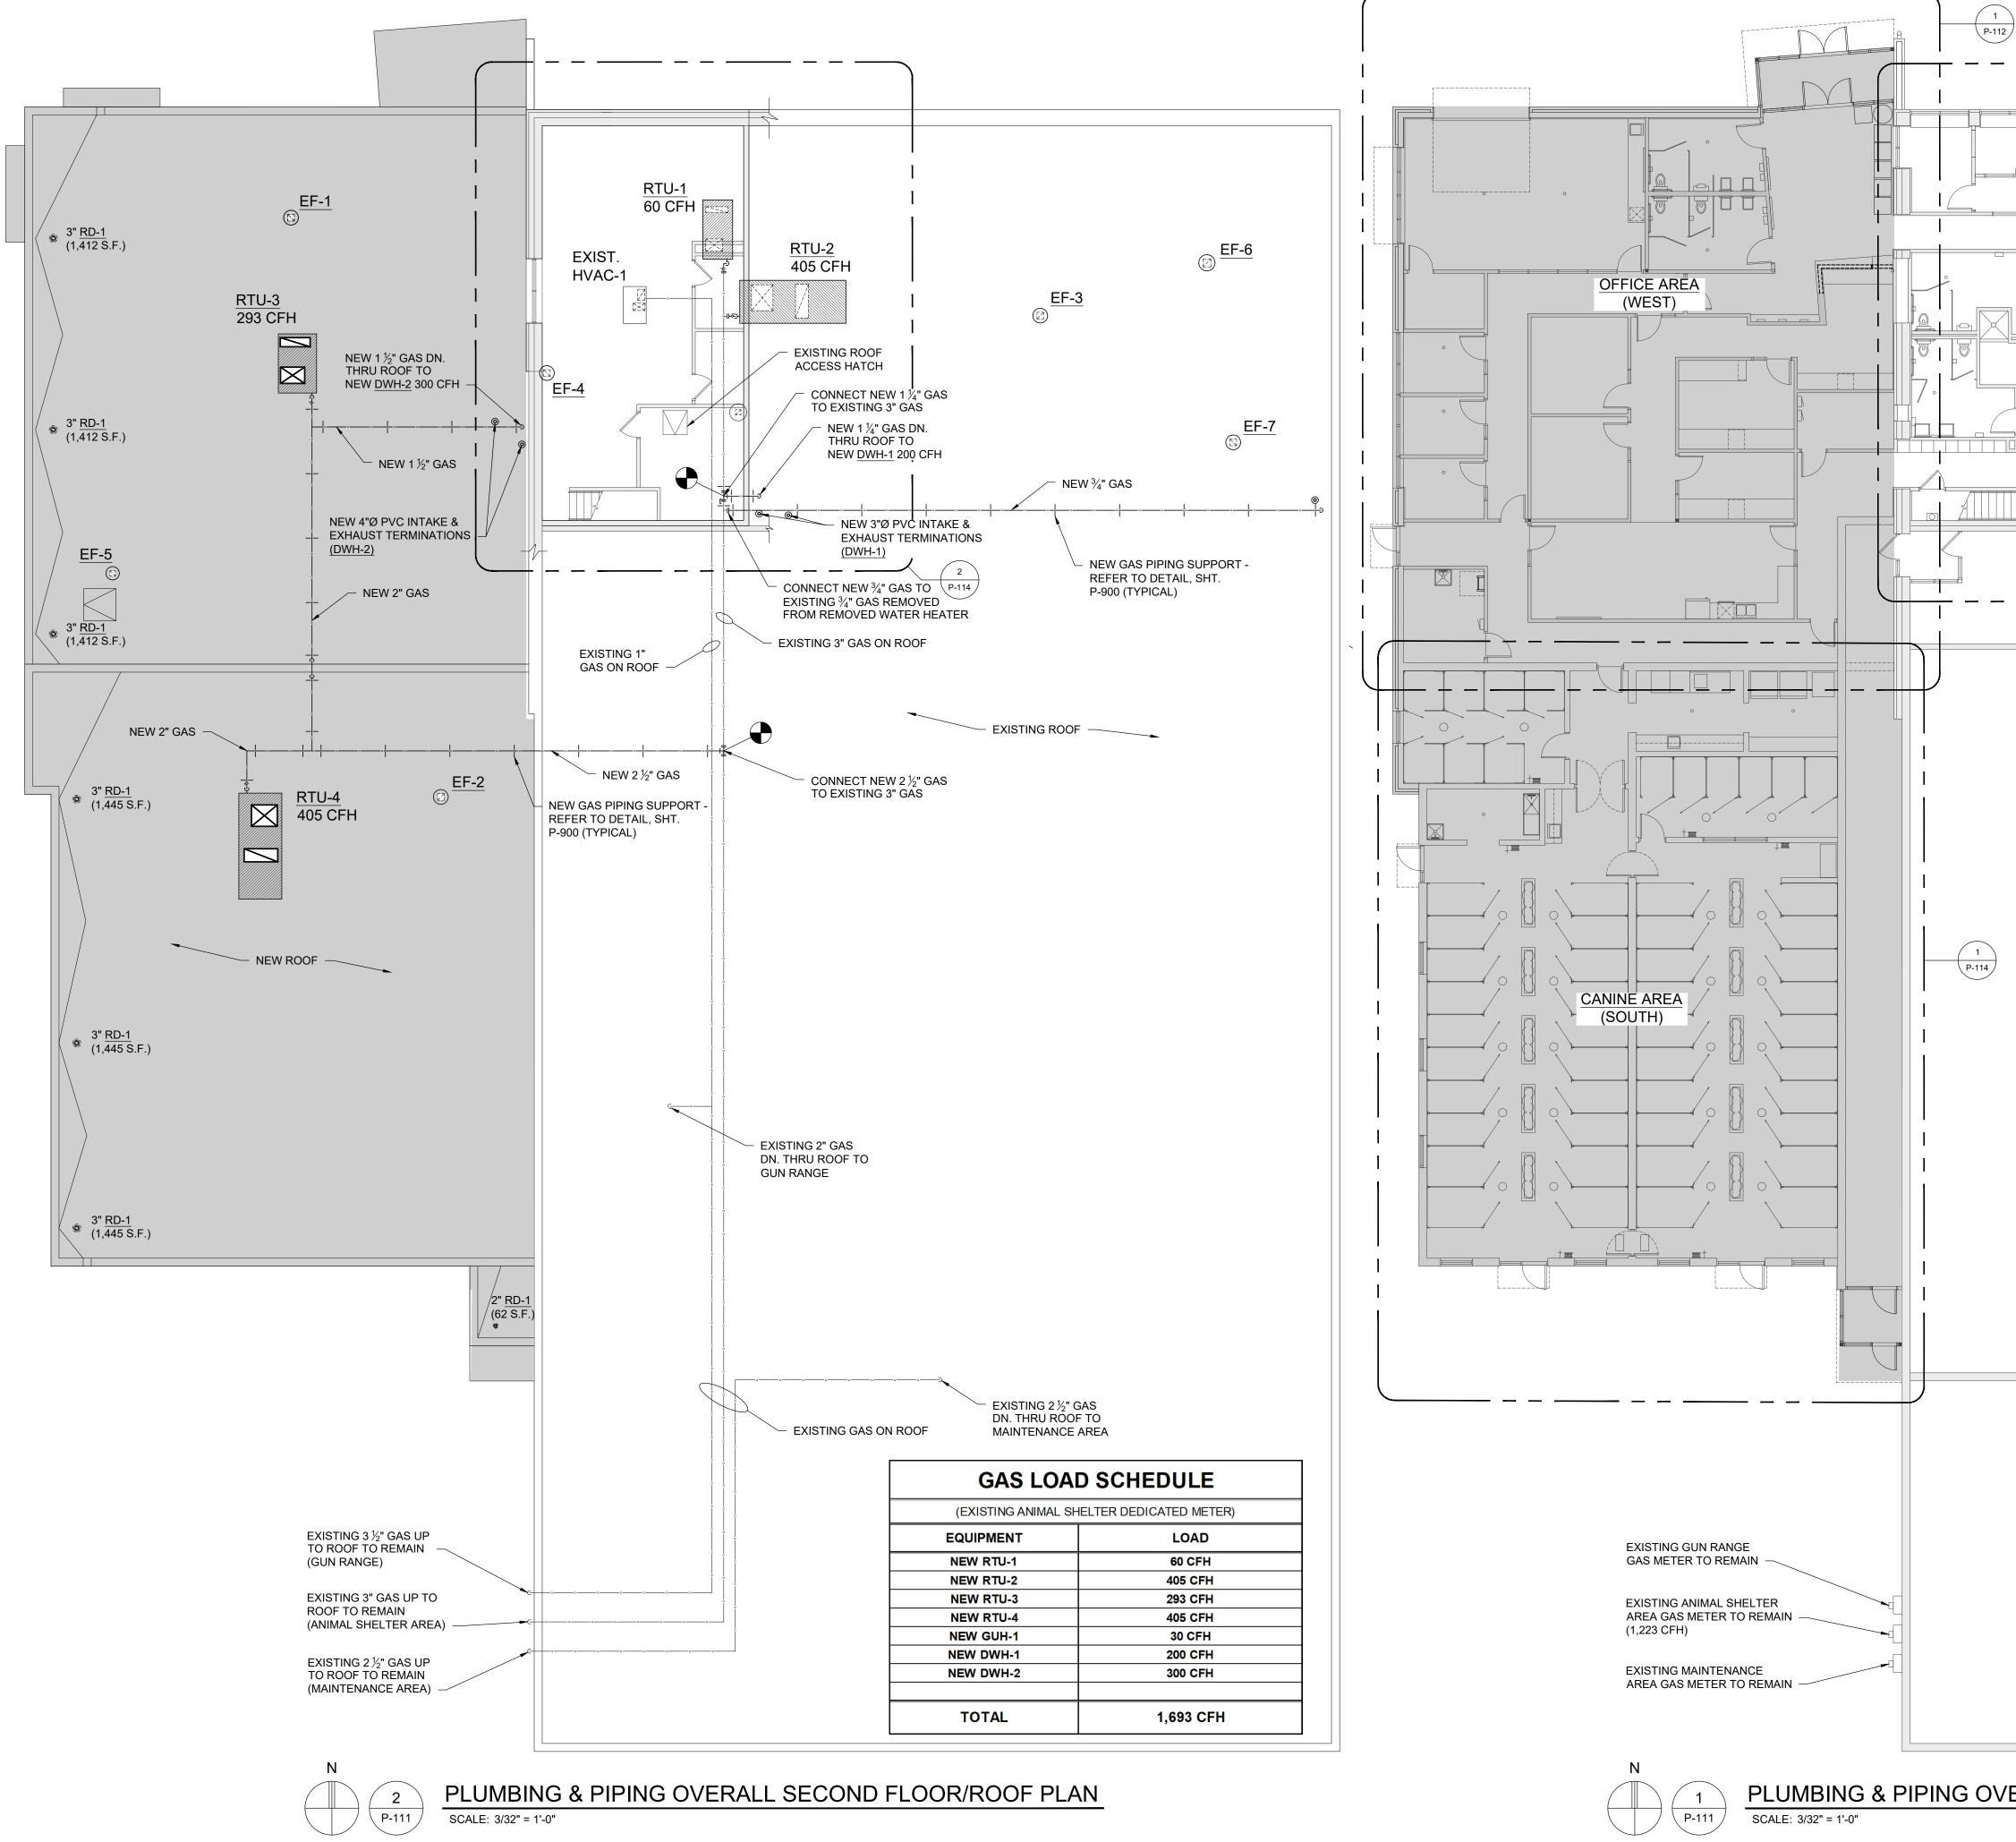

GROUP I CLASSIFICATION. THE FIRE PROTECTION CONTRACTOR SHALL BE RESPONSIBLE FOR THE ENTIRE SYSTEM DESIGN, APPROVAL AND INSTALLATION AND SHALL SUBMIT TO THE ARCHITECT/ENGINEER FOR RECORD DESIGN DRAWINGS AND HYDRAULIC CALCULATIONS BEARING THE APPROVAL OF THE LOCAL FIRE AUTHORITY.
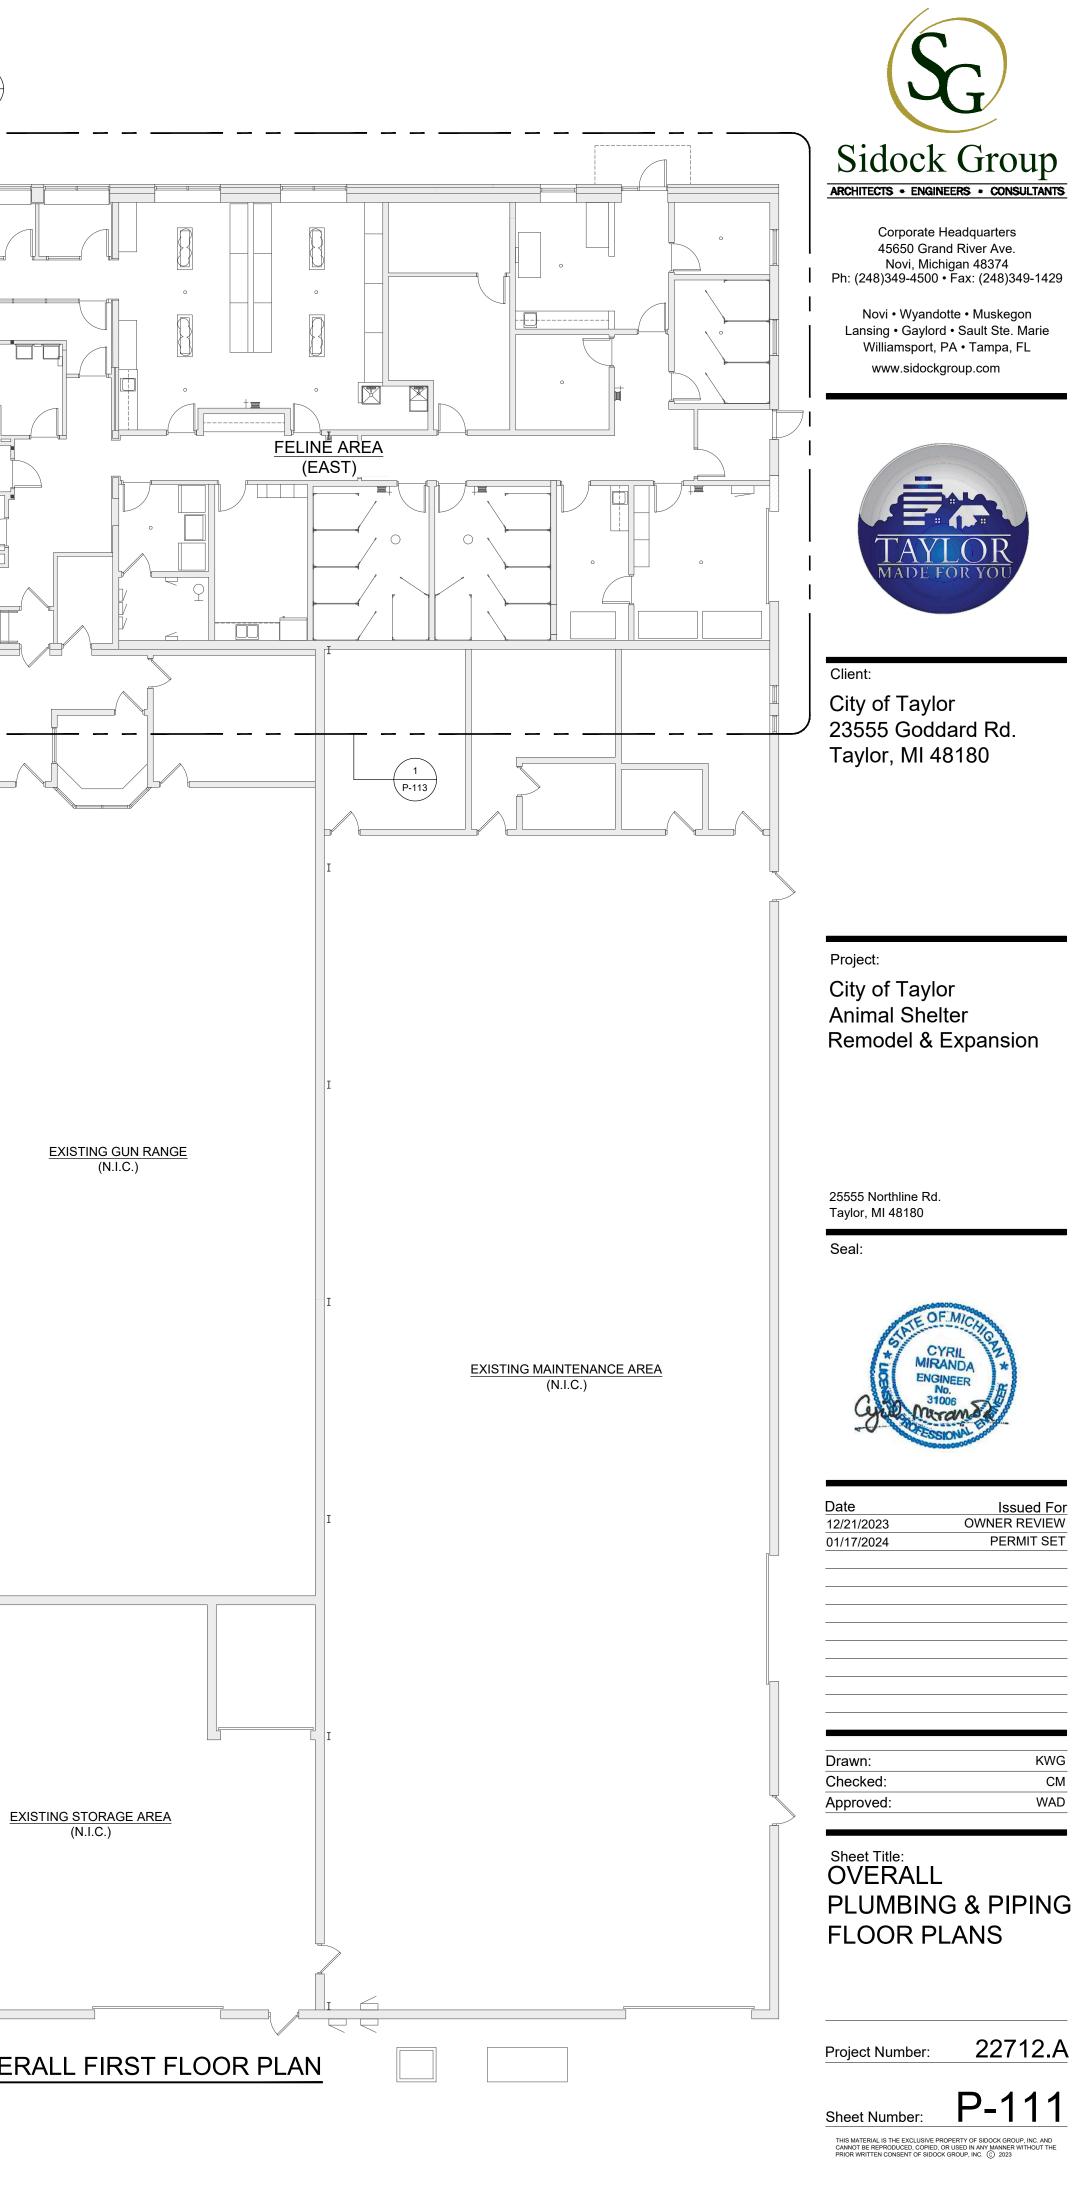
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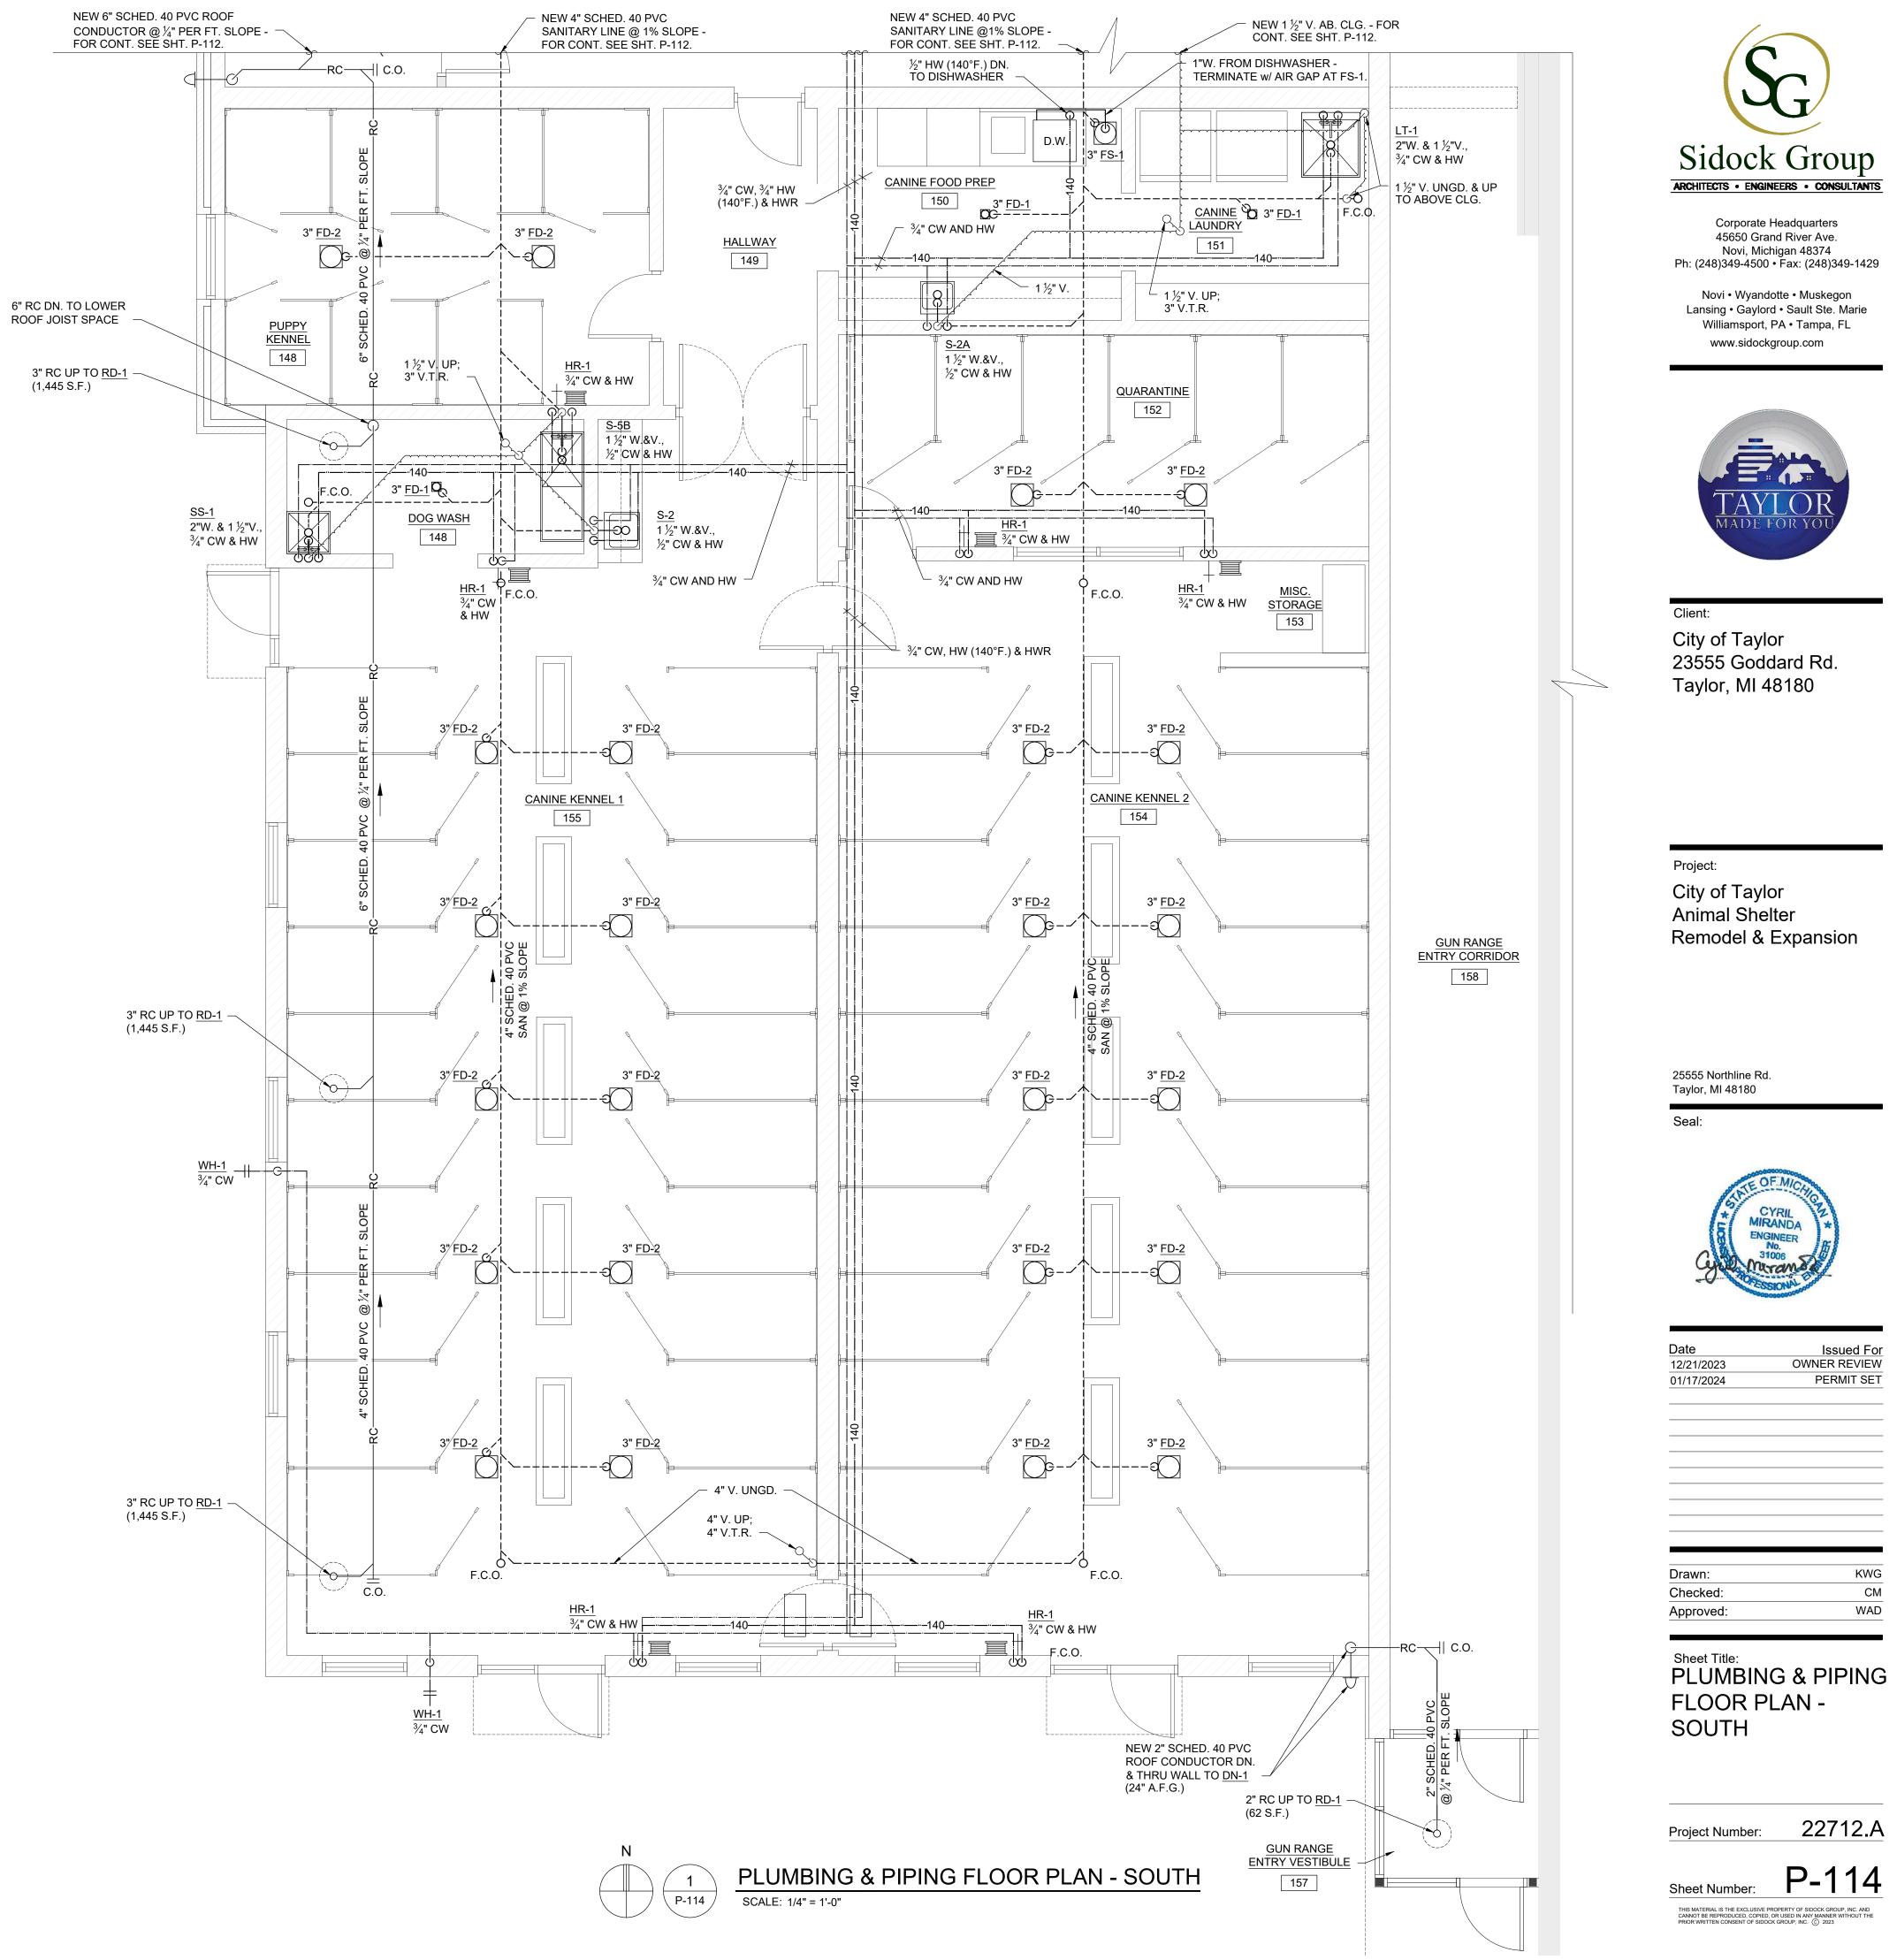


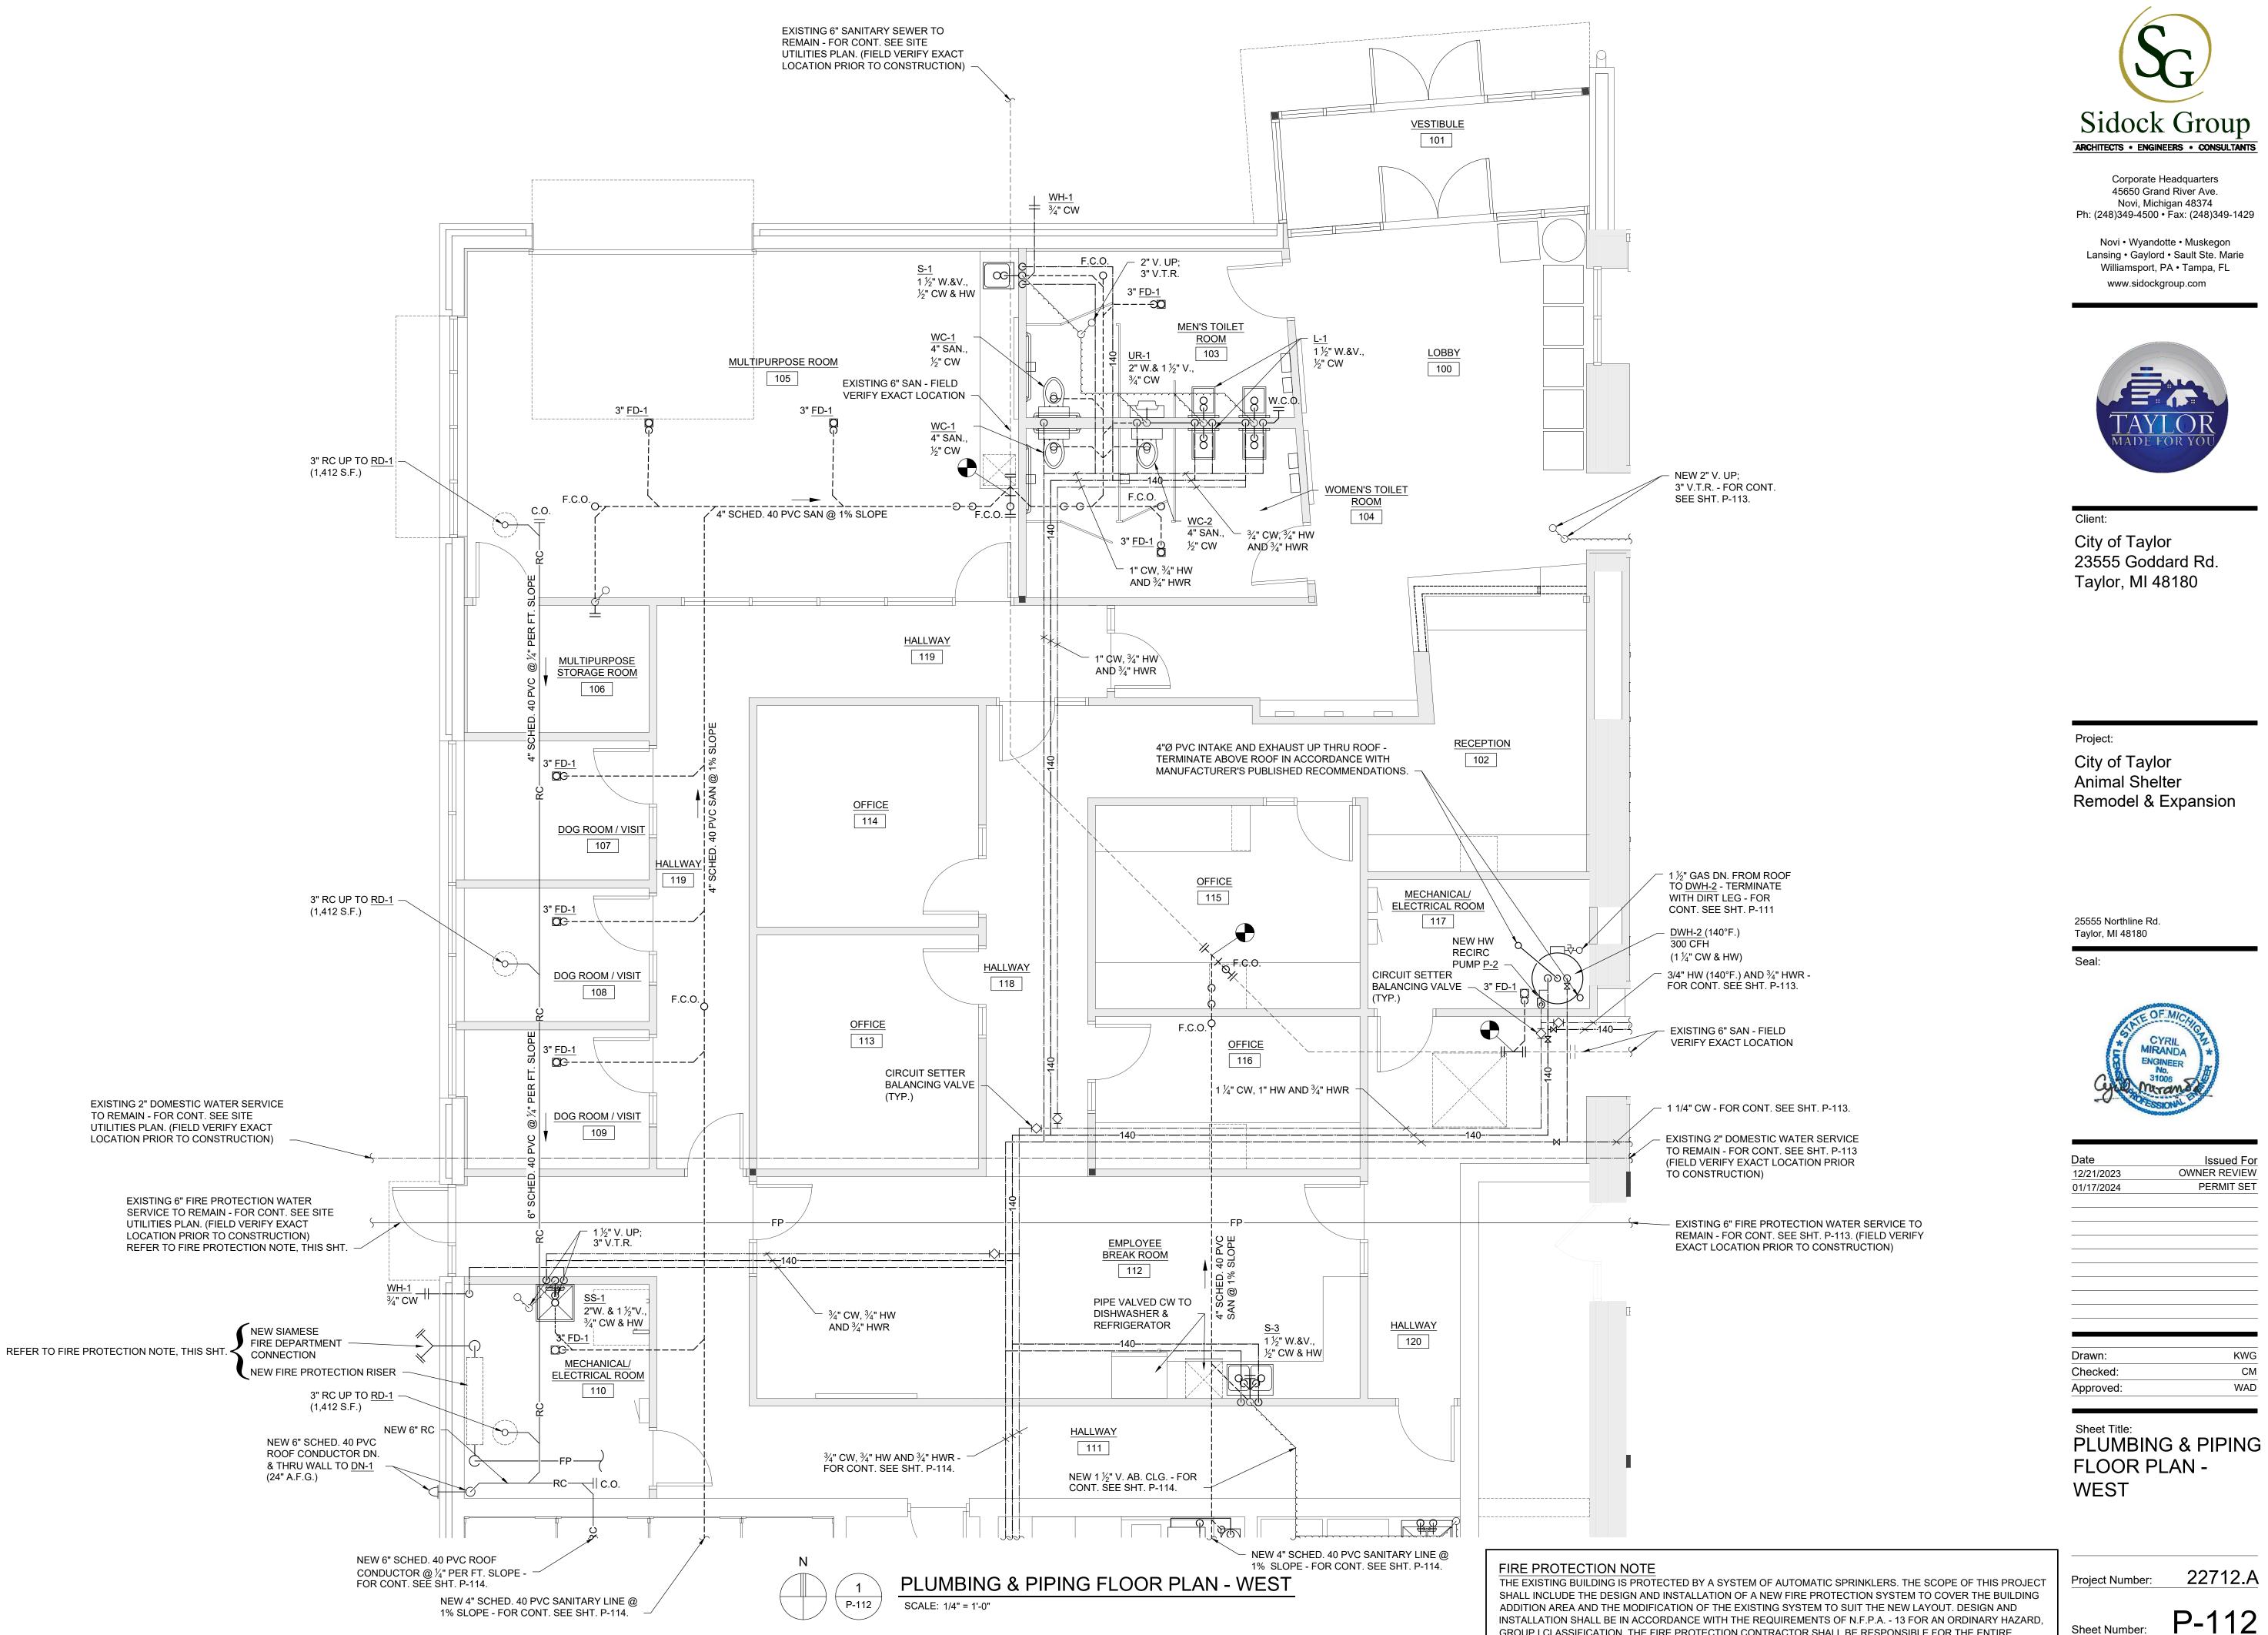

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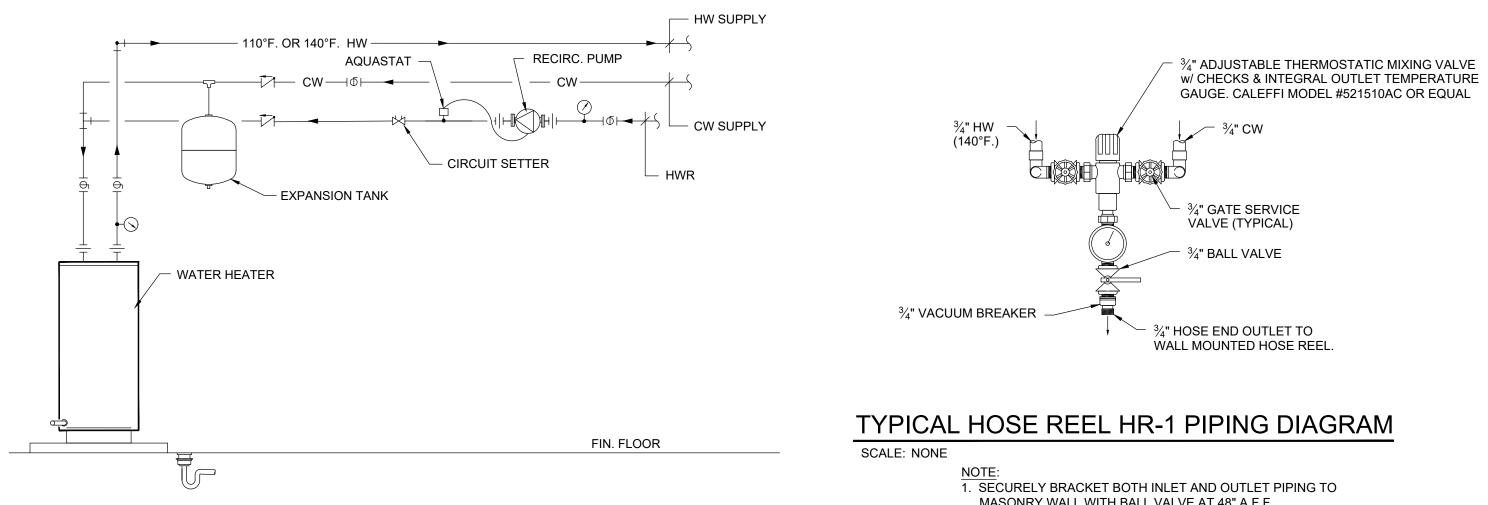
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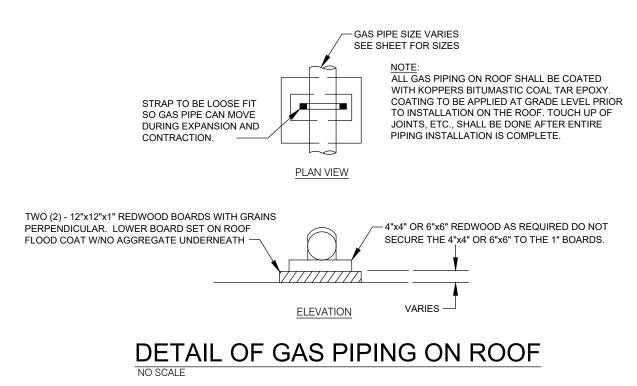


	GAS FIRED UNIT HEATER SCHEDULE													
TAG	SERVING	TYPE	втин оитрит	MOUN	TING	GAS I	DATA		ELECTRICA	L	E	DESIGN BASIS	REMARKS	
TAG	SERVING	ITFE	BION COIPOI	ANGLE	HEIGHT	TYPE	INPUT CFH	VOLT	PHASE	AMPS	MAKE	MODEL NUMBER	REWARKS	
GUH-1	DELIVERY/PICK-UP/STORAGE 138	POWER VENTED	24,000	45 DEGREES	9'-0"	NATURAL	30	120	1	3.7	MODINE	HDS30	24V DIRECT SPARK IGNITION CONTROL w/ PROGRAMMABLE THERMOSTAT; ANGLE MOUNTING KIT; MODINE 3" VERTICAL CONCENTRIC VENT KIT	

			GAS FIRE	D DOMES	STIC WA	TER HE	ATER S	SCHEDU	LE			
				CAPACITIES			GAS DATA					
TAG SYS	SYSTEM SERVED	LOCATION	MANUFACTURER AND MODEL NUMBER	RECOVERY GPH	GALLON CAPACITY	TEMP. RISE	CFH INPUT	TYPE		NOTES/ACCESSORIES		SORIES
DWH-1	DOMESTIC WATER (110d.F.)	EXISTING MECHANICAL ROOM 144	A.O. SMITH BTH-199A Mxi CYCLONE	392	100	60 deg F	200	NATURAL		A, B, C, D		0
DWH-2	DOMESTIC WATER (140d.F.)	MECHANICAL/ ELECTRICAL ROOM 117	A.O. SMITH BTH-300A Mxi CYCLONE	388.00	119	90 deg F	300	NATURAL		A, D, E, F		=
NOTES:		·	•					·				
A. ASME T&	P RELIEF VALVE											
B. 3" PVC II	NTAKE & EXHAUST w/ ROO	F TERMINATIONS										
C. WATTS N	MODEL #DETA-5 EXPANSIC	N TANK										
D. TACO MO	DDEL #003 DOMESTIC REC	IRC PUMP w/ STRAP-ON	AQUASTAT. 1/40 HP, 115V/1	ph./60hz./0.43A								
E. 4" PVC II	NTAKE & EXHAUST w/ ROOF	TERMINATIONS										
F. WATTS N	IODEL #DETA-20 EXPANSI	ON TANK										







MASONRY WALL WITH BALL VALVE AT 48" A.F.F. 2. MOUNT HOSE REEL AT 7'-0" A.F.F. TO BOTTOM OF REEL.

				PLU	MBING FIXTU	JRE SCHED	ULE						
			FIXTURE (DESIGN BASIS)		TR	IM (DESIGN BAS	IS)		XTURE C	CONNEC	TION SIZE	S	
TAG	FIXTURE	MFR.	MODEL NAME	MODEL NO.	TRIM	MFR.	MODEL NO.	ELEC REQ	cw	HW	WASTE	VENT	REMARKS
WC-1 A.D.A.)	WATER CLOSET - TANK TYPE (ADA)	AMERICAN STANDARD	CHAMPION PRO 2-PIECE 1.28 GPF CHAIR HEIGHT ELONGATED TOILET	211AA104 (1.28 GPF)	SLOW-CLOSE ELONGATED SEAT	AMERICAN STANDARD	5359C051H		1/2		4	2	A,B,C
NC-2	WATER CLOSET - TANK TYPE	AMERICAN STANDARD	CHAMPION PRO 2-PIECE 1.6 GPFSTANDARD HEIGHT ELONGATED TOILET	211CA004 (1.6 GPF)	SLOW-CLOSE ELONGATED SEAT	AMERICAN STANDARD	5359C051H		1/2		4	2	A,B,C
UR-1	URINAL-WALL MOUNTED (ADA)	AMERICAN STANDARD	WASHBROOK 0.125 – 1.0 GPF TOP SPUD URINAL	6590001.020 (1.0 GPF)	FLUSH VALVE	SLOAN ROYAL	186-1 (1.0 GPF)		3/4		2	1 1/2	А
L-1 A.D.A.)	WALL MOUNT LAVATORY	AMERICAN STANDARD	LUCERNE	355.012	4" CENTERSET SINGLE HANDLE FAUCET w/ LEVER HANDLE (0.5 GPM)	AMERICAN STANDARD	7385050.002		1/2	1/2	1 1/2	1 1/2	A,B,C,D,E,F,G,H
S-1	15"x15"x7 1/8" 18GA. DEEP SINGLE COMPARTMENT SS SINK	ELKAY	LUSTERTONE CLASSIC STAINLESS STEEL 15" x 15" x 7-1/8" 1-HOLE SINGLE BOWL DROP-IN BAR SINK w/ FAUCET	BLR150C	FAUCET	ELKAY	LKD2223C (INCLUDED)		1/2	1/2	1 1/2	1 1/2	A,B,E,H
S-2	17"x20"x7 5/8" DEEP 18GA. SINGLE COMPARTMENT SS SINK	ELKAY	LUSTERTONE CLASSIC STAINLESS STEEL 17" x 20" x 7-5/8" 2-HOLE SINGLE BOWL DROP-IN SINK w/ FAUCET	LR1720C	FAUCET	ELKAY	LK406GN04T4C (INCLUDED)		1/2	1/2	1 1/2	1 1/2	A,B,E,H
S-3	33"x22"x8 1/8" DEEP 18 GA. DOUBLE COMPARTMENT SS SINK	ELKAY	LUSTERTONE CLASSIC STAINLESS STEEL 33" x 22" x 8-1/8" 3-HOLE DOUBLE BOWL DROP-IN SINK	LR3322PD	FAUCET	DELTA	2100LF		1/2	1/2	1 1/2	1 1/2	A,B,E,H
S-4	39" x 27-1/2" x 14" DEEP 14 GA. FLOOR MOUNT SINGLE COMPARTMENT SS SCULLERY SINK	ELKAY	WELDBILT STAINLESS STEEL 39" x 27-1/2" x 14" FLOOR MOUNT SINGLE COMPARTMENT SCULLERY SINK	WNSF81362	FAUCET STRAINER	ELKAY	LK940VS07T4S LKPDVR18B		1/2	1/2	1 1/2	1 1/2	A,E
S-5A	CAT WASH STATION	VECOR	34" S.S. PROFESSIONAL CAT GROOMING/WASH TUB w/ FAUCET AND WALK-IN RAMP	VV- PET34SSZKM	FAUCET	VECOR	INCLUDED		1/2	1/2	1 1/2	1 1/2	A,B,E,H
S-5B	DOG WASH STATION	VECOR	62" S.S. PROFESSIONAL DOG GROOMING/WASH TUB w/ FAUCET AND WALK- IN RAMP	VV- CWZG201BXG- 62IN	FAUCET	VECOR	INCLUDED		1/2	1/2	1 1/2	1 1/2	A,B,E,H
SS-1	SERVICE SINK - FLOOR MOUNTED	MUSTEE		63M	SERVICE SINK FAUCET	MUSTEE	63.600A		1/2	1/2	2	1 1/2	I
SH-1	SHOWER	SYMMONS	TEMPTROL	C-96-1-X	FAUCET				3/4	3/4	2	-	J
RD-1	ROOF DRAIN	ZURN		Z164							-		к
DN-1	DOWNSPOUT NOZZLE	ZURN		Z199							-		к
NH-1	NON-FREEZE WALL HYDRANT	WOODFORD		B-67					0.75	-		-	
FD-1 FD-2	FLOOR DRAIN FLOOR DRAIN	ZURN ZURN		Z415-BZ1-DP ZN513-HL							-	-	K K
FCO	CLEANOUT	ZURN		Z-1440							-	-	K,M
WCO	WALL CLEANOUT												K

NOTES:

A. PROVIDE ALL SLEEVES, TEMPLATES, ETC. AS REQUIRED FOR ROUGH-IN OF FIXTURES. COORDINATE WITH ARCHITECTURAL TRADES.

B. PROVIDE BRASSCRAFT COMMERCIAL ANGLE STOP(S) WITH SUPPLY RISER(S)

C. COLOR: WHITE

D. PROVIDE BRASSCRAFT 1 1/4" OFFSET DRAIN WITH TAILPIECE

E. PROVIDE BRASSCRAFT 1 1/4" CHROME PLATED CAST BRASS P-TRAP

F. PROVIDE WRAP ON SUPPIES AND WASTE PIPING EQUAL TO MCGUIRE "PRO-WRAP"

G. A.S. #7385.050 "RELIANT 3" LEVER HANDLE CENTERSET FAUCET w/ GRID DRAIN; 4" C.C.

H. POWERS HYDROGUARD #141-650 TEMPERING VALVE

I. 3" MOP SERVICE BASIN SEAL #65.309

J. BOTTOM OF SHOWER HEAD SHALL BE 6'-6" AFF. 2" FLOOR DRAIN WITH 2" TRAP & NICKEL BRONZE TOP. K. SIZE AS NOTED ON DRAWINGS

.. PROVIDE SURE SEAL INLINE FLOOR DRAIN TRAP SEALER

M. FLOOR CLEANOUT WITH COUNTERSUNK PLUG - DURA COATED CAST IRON BODY WITH GAS AND WATERTIGHT ABS TAPERED THREAD PLUG, SIZE SAME AS DRAINAGE.





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Client: City of Taylor 23555 Goddard Rd. Taylor, MI 48180

Project:

City of Taylor Animal Shelter Remodel & Expansion

25555 Northline Rd. Taylor, MI 48180 Seal:



Date 12/21/2023 01/17/2024


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KWG
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Sheet Title: PLUMBING & PIPING SCHEDULES & DIAGRAMS

22712.A Project Number:





NORTHLINE ROAD

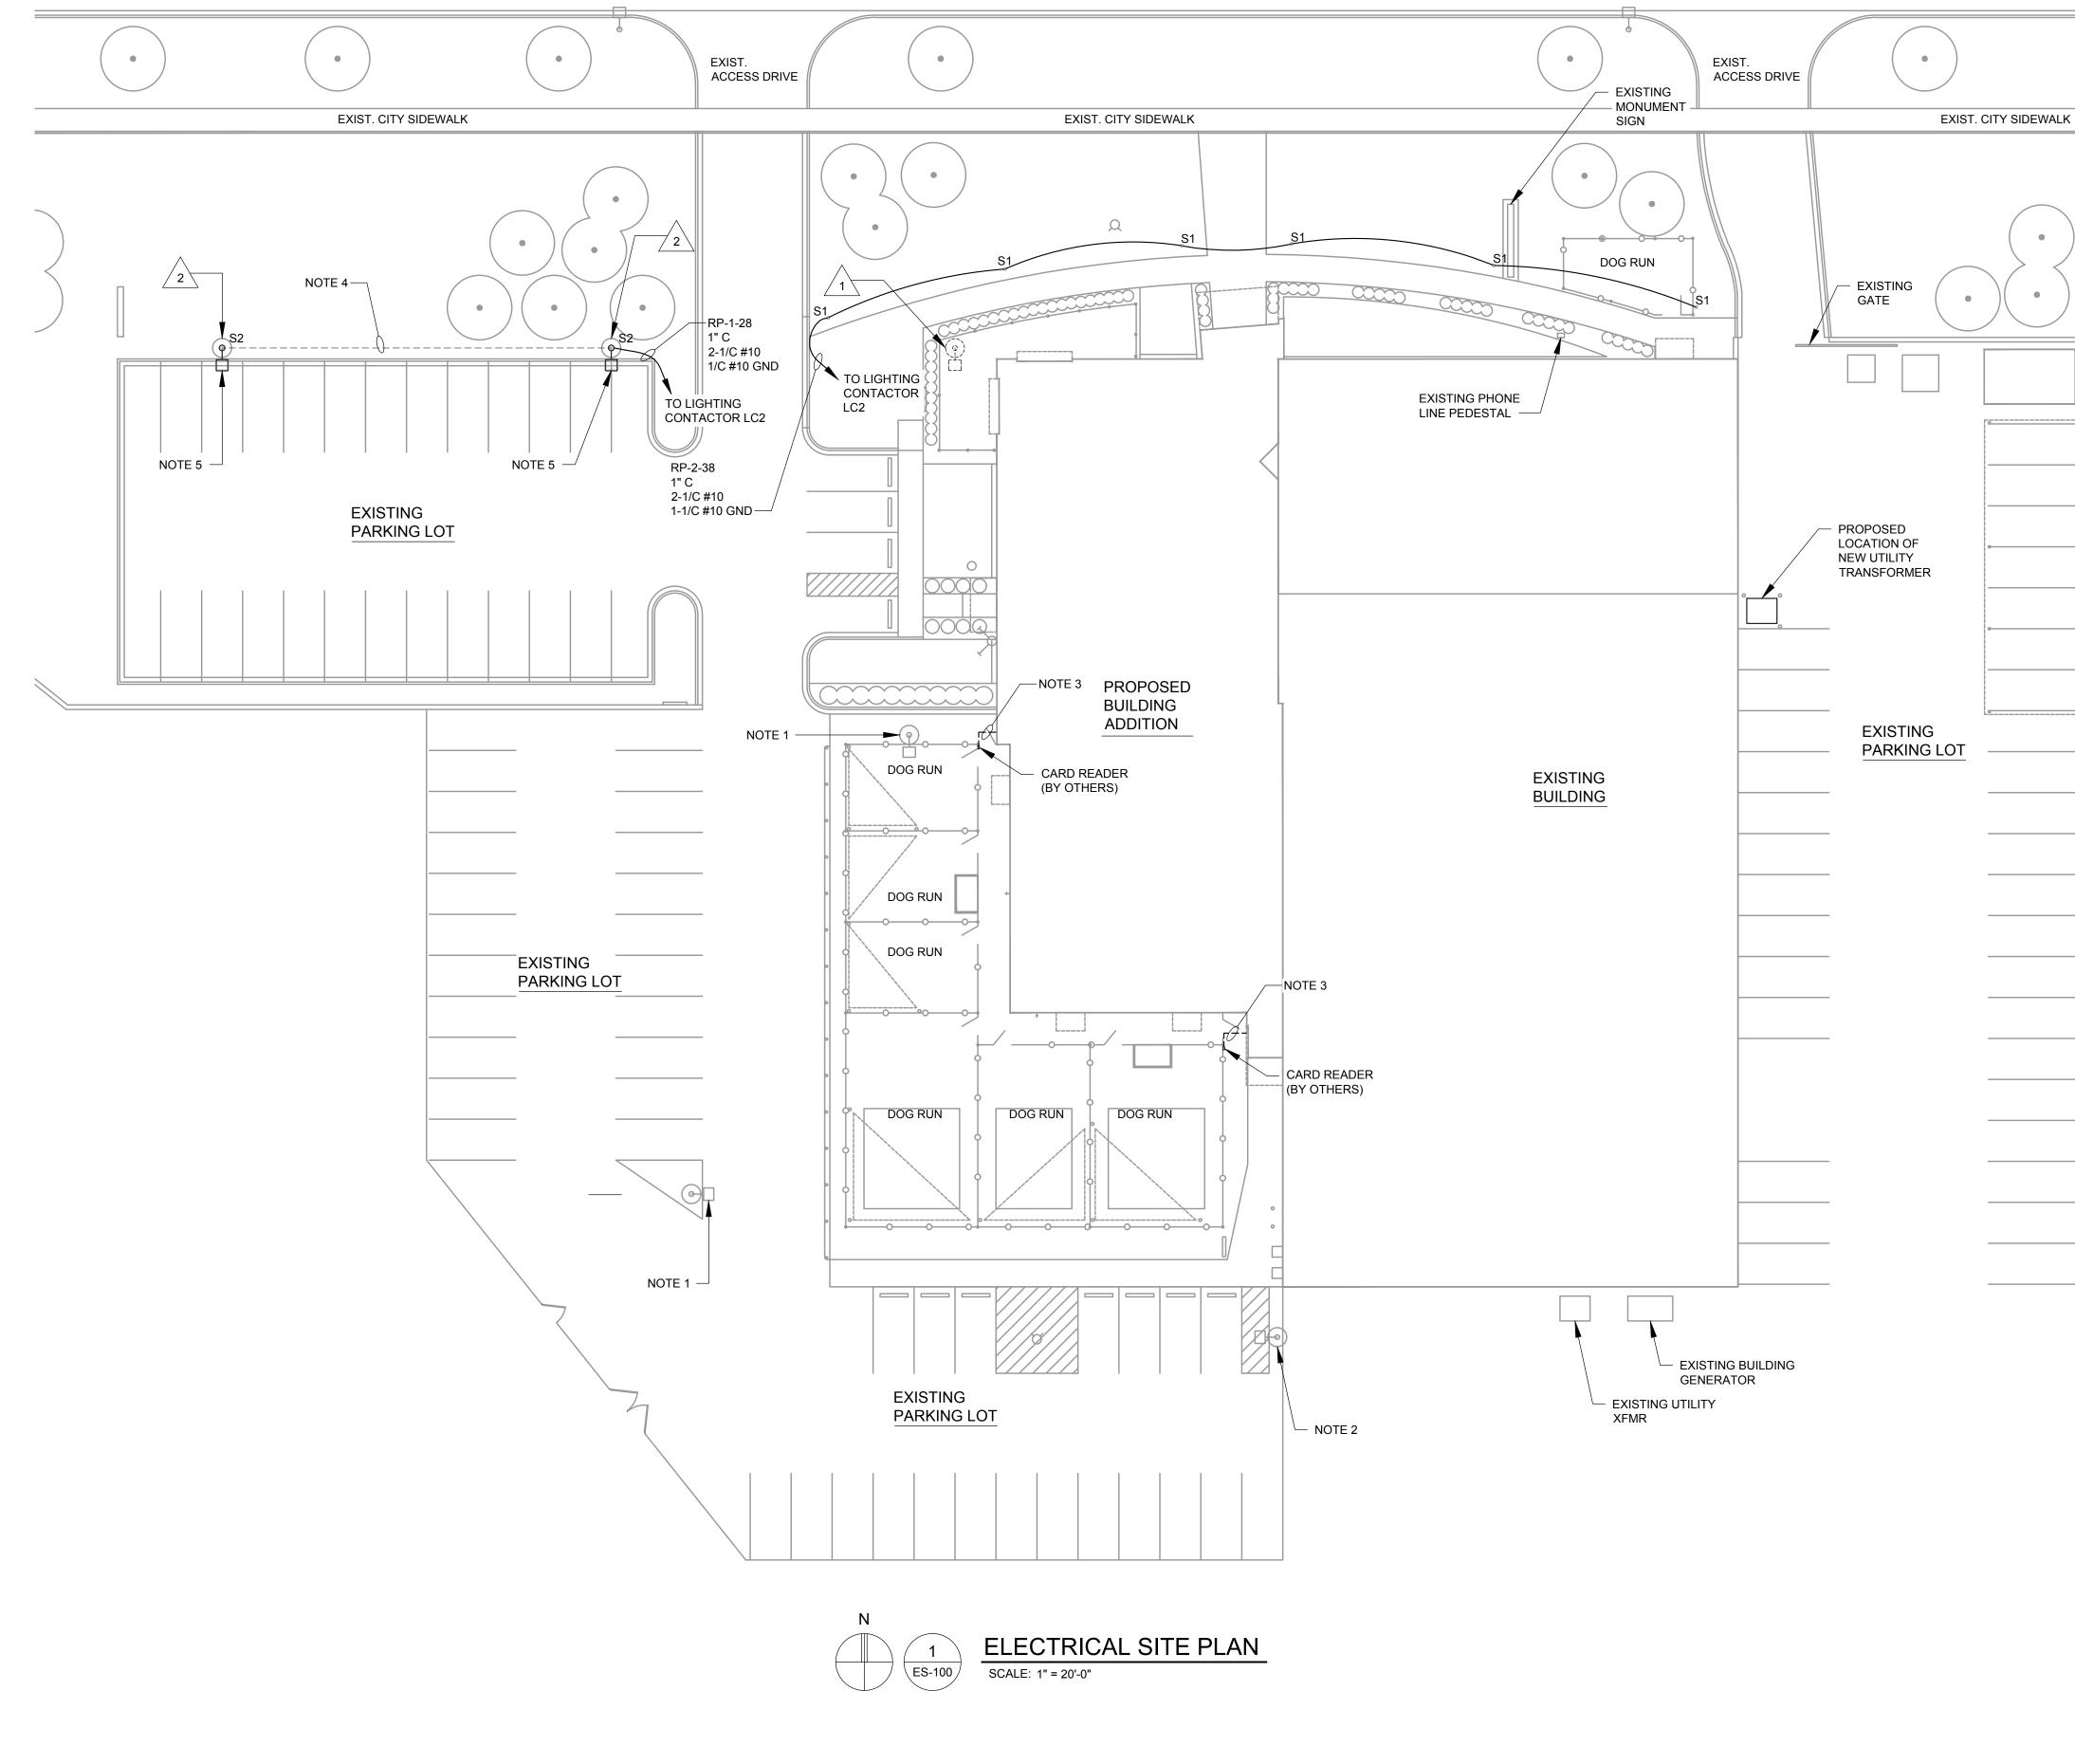GENERAL NOTES

- A. REFER TO ELECTRICAL SPECIFICATIONS FOR ADDITIONAL INFORMATION.
- B. REFER TO FIXTURE SCHEDULE ON DRAWING EL-600 FOR ADDITIONAL INFORMATION.
- REFER TO ONE-LINE DIAGRAM ON EP-600 FOR ADDITIONAL C. INFORMATION.
- D. REFER TO PANEL SCHEDULES ON EP-601 FOR ADDITIONAL INFORMATION.
- E. REFER TO LIGHTING CONTACTOR LCI SCHEMATIC ON DRAWING EL-601 FOR ADDITIONAL INFORMATION.

DEMOLITION NOTES:

DISCONNECT AND REMOVE EXISTING LIGHT FIXTURE, INCLUDING ASSOCIATED CONDUIT AND WIRING BACK TO SOURCE AND MARK CIRCUIT BREAKER AS SPARE.

DISCONNECT AND REMOVE EXISTING SITE LIGHT POLE MOUNTED FIXTURE AND POLE. EXISTING WIRING AND POLE BASE TO REMAIN. A NEW LIGHT POLE AND FIXTURE ARE TO BE INSTALLED UNDER THIS CONTRACT.

NOTES

/ 1


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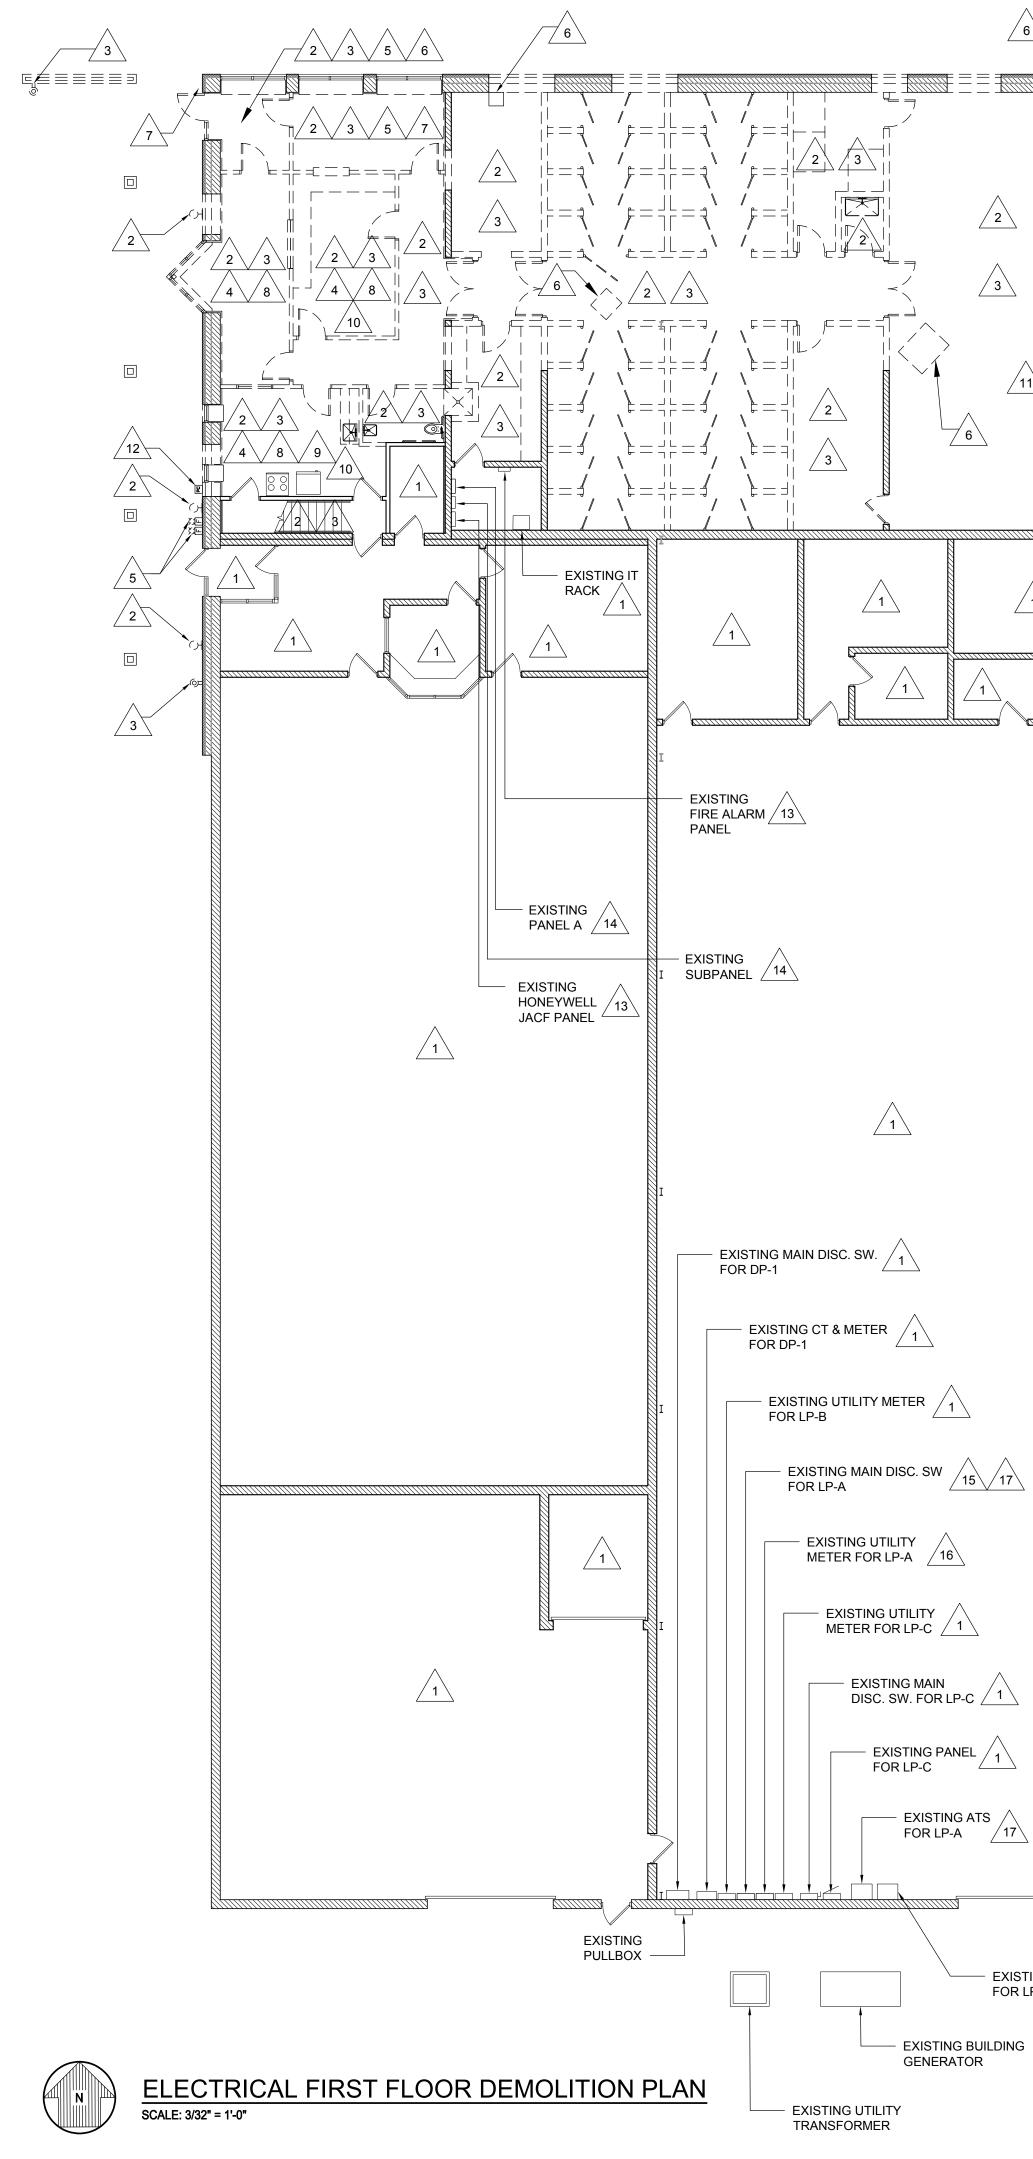
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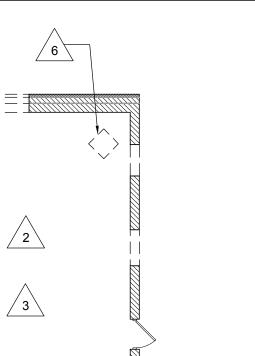
1. EXISTING LIGHT POLE AND FIXTURE TO REMAIN.

- 2. CONTRACTOR SHALL ROTATE EXISTING LIGHT FIXTURE ON POLE 180 DEGREES. FINAL DIRECTION OF EXISTING LIGHT FIXTURE SHALL BE POINTING WEST.
- 3. FURNISH AND INSTALL 3/4" EMPTY CONDUIT WITH PULLSTRING FROM BUILDING TO CARD READER. CABLING SHALL BE FURNISHED AND INSTALLED BY OTHERS. COORDINATE FINAL REQUIREMENTS WITH SECURITY SYSTEM INSTALLATION CONTRACTORS PRIOR TO INSTALLATION.
- 4. EXISTING CONDUIT AND CABLING TO REMAIN.
- FURNISH AND INSTALL NEW LIGHT FIXTURE AND POLE ON EXISTING 5. LIGHT POLE BASE SAVED FOR REUSE DURING DEMOLITION. RECONNECT EXISTING CIRCUIT WIRING SAVED FOR REUSE DURING DEMOLITION. CONTRACTOR SHALL FURNISH AND INSTALL NEW WIRING AS REQUIRED TO EXTEND EXISTING CIRCUIT WIRING TO LOCATION OF NEW LIGHT FIXTURE ON POLE.

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ARCHITECTS • ENGINEERS • Corporate Headqua 45650 Grand River Novi, Michigan 48 Ph: (248)349-4500 • Fax: (2 Novi • Wyandotte • Mu Lansing • Gaylord • Sault Williamsport, PA • Tar www.sidockgroup.co	Ave. 374 48)349-1429 Iskegon Ste. Marie npa, FL
TAYLO MADE FOR Y	R
^{Client:} City of Taylor 23555 Goddard I Taylor, MI 48180	
Project: City of Taylor Animal Shelter Remodel & Expa	nsion
25555 Northline Rd. Taylor, MI 48180	
Seal:	MACHIER * N4 000
12-21-2023 OW	Issued For ETE REVIEW NER REVIEW RMIT REVIEW
Drawn: Checked: Approved:	JDM LMR SRK
Sheet Title: ELECTRICAL SITE PLAN	
	2712.A
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GENERAL NOTES:

- A. REFER TO ELECTRICAL SPECIFICATIONS FOR ADDITIONAL INFORMATION.
- B. REFER TO ARCHITECTURAL AND MECHANICAL DRAWINGS FOR GENERAL SCOPE OF DEMOLITION WORK REQUIRED UNDER THIS CONTRACT. CONTRACT AND COORDINATE WITH ELECTRICAL DEMOLITION WORK.
- C. EXTREME CARE SHALL BE TAKEN NOT TO DISRUPT ANY ELECTRICAL SERVICES THAT EXTEND BEYOND THE BOUNDARIES OF THE RENOVATION AREA AND ARE TO REMAIN DURING DEMOLITION. POWER TO EQUIPMENT OUTSIDE OF AREA OF RENOVATION SHALL NOT BE TURNED OFF WITHOUT PROPER PERMISSION FROM OWNER'S REPRESENTATIVE. ANY CIRCUITS AFFECTED BY THE RENOVATION WHICH ARE SCHEDULED TO REMAIN SHALL BE PROPERLY REWIRED TO MAINTAIN SERVICE AND COMPLIANCE WITH NATIONAL, STATE, AND LOCAL CODES.
- D. DRAWINGS ARE DIAGRAMMATIC ONLY AND INDICATE GENERAL ARRANGEMENT OF ELECTRICAL DEMOLITION WORK TO BE PERFORMED. LOCATIONS ARE APPROXIMATE. EXACT EXTENT OF DEMOLITION WORK SHALL BE AS REQUIRED BY NEW WORK TO BE PERFORMED.
- E. TEST AND VERIFY INTEGRITY OF ALL CIRCUITS REQUIRING DISCONNECTION OR MODIFICATION. UN-TERMINATE CONDUCTORS AT EACH END AND PERFORM MEGGER TEST. RE-TERMINATE AND VERIFY PROPER PHASE SEQUENCE/ROTATION. VERIFY GROUND CONNECTIONS.
- F. REFER TO EXISTING RISER DIAGRAM ON ED-600 FOR ADDITIONAL INFORMATION.

DEMOLITION KEYED NOTES:

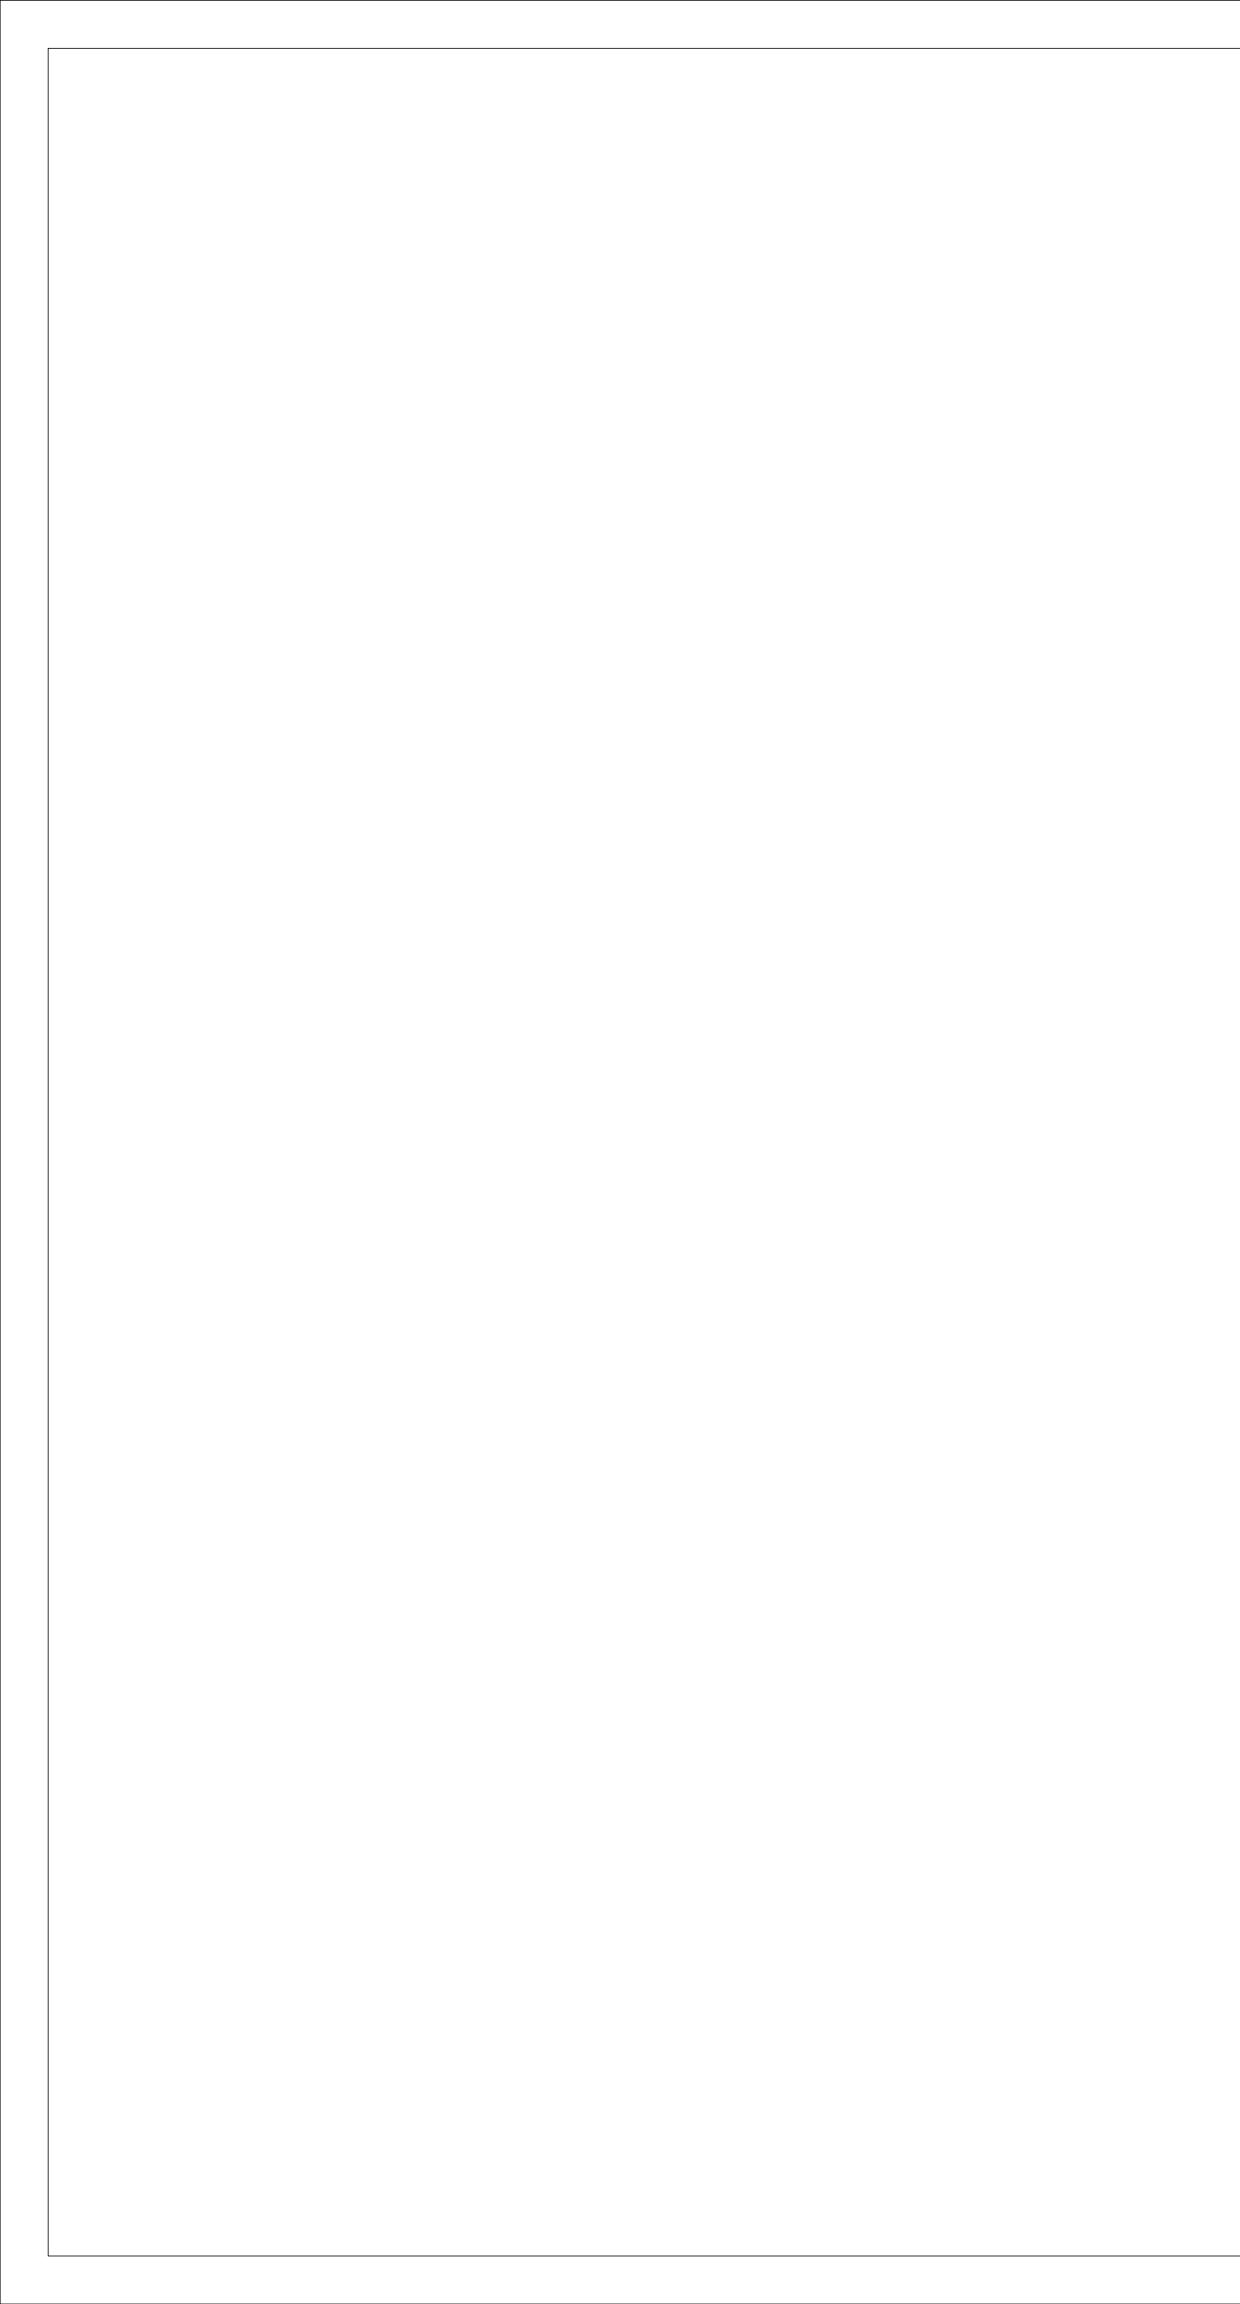EXISTING ELECTRICAL EQUIPMENT TO REMAIN UNLESS /1 OTHERWISE NOTED.

- DISCONNECT AND REMOVE EXISTING LIGHT FIXTURES AND LIGHTING CONTROL DEVICES, INCLUDING ASSOCIATED CONDUIT AND WIRING BACK TO SOURCE AND MARK CIRCUIT BREAKER AS SPARE.
- DISCONNECT AND REMOVE EXISTING RECEPTACLE OUTLETS, INCLUDING ASSOCIATED CONDUIT AND WIRING BACK TO SOURCE / 3 AND MARK CIRCUIT BREAKER POSITION AS SPARE.
- DISCONNECT AND REMOVE EXISTING DATA OUTLETS, INCLUDING / 4 \setminus ALL ASSOCIATED CONDUIT AND WIRING BACK TO SOURCE.
- DISCONNECT AND REMOVE EXISTING FIRE ALARM DEVICES, INCLUDING ALL ASSOCIATED CONDUIT AND WIRING BACK TO / 5 \ ¹ SOURCE.

DISCONNECT AND REMOVE EXISTING ELECTRICAL EQUIPMENT TO MECHANICAL UNIT, INCLUDING ASSOCIATED CONDUIT AND 6 WIRING BACK TO SOURCE AND MARK CIRCUIT BREAKER POSITION AS SPARE.

- DISCONNECT AND REMOVE EXISTING SECURITY EQUIPMENT, /7 INCLUDING ASSOCIATED CONDUIT AND WIRING BACK TO SOURCE.
- DISCONNECT AND REMOVE EXISTING SPEAKER EQUIPMENT, 8 INCLUDING ASSOCIATED CONDUIT AND WIRING BACK TO SOURCE.
- DISCONNECT AND REMOVE EXISTING TIME CARD SYSTEM INCLUDING ASSOCIATED CONDUIT AND WIRING BACK TO SOURCE AND MARK CIRCUIT BREAKER AS SPARE.
- DISCONNECT AND REMOVE EXISTING WIFI EQUIPMENT INCLUDING ASSOCIATED CONDUIT AND WIRING BACK TO SOURCE. /10 EQUIPMENT SHALL BE TURNED OVER TO OWNER.
- DISCONNECT AND REMOVE EXISTING ELECTRICAL EQUIPMENT TO EXISTING OVERHEAD DOOR, INCLUDING, ASSOCIATED CONDUIT /11 AND WIRING BACK TO SOURCE AND MARK CIRCUIT BREAKER AS SPARE.
- DISCONNECT AND REMOVE EXISTING PHOTOCELL, INCLUDING /12 ASSOCIATED CONDUIT AND WIRING BACK TO SOURCE.
- DISCONNECT AND REMOVE EXISTING SERVICE FEED TO PANEL, INCLUDING ALL ASSOCIATED CONDUIT BACK TO SOURCE AND /13 MARK CIRCUIT BREAKER AS SPARE. EXISTING PANEL TO BE RE-FED UNDER THE CONTRACT.
- DISCONNECT AND REMOVE EXISTING PANEL, INCLUDING ASSOCIATED CONDUIT AND WIRING BACK TO SOURCE.
- DISCONNECT AND REMOVE EXISTING DISCONNECT SWITCH,
- / 15 INCLUDING ASSOCIATED CONDUIT AND WIRING BACK TO SOURCE.
- /16 DISCONNECT AND REMOVE EXISTING UTILITY METER.
- DISCONNECT AND REMOVE EXISTING BRANCH FEEDER WIRING AND CONDUIT BETWEEN EXISTING ATS AND MAIN DISCONNECT /17 SWITCH FOR PANEL LP-A. BRANCH FEED TO BE REPLACED UNDER THIS CONTRACT.

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Client: City of Taylor 23555 Goddard Rd. Taylor, MI 48180
Project: City of Taylor Animal Shelter Remodel & Expansion
25555 Northline Rd. Taylor, MI 48180 Seal:
Date Issued For 10-18-2023 50% COMPLETE REVIEW 12-21-2023 OWNER REVIEW 01-17-2024 PERMIT REVIEW

Sidock Group

ARCHITECTS • ENGINEERS • CONSULTANTS

Checked:	LMR
Approved:	SRK

JDM

Sheet Title:

Drawn

ELECTRIC FIRST FLC DEMOLITI	DOR
Project Number:	22712.A

Sheet Number: ED-110

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EXISTING ATS FOR LP-C




- A. REFER TO ELECTRICAL SPECIFICATIONS FOR ADDITIONAL INFORMATION.
- B. REFER TO ARCHITECTURAL AND MECHANICAL DRAWINGS FOR GENERAL SCOPE OF DEMOLITION WORK REQUIRED UNDER THIS CONTRACT. CONTRACT AND COORDINATE WITH ELECTRICAL DEMOLITION WORK.
- C. EXTREME CARE SHALL BE TAKEN NOT TO DISRUPT ANY ELECTRICAL SERVICES THAT EXTEND BEYOND THE BOUNDARIES OF THE RENOVATION AREA AND ARE TO REMAIN DURING DEMOLITION. POWER TO EQUIPMENT OUTSIDE OF AREA OF RENOVATION SHALL NOT BE TURNED OFF WITHOUT PROPER PERMISSION FROM OWNER'S REPRESENTATIVE. ANY CIRCUITS AFFECTED BY THE RENOVATION WHICH ARE SCHEDULED TO REMAIN SHALL BE PROPERLY REWIRED TO MAINTAIN SERVICE AND COMPLIANCE WITH NATIONAL, STATE, AND LOCAL CODES.
- D. DRAWINGS ARE DIAGRAMMATIC ONLY AND INDICATE GENERAL ARRANGEMENT OF ELECTRICAL DEMOLITION WORK TO BE PERFORMED. LOCATIONS ARE APPROXIMATE. EXACT EXTENT OF DEMOLITION WORK SHALL BE AS REQUIRED BY NEW WORK TO BE PERFORMED.
- E. TEST AND VERIFY INTEGRITY OF ALL CIRCUITS REQUIRING DISCONNECTION OR MODIFICATION. UN-TERMINATE CONDUCTORS AT EACH END AND PERFORM MEGGER TEST. RE-TERMINATE AND VERIFY PROPER PHASE SEQUENCE/ROTATION. VERIFY GROUND CONNECTIONS.
- F. REFER TO EXISTING RISER DIAGRAM ON ED-600 FOR ADDITIONAL INFORMATION.


DEMOLITION KEYED NOTES:



EXISTING ELECTRICAL EQUIPMENT ASSOCIATED WITH UNIT 1 TO REMAIN.

DISCONNECT AND REMOVE EXISTING ELECTRICAL EQUIPMENT ASSOCIATED WITH UNIT, INCLUDING ALL

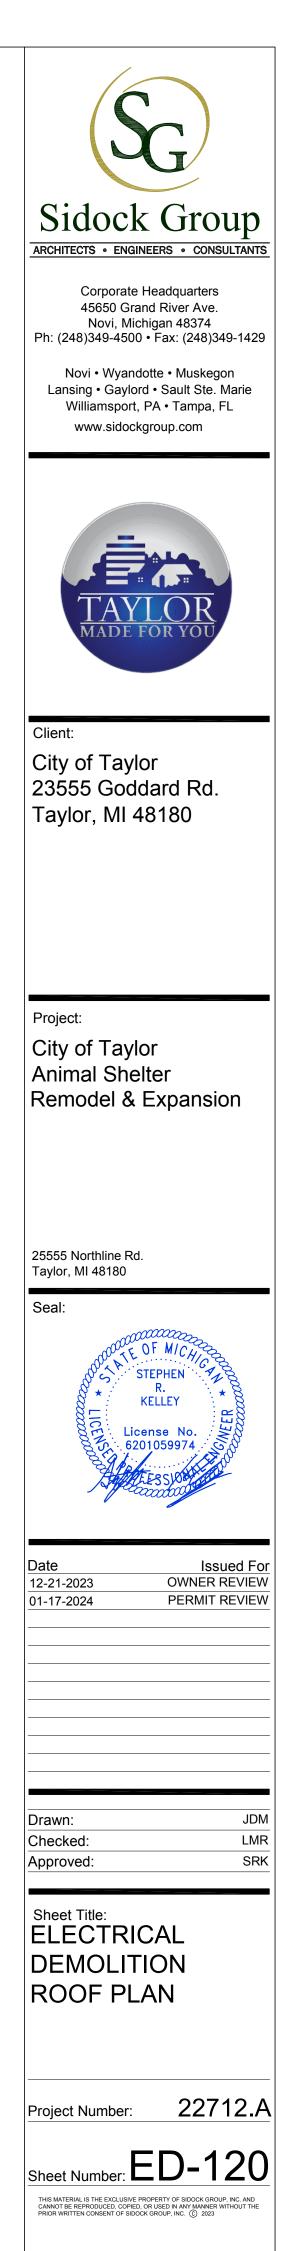

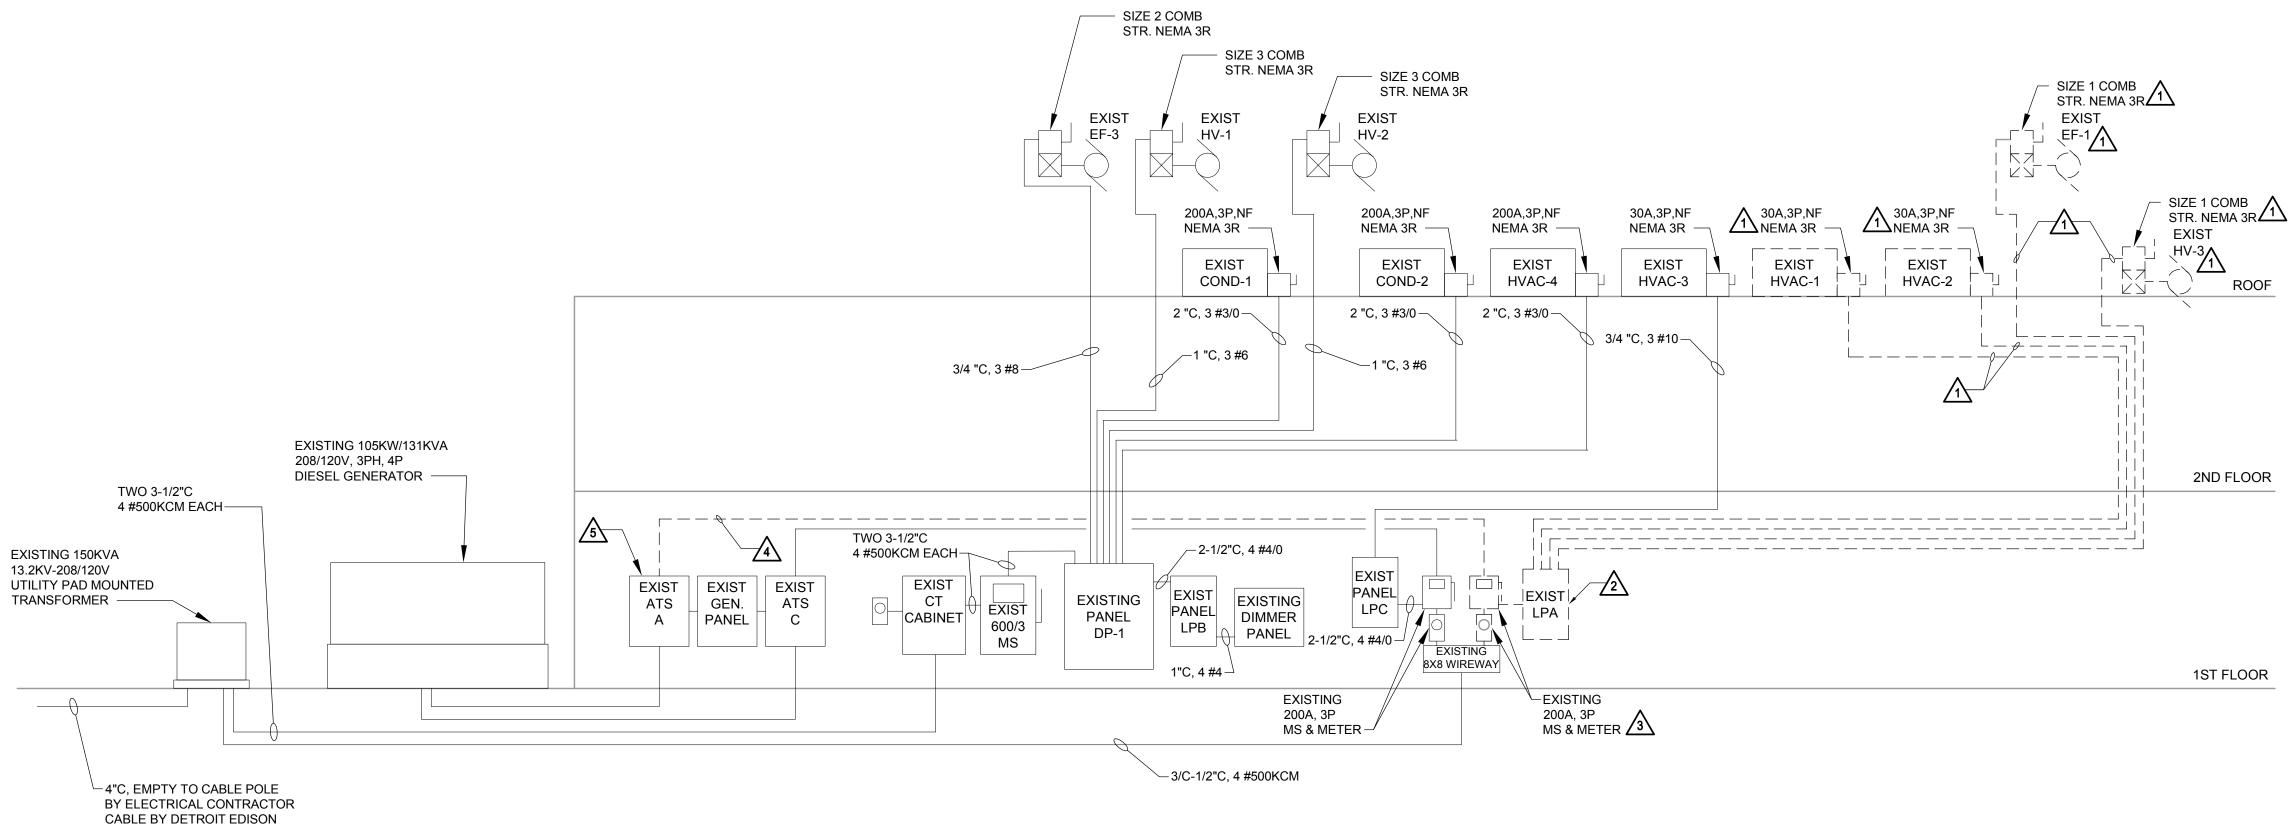

ELECTRICAL DEMOLITION RISER DIAGRAM

SCALE: NTS NOTE 1

GENERAL NOTES


- A. REFER TO ELECTRICAL SPECIFICATIONS FOR ADDITIONAL INFORMATION.
- B. REFER TO ARCHITECTURAL DRAWINGS FOR GENERAL SCOPE OF DEMOLITION WORK REQUIRED UNDER THIS CONTRACT AND COORDINATE WITH ELECTRICAL DEMOLITION WORK.
- C. EXTREME CARE SHALL BE TAKEN NOT TO DISRUPT ANY ELECTRICAL SERVICES WHICH EXTEND BEYOND THE BOUNDARIES OF WORK AREA AND ARE TO REMAIN DURING DEMOLITION. POWER TO EQUIPMENT OUTSIDE OF AREA OF DEMOLITION SHALL NOT BE TURNED OFF WITHOUT PROPER PERMISSION FROM OWNER'S REPRESENTATIVE. ANY CIRCUITS AFFECTED BY THIS DEMOLITION, WHICH ARE SCHEDULED TO REMAIN SHALL BE PROPERLY REWIRED TO MAINTAIN SERVICE AND COMPLIANCE WITH ALL NATIONAL, STATE AND LOCAL CODES.


DEMOLITION NOTES

- DISCONNECT AND REMOVE EXISTING ELECTRICAL EQUIPMENT ASSOCIATED WITH UNIT, INCLUDING ALL ASSOCIATED CONDUIT AND WIRING BACK TO SOURCE.
- DISCONNECT AND REMOVE EXISTING SERVICE AND BRANCH 2 FEEDERS FROM EXISTING PANEL. EXISTING SERVICE FEEDER AND PANEL TO BE REPLACED UNDER THIS CONTRACT. BRANCH FEEDERS THAT ARE TO REMAIN SHALL BE RE-FED FROM NEW PANEL. REFER TO DRAWINGS EP-600 AND EP-601 FOR ADDITIONAL INFORMATION.
- DISCONNECT AND REMOVE EXISTING UTILITY METER AND SERVICE DISCONNECT AND REMOVE EXISTING UTILITY WE FER AND GENARD DISCONNECT SWITCH, INCLUDING ALL ASSOCIATED CONDUIT AND WIRING BACK TO SOURCE.
- DISCONNECT AND REMOVE EXISTING CONDUIT AND WIRING BETWEEN SERVICE DISCONNECT SWITCH AND AUTOMATIC TRANSFER SWITCH.
- ABANDON IN PLACE.

NOTES


1. THE BUILDING RENOVATIONS AND ADDITION TO THE CITY OF TAYLOR ANIMAL SHELTER SHALL BE FED FROM A NEW UTILITY SERVICE TRANSFORMER. REFER TO DRAWING EP-600 FOR ADDITIONAL INFORMATION.

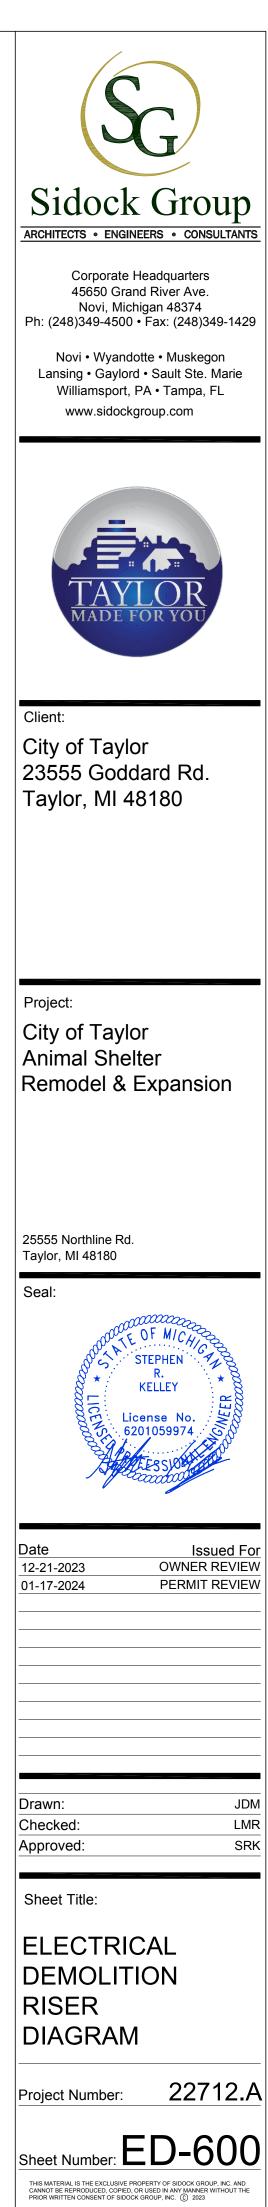

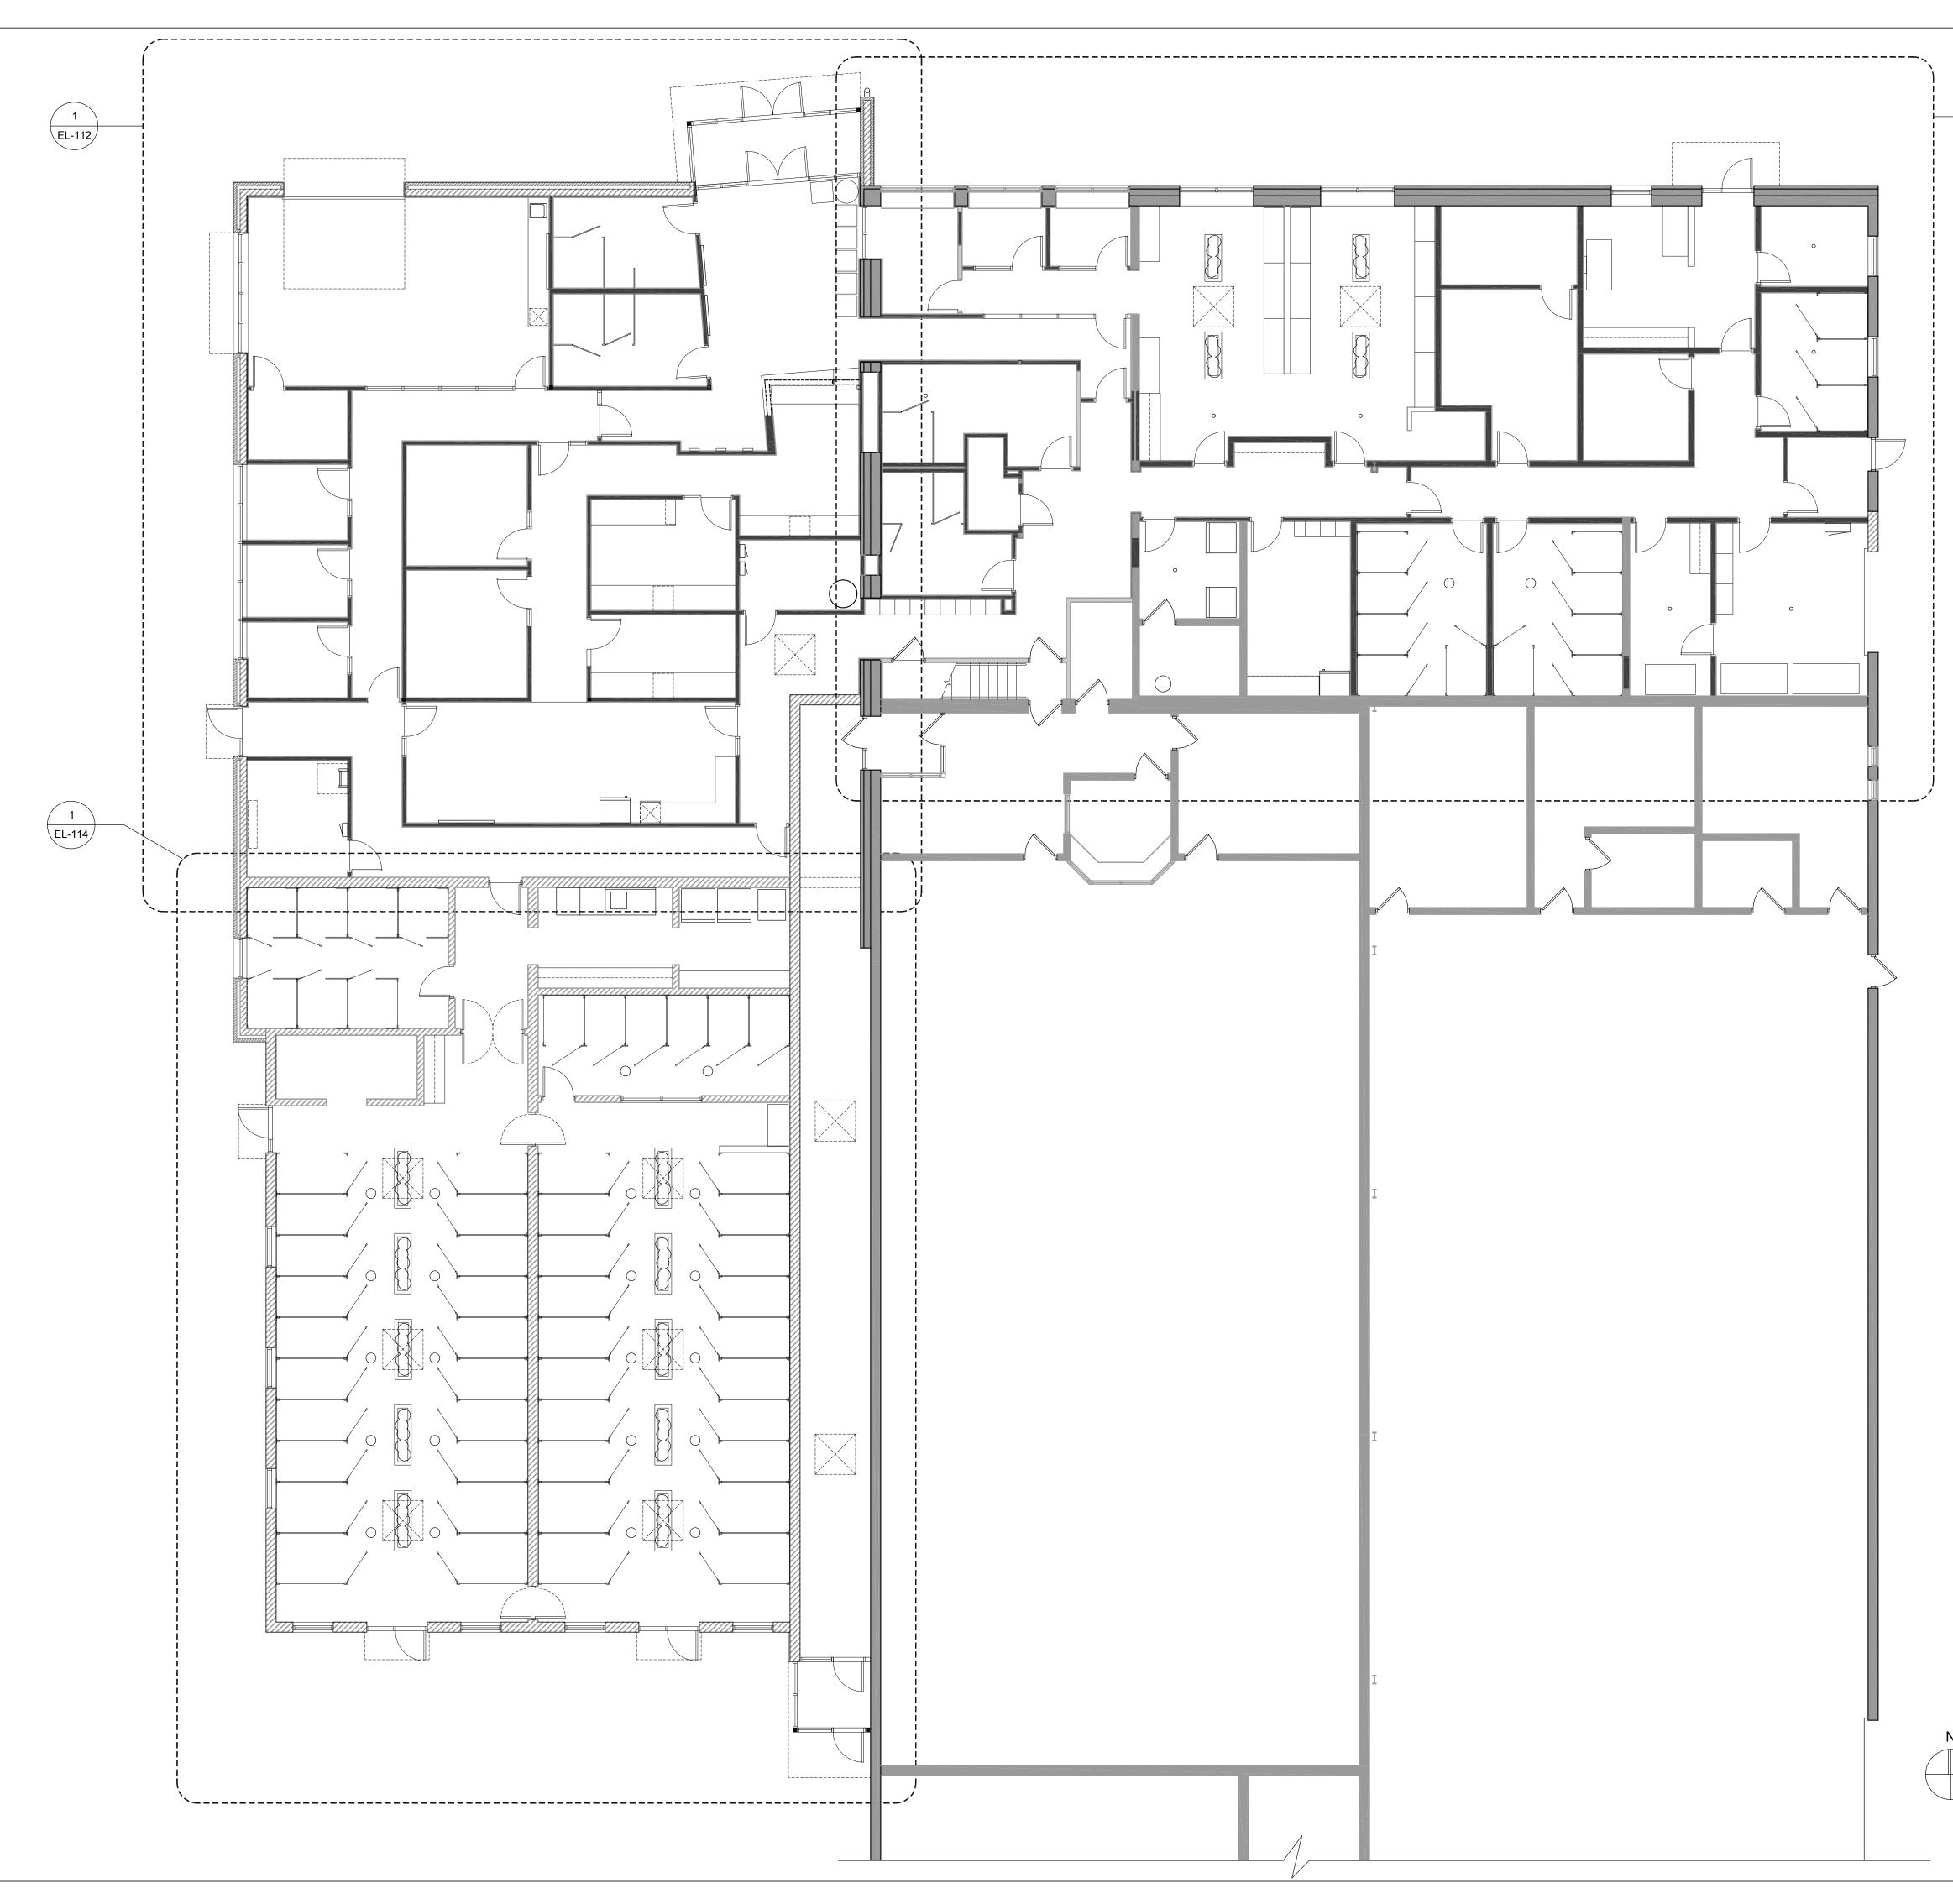




GENERAL NOTES A. REFER TO ELECTRICAL SPECIFICATIONS FOR ADDITIONAL INFORMATION.

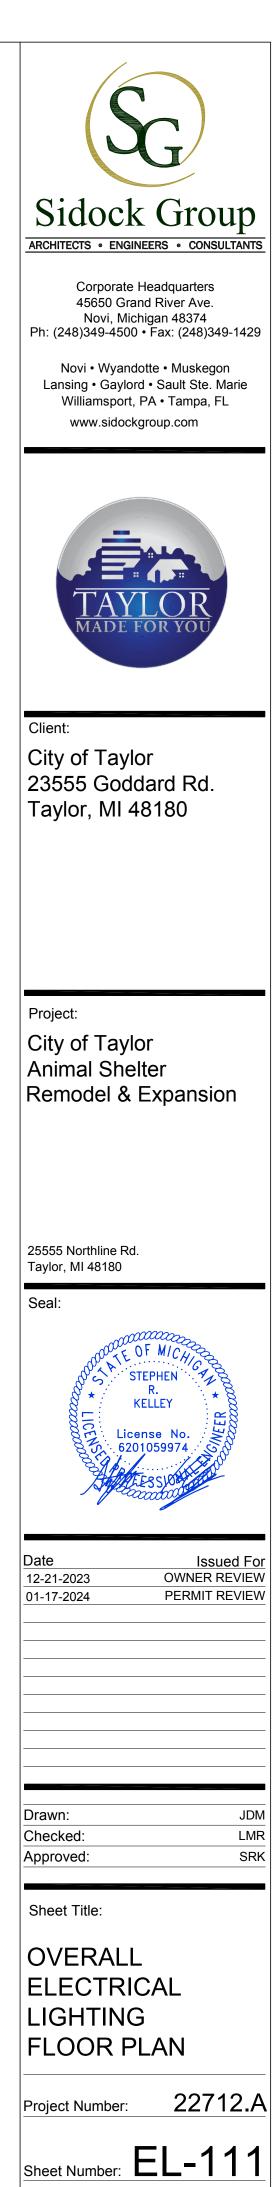

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	EL-111

OVERALL ELECTRICAL LIGHTING FLOOR PLAN SCALE: 1/8" = 1'-0"

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SCALE: 1/4" = 1'-0"

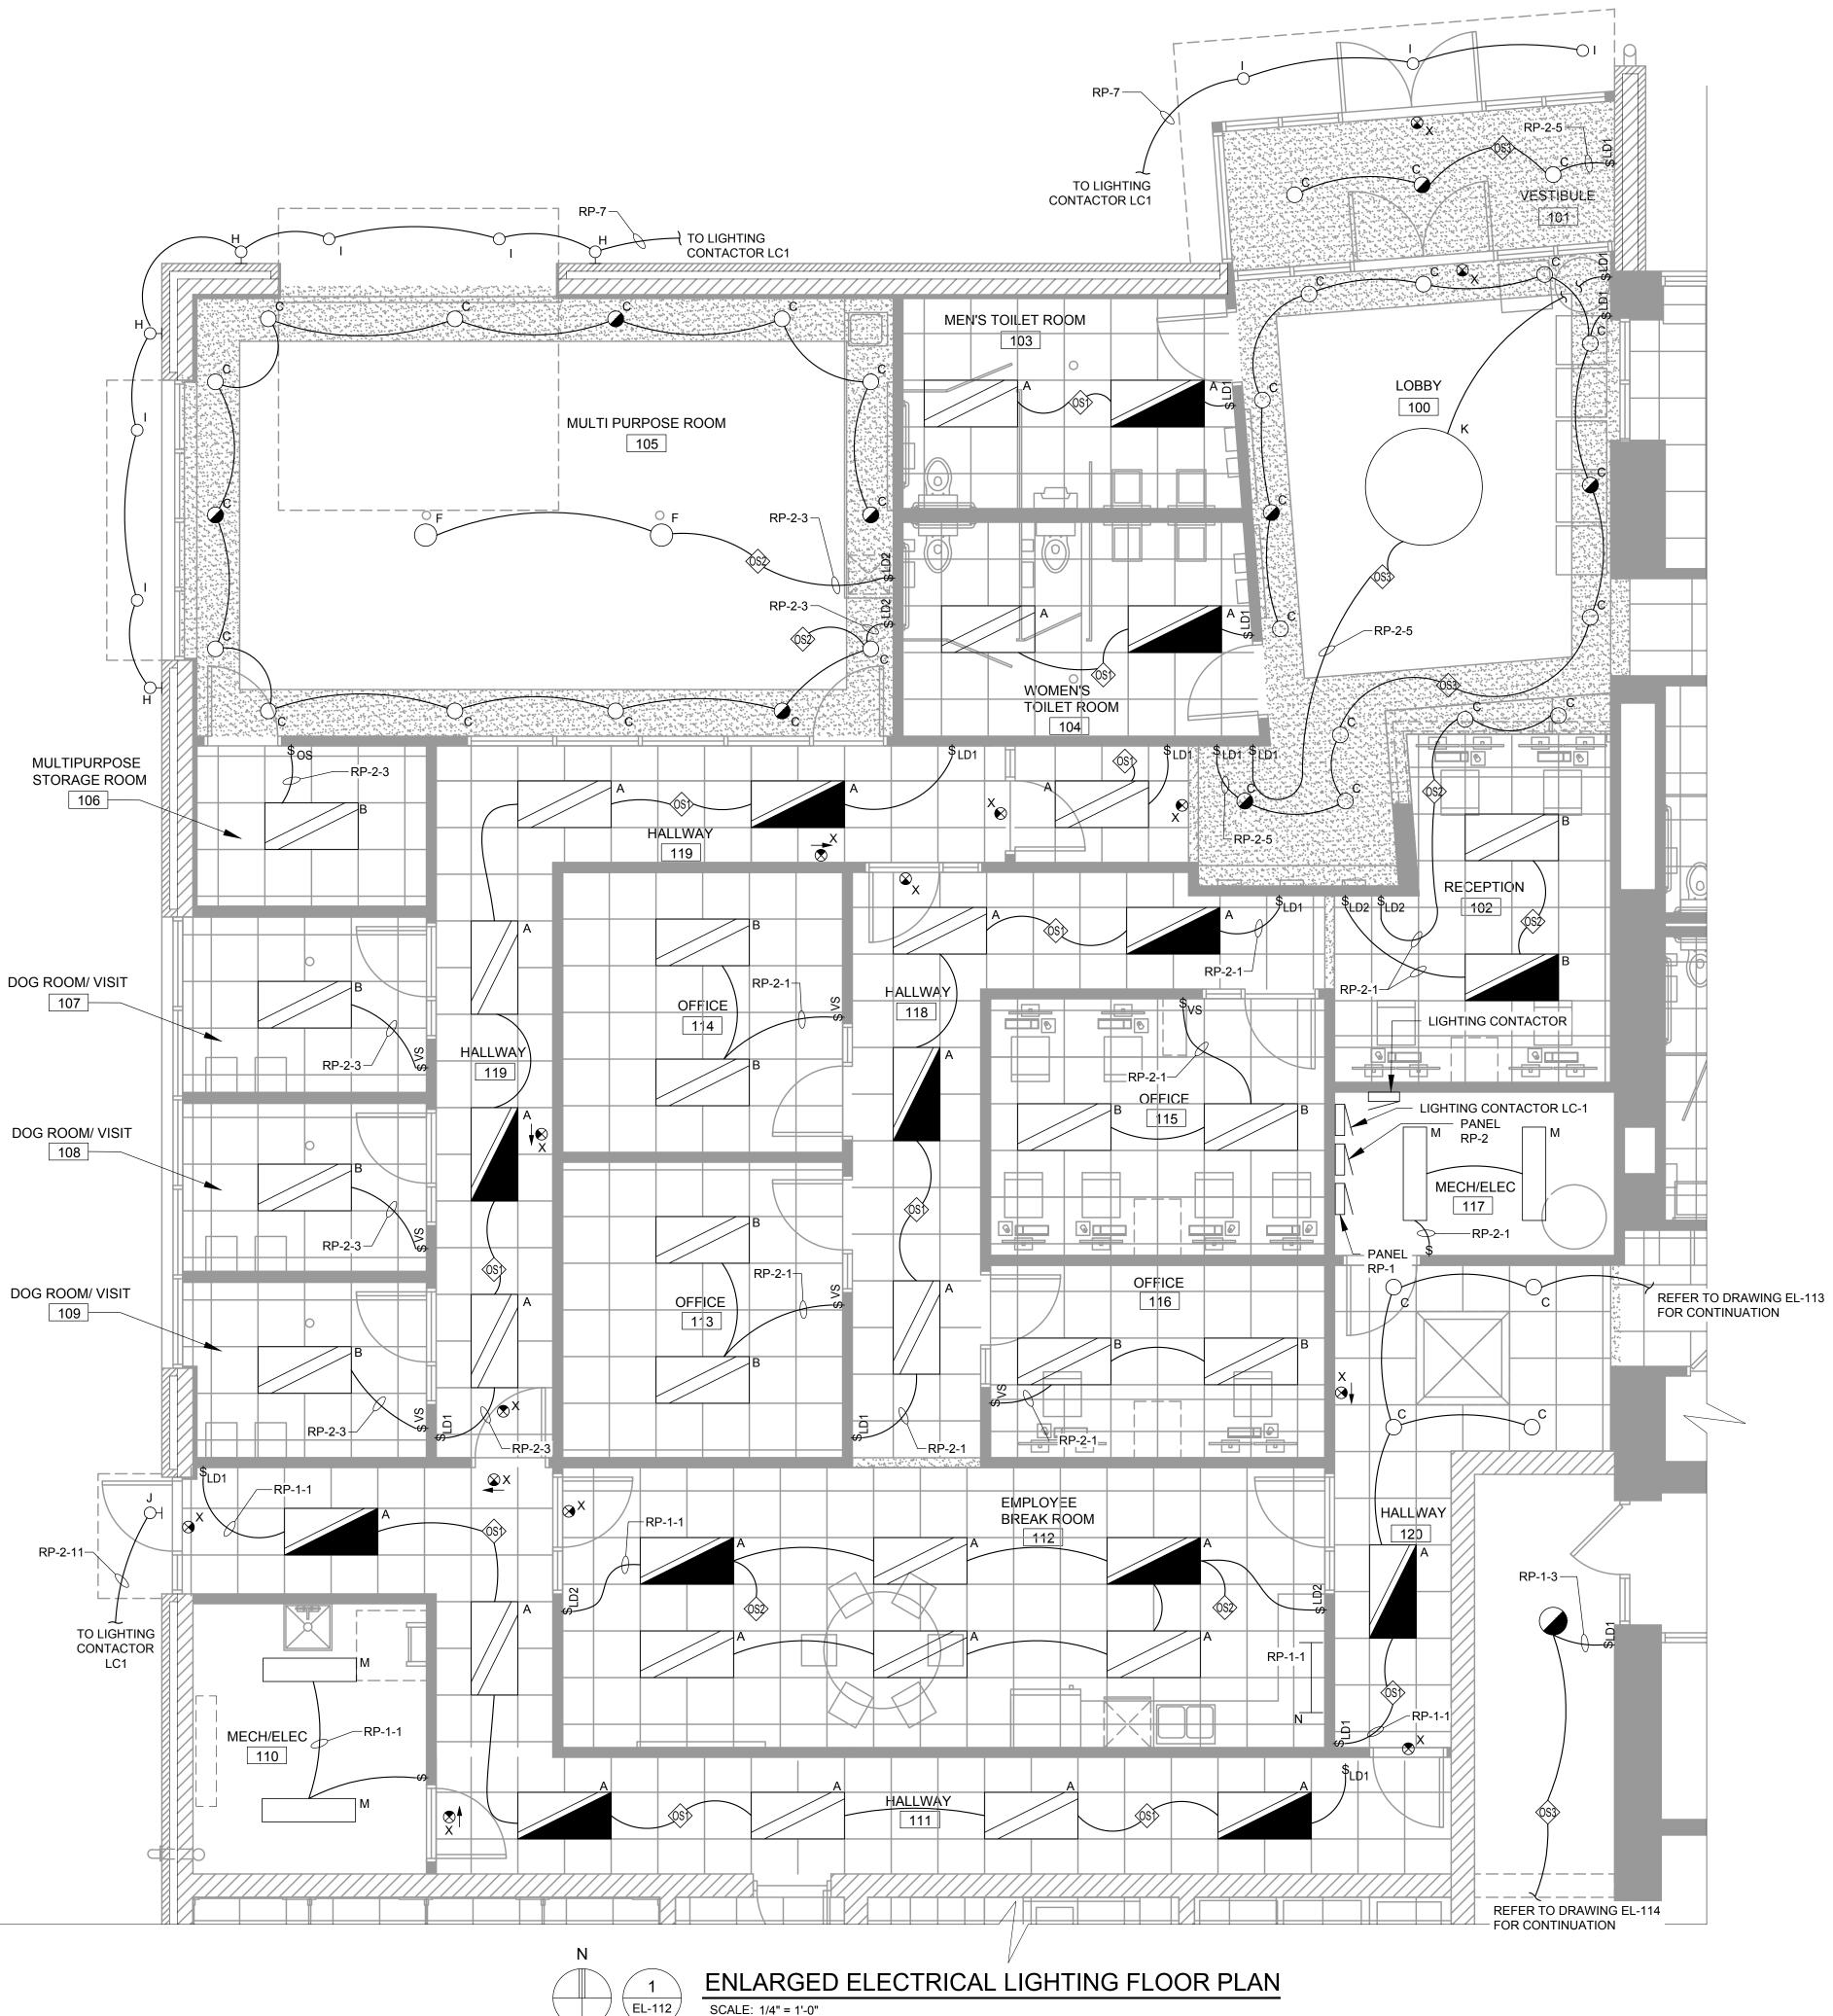GENERAL NOTES

- A. REFER TO ELECTRICAL SPECIFICATIONS FOR ADDITIONAL INFORMATION.
- B. DRAWINGS ARE DIAGRAMMATIC ONLY AND INDICATE GENERAL ARRANGEMENT OF ELECTRICAL WORK. LOCATIONS ARE APPROXIMATE AND SUBJECT TO MINOR MODIFICATIONS BY THE OWNER/ENGINEER.
- C. COORDINATE EXACT LOCATION OF DEVICES WITH OTHER TRADES FOR AVOIDANCE OF ANY OBSTRUCTIONS. VERIFY WALL SWITCHING OF ELECTRICAL LIGHTING PLANS FOR PROPER TYPES OF OPTIONS REQUIRED ON ALL FIXTURES. VERIFY CEILING TYPES ON ARCHITECTURAL REFLECTED CEILING PLANS FOR PROPER INSTALLATIONS OF TRIMS AND FOR EXACT MOUNTING LOCATIONS ON ALL FIXTURES.
- D. USE #12 CONDUCTORS FOR 20A CIRCUIT HOME RUNS IF BRANCH CIRCUIT RUN IS LESS THAN 100 FEET FOR 120 VOLT. USE #10 CONDUCTORS IF BRANCH CIRCUIT RUN EXCEEDS 100 FEET FOR 120 VOLT.
- E. LIGHTING FIXTURE MANUFACTURER AND MODEL SERIES SHOWN IN LIGHTING FIXTURE SCHEDULE AND ON PLAN ARE BASIS OF DESIGN. ALTERNATE MANUFACTURER AND EQUIPMENT LISTED THAT MEETS THE SALIENT CHARACTERISTICS OF THE LIGHTING FIXTURES LISTED ARE ACCEPTABLE. THE ENGINEER RESERVES THE RIGHT FOR THE MANUFACTURER OR MANUFACTURERS REPRESENTATIVE TO PROVIDE PROOF THAT THE SELECTED EQUIPMENT MEETS ALL FUNCTIONS, PLANS, AND SPECIFICATIONS ARE MET OR EXCEEDED. ALL "OR EQUALS" ARE SUBJECT TO APPROVAL BY ARCHITECT-ENGINEER.
- F. LIGHTING CONTROL SYSTEM MANUFACTURER IS BASIS OF DESIGN. ALTERNATE MANUFACTURER AND EQUIPMENT LISTED THAT MEETS THE SALIENT CHARACTERISTICS OF THE LIGHTING CONTROL DEVICES LISTED ARE ACCEPTABLE. THE ENGINEER RESERVES THE RIGHT FOR THE MANUFACTURER OR MANUFACTURERS REPRESENTATIVE TO PROVIDE PROOF THAT THE SELECTED EQUIPMENT MEETS ALL FUNCTIONS, PLANS, AND SPECIFICATIONS ARE MET OR EXCEEDED. ALL "OR EQUALS" ARE SUBJECT TO APPROVAL BY ARCHITECT-ENGINEER.
- G. LIGHTING CONTROL AND SENSORS SHOWN ON DRAWINGS ARE INDICATED TO DEMONSTRATE DESIGN INTENT. ACTUAL NUMBERS AND LOCATIONS OF DEVICES SHALL BE AS RECOMMENDED BY THE LIGHTING CONTROL MANUFACTURER/SUPPLIER. CONTRACTOR SHALL FURNISH AND INSTALL POWER PACKS, AUXILIARY RELAYS, LOW VOLTAGE TRANSFORMERS, TRANSFORMER DEVICES, ETC. AS REQUIRED AND RECOMMENDED BY THE LIGHTING CONTROL SYSTEM MANUFACTURER/SUPPLIER.
- H. LETTER NEXT TO LIGHTING FIXTURE INDICATE FIXTURE TYPE. REFER TO FIXTURE SCHEDULE ON DRAWING EL-600 FOR ADDITIONAL INFORMATION.
- REFER TO PANEL SCHEDULE ON DRAWING EP-601 FOR ADDITIONAL INFORMATION.
- J. EMERGENCY AND EXIT LIGHTING FIXTURES TO BE INSTALLED UNDER THIS CONTRACT SHALL BE FED FROM THE SAME CIRCUIT AS NORMAL LIGHTING IN SPACE AND SHALL BE CONNECTED AHEAD OF THE SWITCH.

NOTES

- 1. FURNISH AND INSTALL WALL MOUNTED OCCUPANCY SENSOR, SENSOR SWITCH MODEL WSX PDT WH OR EQUIVALENT.
- 2. FURNISH AND INSTALL WALL MOUNTED DIMMING VACANCY SENSOR, ACUITY "SENSOR SWITCH" MODEL WSX PDT D VA WH OR EQUIVALENT.
- 3. FURNISH AND INSTALL WALL MOUNTED ON/OFF SWITCH, NPODM WH OR EQUIVALENT.
- 4. FURNISH AND INSTALL CEILING MOUNTED OCCUPANCY SENSOR, SENSOR SWITCH MODEL CM PDT 10 OR EQUIVALENT.
- 5. FURNISH AND INSTALL WALL MOUNTED ON/OFF SWITCH WITH DIMMING, NLIGHT MODEL NPODM DX WH OR EQUIVALENT.
- 6. FURNISH AND INSTALL CEILING MOUNTED OCCUPANCY SENSOR CONTROL, NLIGHT MODEL NCM PDT 10 AR RJB OR EQUIVALENT.
- 7. FURNISH AND INSTALL CEILING MOUNTED OCCUPANCY SENSOR WITH DAYLIGHTING CONTROL, NLIGHT MODEL NCM PDT 10 ADCX AR RJB OR EQUIVALENT.

SYMBOLS

- \$_{O.S} WALL MOUNTED OCCUPANCY SENSOR REFER TO NOTE 1
- \$_{VS} WALL MOUNTED VACANCY SENSOR REFER TO NOTE 2
- \$ SINGLE POLE SWITCH
- \$_{LD1} WALL MOUNTED ON/OFF SWITCH REFER TO NOTE 3
- (S) CEILING MOUNTED OCCUPANCY SENSOR REFER TO NOTE 4
- $_{\rm ID2}$ WALL MOUNTED ON/OFF SWITCH WITH DIMMING REFER TO NOTE 5
- (S) CEILING MOUNTED OCCUPANCY SENSOR REFER TO NOTE 6
- (\$) CEILING MOUNTED OCCUPANCY SENSOR WITH PHOTOCELL REFER TO NOTE 7



City of Taylor 23555 Goddard Rd. Taylor, MI 48180

25555 Northline Rd. Taylor, MI 48180

Seal:

Project:

City of Taylor

Animal Shelter

Remodel & Expansion



Issued For 10-18-2023 50% COMPLETE REVIEW OWNER REVIEW 12-21-2023 PERMIT REVIEW 10-17-2024

Drawn: Checked: Approved:

Sheet Title:

ENLARGED ELECTRICAL

LIGHTING FLOOR PLAN

22712.A Project Number:


Sheet Number: EL-112

JDM

LMR

SRK

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- A. REFER TO ELECTRICAL SPECIFICATIONS FOR ADDITIONAL INFORMATION.
- B. DRAWINGS ARE DIAGRAMMATIC ONLY AND INDICATE GENERAL ARRANGEMENT OF ELECTRICAL WORK. LOCATIONS ARE APPROXIMATE AND SUBJECT TO MINOR MODIFICATIONS BY THE OWNER/ENGINEER.
- C. COORDINATE EXACT LOCATION OF DEVICES WITH OTHER TRADES FOR AVOIDANCE OF ANY OBSTRUCTIONS. VERIFY WALL SWITCHING OF ELECTRICAL LIGHTING PLANS FOR PROPER TYPES OF OPTIONS REQUIRED ON ALL FIXTURES. VERIFY CEILING TYPES ON ARCHITECTURAL REFLECTED CEILING PLANS FOR PROPER INSTALLATIONS OF TRIMS AND FOR EXACT MOUNTING LOCATIONS ON ALL FIXTURES.
- USE #12 CONDUCTORS FOR 20A CIRCUIT HOME RUNS IF D. BRANCH CIRCUIT RUN IS LESS THAN 100 FEET FOR 120 VOLT. USE #10 CONDUCTORS IF BRANCH CIRCUIT RUN EXCEEDS 100 FEET FOR 120 VOLT.
- LIGHTING FIXTURE MANUFACTURER AND MODEL SERIES F. SHOWN IN LIGHTING FIXTURE SCHEDULE AND ON PLAN ARE BASIS OF DESIGN. ALTERNATE MANUFACTURER AND EQUIPMENT LISTED THAT MEETS THE SALIENT CHARACTERISTICS OF THE LIGHTING FIXTURES LISTED ARE ACCEPTABLE. THE ENGINEER RESERVES THE RIGHT FOR THE MANUFACTURER OR MANUFACTURERS REPRESENTATIVE TO PROVIDE PROOF THAT THE SELECTED EQUIPMENT MEETS ALL FUNCTIONS, PLANS, AND SPECIFICATIONS ARE MET OR EXCEEDED. ALL "OR EQUALS" ARE SUBJECT TO APPROVAL BY ARCHITECT-ENGINEER.
- LIGHTING CONTROL SYSTEM MANUFACTURER IS BASIS OF F. DESIGN. ALTERNATE MANUFACTURER AND EQUIPMENT LISTED THAT MEETS THE SALIENT CHARACTERISTICS OF THE LIGHTING CONTROL DEVICES LISTED ARE ACCEPTABLE. THE ENGINEER RESERVES THE RIGHT FOR THE MANUFACTURER OR MANUFACTURERS REPRESENTATIVE TO PROVIDE PROOF THAT THE SELECTED EQUIPMENT MEETS ALL FUNCTIONS, PLANS, AND SPECIFICATIONS ARE MET OR EXCEEDED. ALL "OR EQUALS" ARE SUBJECT TO APPROVAL BY ARCHITECT-ENGINEER.
- G. LIGHTING CONTROL AND SENSORS SHOWN ON DRAWINGS ARE INDICATED TO DEMONSTRATE DESIGN INTENT. ACTUAL NUMBERS AND LOCATIONS OF DEVICES SHALL BE AS RECOMMENDED BY THE LIGHTING CONTROL MANUFACTURER/SUPPLIER. CONTRACTOR SHALL FURNISH AND INSTALL POWER PACKS, AUXILIARY RELAYS, LOW VOLTAGE TRANSFORMERS, TRANSFORMER DEVICES, ETC. AS REQUIRED AND RECOMMENDED BY THE LIGHTING CONTROL SYSTEM MANUFACTURER/SUPPLIER.
- LETTER NEXT TO LIGHTING FIXTURE INDICATE FIXTURE H. TYPE. REFER TO FIXTURE SCHEDULE ON DRAWING EL-600 FOR ADDITIONAL INFORMATION.
- REFER TO PANEL SCHEDULE ON DRAWING EP-601 FOR Ι. ADDITIONAL INFORMATION.
- EMERGENCY AND EXIT LIGHTING FIXTURES TO BE INSTALLED UNDER THIS CONTRACT SHALL BE FED FROM THE SAME CIRCUIT AS NORMAL LIGHTING IN SPACE AND SHALL BE CONNECTED AHEAD OF THE SWITCH.
- SHADING INDICATES AREAS OF EXISTING Κ. DEVICES, EQUIPMENT, AND FEEDERS THAT ARE \checkmark TO REMAIN UNLESS OTHERWISE NOTED. AREAS FEATURING NO SHADING INDICATE WORK TO BE FURNISHED AND INSTALLED UNDER THIS CONTRACT.

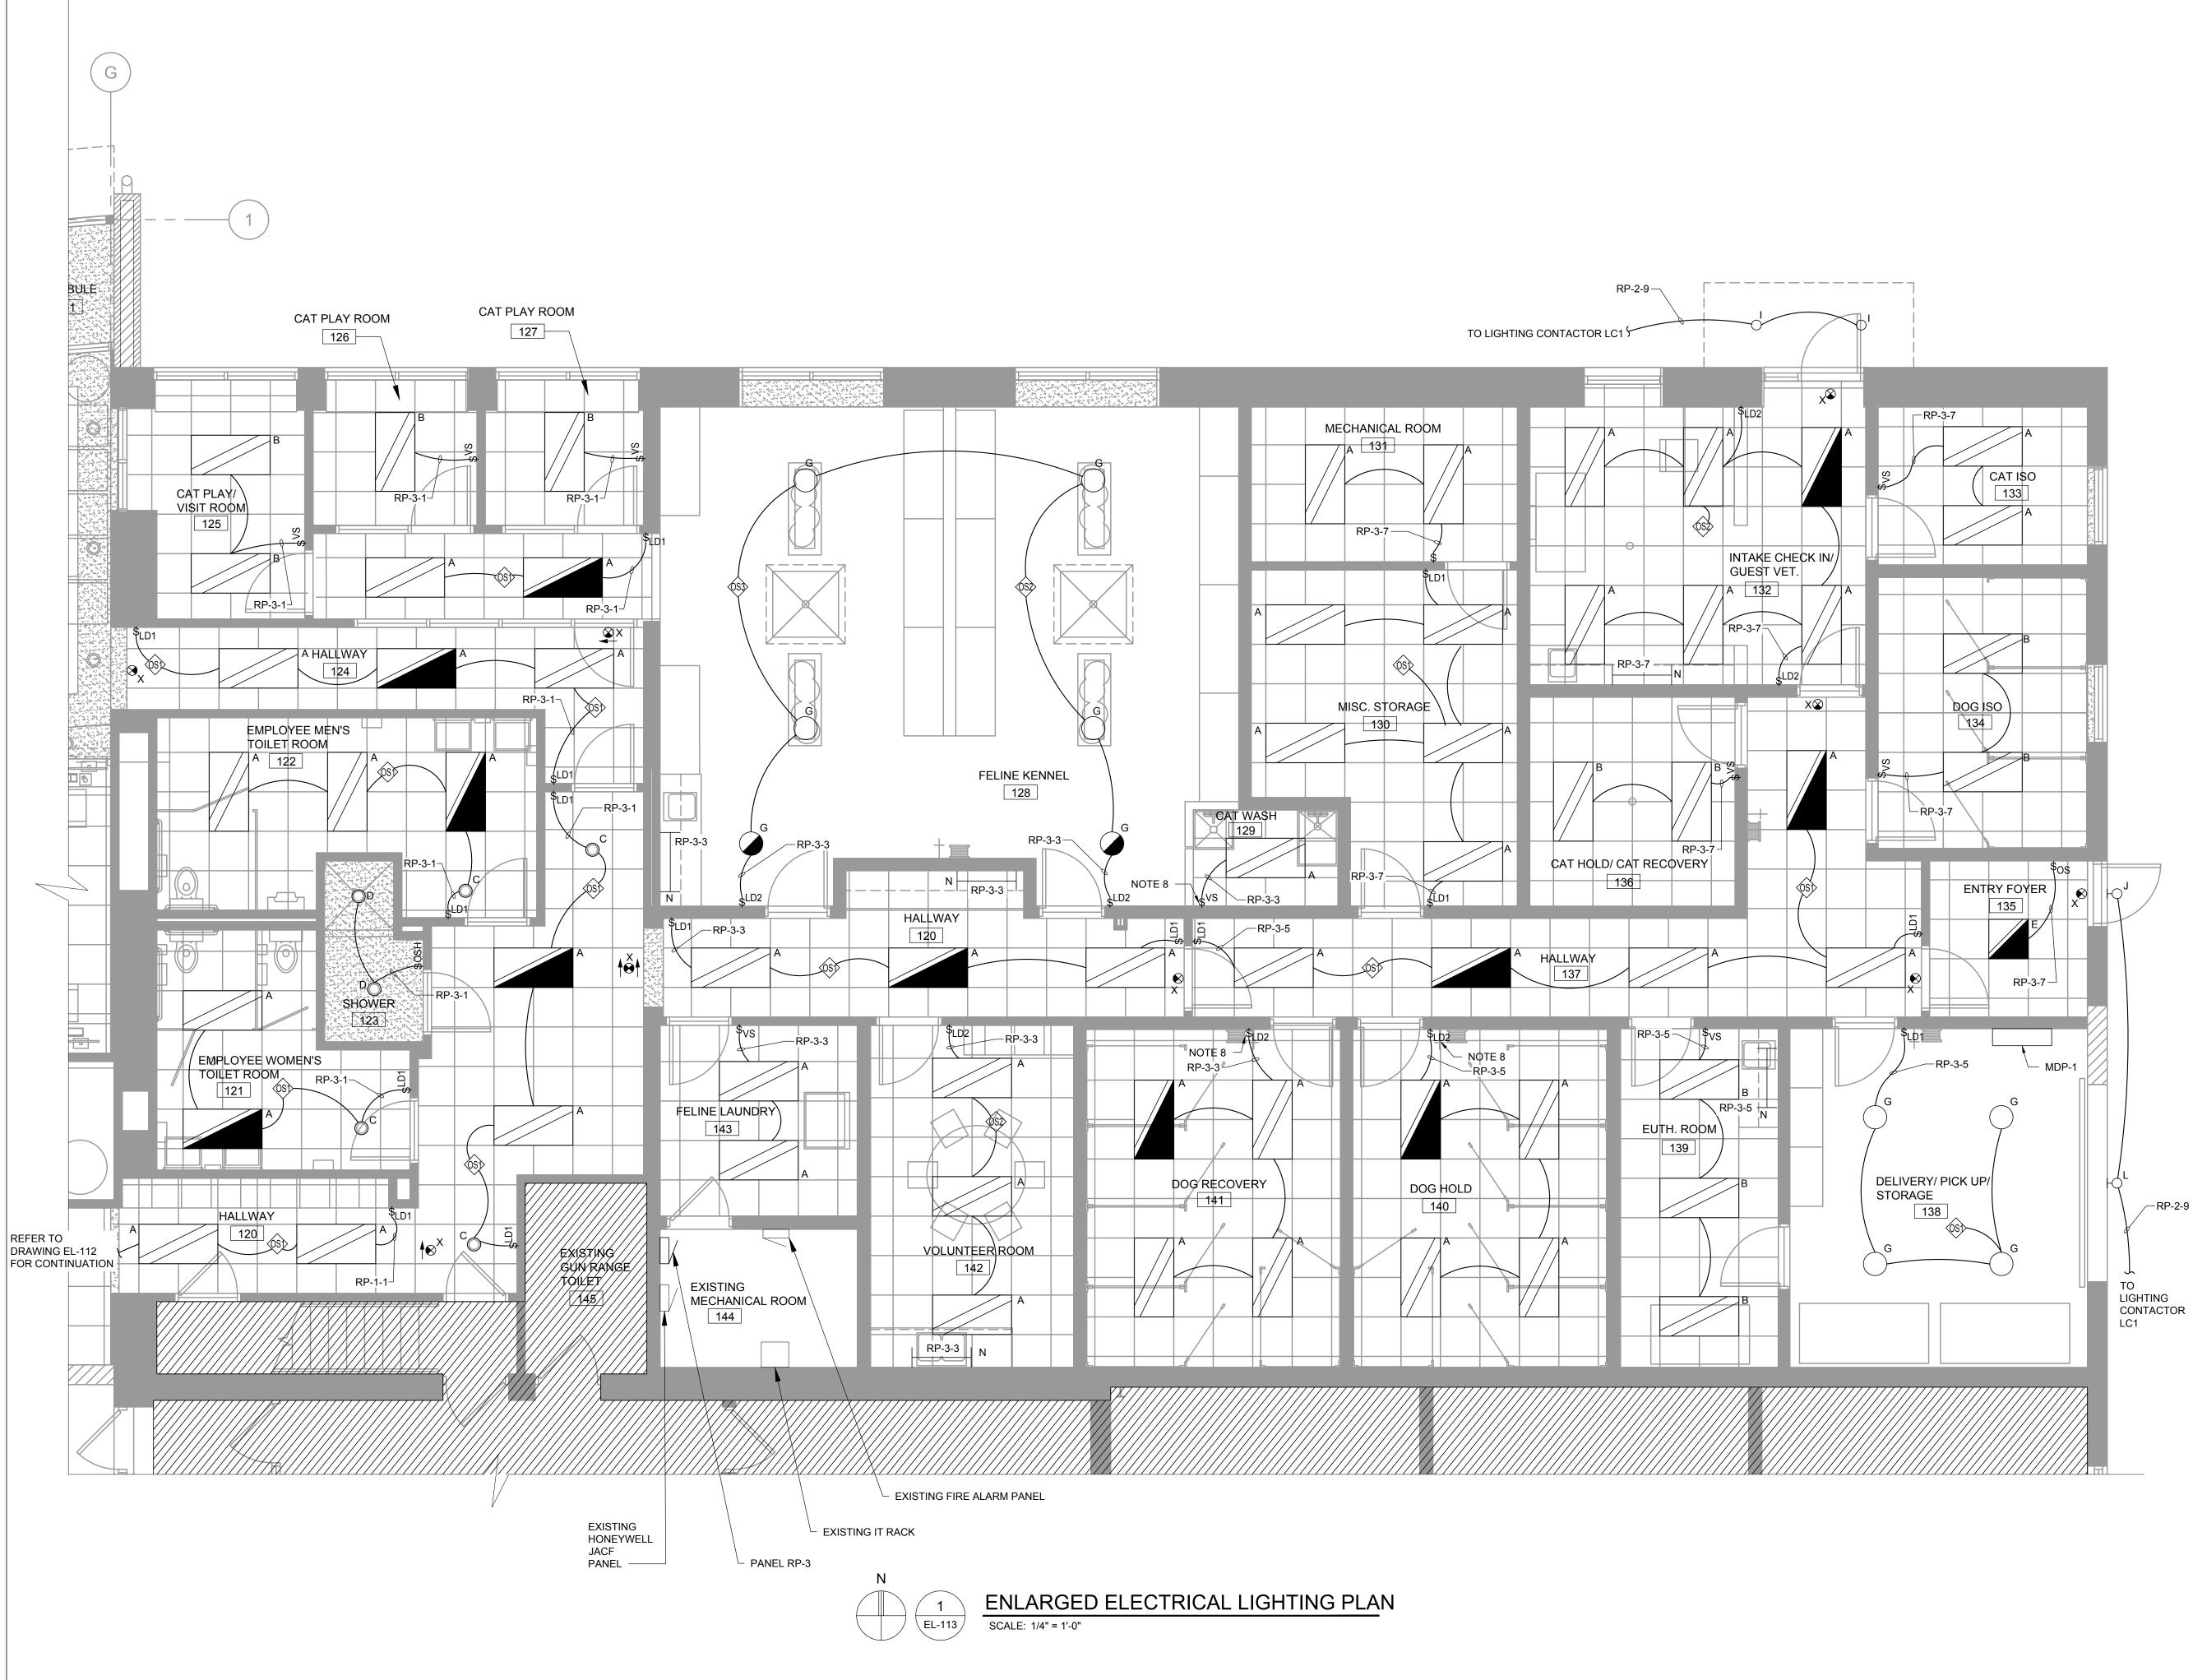NOTES


- 1. FURNISH AND INSTALL WALL MOUNTED OCCUPANCY SENSOR, SENSOR SWITCH MODEL WSX PDT WH OR EQUIVALENT.
- 2. FURNISH AND INSTALL WALL MOUNTED DIMMING VACANCY SENSOR, ACUITY "SENSOR SWITCH" MODEL WSX PDT D VA WH OR EQUIVALENT.
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- 5. FURNISH AND INSTALL WALL MOUNTED ON/OFF SWITCH WITH DIMMING, NLIGHT MODEL NPODM DX WH OR EQUIVALENT.
- 6. FURNISH AND INSTALL CEILING MOUNTED OCCUPANCY SENSOR CONTROL, NLIGHT MODEL NCM PDT 10 AR RJB OR EQUIVALENT.
- 7. FURNISH AND INSTALL WALL MOUNTED OCCUPANCY SENSOR, SENSOR SWITCH MODEL WSX PDT WH LT OR EQUIVALENT.
- 8. LIGHT FIXTURE LOCATED IN SPACE THAT IS WET LOCATION LISTED. FURNISH AND INSTALL LIGHT SWITCH WITH WEATHERPROOF COVER OR ENCLOSURE.
- 9. FURNISH AND INSTALL CEILING MOUNTED OCCUPANCY SENSOR WITH DAYLIGHTING CONTROL, NLIGHT MODEL NCM PDT 10 ADCX AR RJB OR EQUIVALENT.


SYMBOLS

- \$_{OS} WALL MOUNTED OCCUPANCY SENSOR REFER TO NOTE 1
- \$_{VS} WALL MOUNTED VACANCY SENSOR REFER TO NOTE 2
- \$ SINGLE POLE SWITCH
- \$_{I D1} WALL MOUNTED ON/OFF SWITCH REFER TO NOTE 3
- (S) CEILING MOUNTED OCCUPANCY SENSOR REFER TO NOTE 4
- \$1 D2 WALL MOUNTED ON/OFF SWITCH WITH DIMMING -REFER TO NOTE 5
- (\$) CEILING MOUNTED OCCUPANCY SENSOR REFER TO NOTE 6
- \$_{OSH} WALL MOUNTED OCCUPANCY SENSOR HIGH HUMIDITY -REFER TO NOTE 7
- (S) CEILING MOUNTED OCCUPANCY SENSOR WITH PHOTOCELL -REFER TO NOTE 9

Korie - Musical Algorithms Korie - Wand Korie - Musical Algorithms Korie - Musical Algorithms Kovi - Wyandotte - Muskegon Lansing - Gaylord - Sault Ste. Marie Williamsport, PA - Tampa, FL www.sidockgroup.com
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^{Client:} City of Taylor 23555 Goddard Rd. Taylor, MI 48180
Project: City of Taylor Animal Shelter Remodel & Expansion
Seal:
Date Issued For 10-18-2023 50% COMPLETE REVIEW 12-21-2023 OWNER REVIEW 01-17-2024 PERMIT REVIEW
Drawn: JDM Checked: LKR Approved: SRK Sheet Title: ENLARGED ELECTRICAL
LIGHTING PLAN Project Number: 22712.A Sheet Number: EL-113

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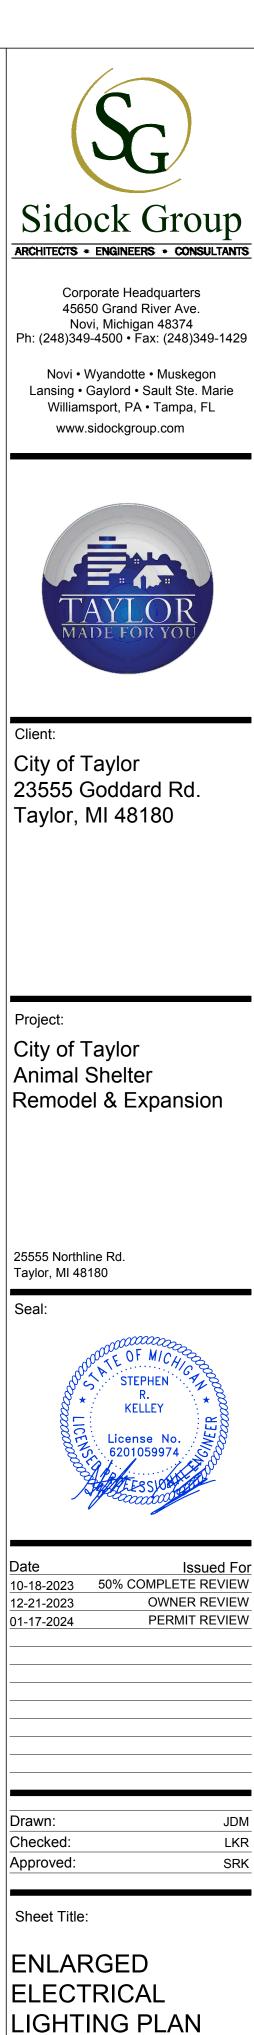
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- D. USE #12 CONDUCTORS FOR 20A CIRCUIT HOME RUNS IF BRANCH CIRCUIT RUN IS LESS THAN 100 FEET FOR 120 VOLT. USE #10 CONDUCTORS IF BRANCH CIRCUIT RUN EXCEEDS 100 FEET FOR 120 VOLT.
- E. LIGHTING FIXTURE MANUFACTURER AND MODEL SERIES SHOWN IN LIGHTING FIXTURE SCHEDULE AND ON PLAN ARE BASIS OF DESIGN. ALTERNATE MANUFACTURER AND EQUIPMENT LISTED THAT MEETS THE SALIENT CHARACTERISTICS OF THE LIGHTING FIXTURES LISTED ARE ACCEPTABLE. THE ENGINEER RESERVES THE RIGHT FOR THE MANUFACTURER OR MANUFACTURERS REPRESENTATIVE TO PROVIDE PROOF THAT THE SELECTED EQUIPMENT MEETS ALL FUNCTIONS, PLANS, AND SPECIFICATIONS ARE MET OR EXCEEDED. ALL "OR EQUALS" ARE SUBJECT TO APPROVAL BY ARCHITECT-ENGINEER.
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- H. LETTER NEXT TO LIGHTING FIXTURE INDICATE FIXTURE TYPE. REFER TO FIXTURE SCHEDULE ON THIS SHEET FOR ADDITIONAL INFORMATION.
- I. REFER TO PANEL SCHEDULE ON DRAWING E-3 FOR ADDITIONAL INFORMATION.
- J. EMERGENCY AND EXIT LIGHTING FIXTURES TO BE INSTALLED UNDER THIS CONTRACT SHALL BE FED FROM THE SAME CIRCUIT AS NORMAL LIGHTING IN SPACE AND SHALL BE CONNECTED AHEAD OF THE SWITCH.

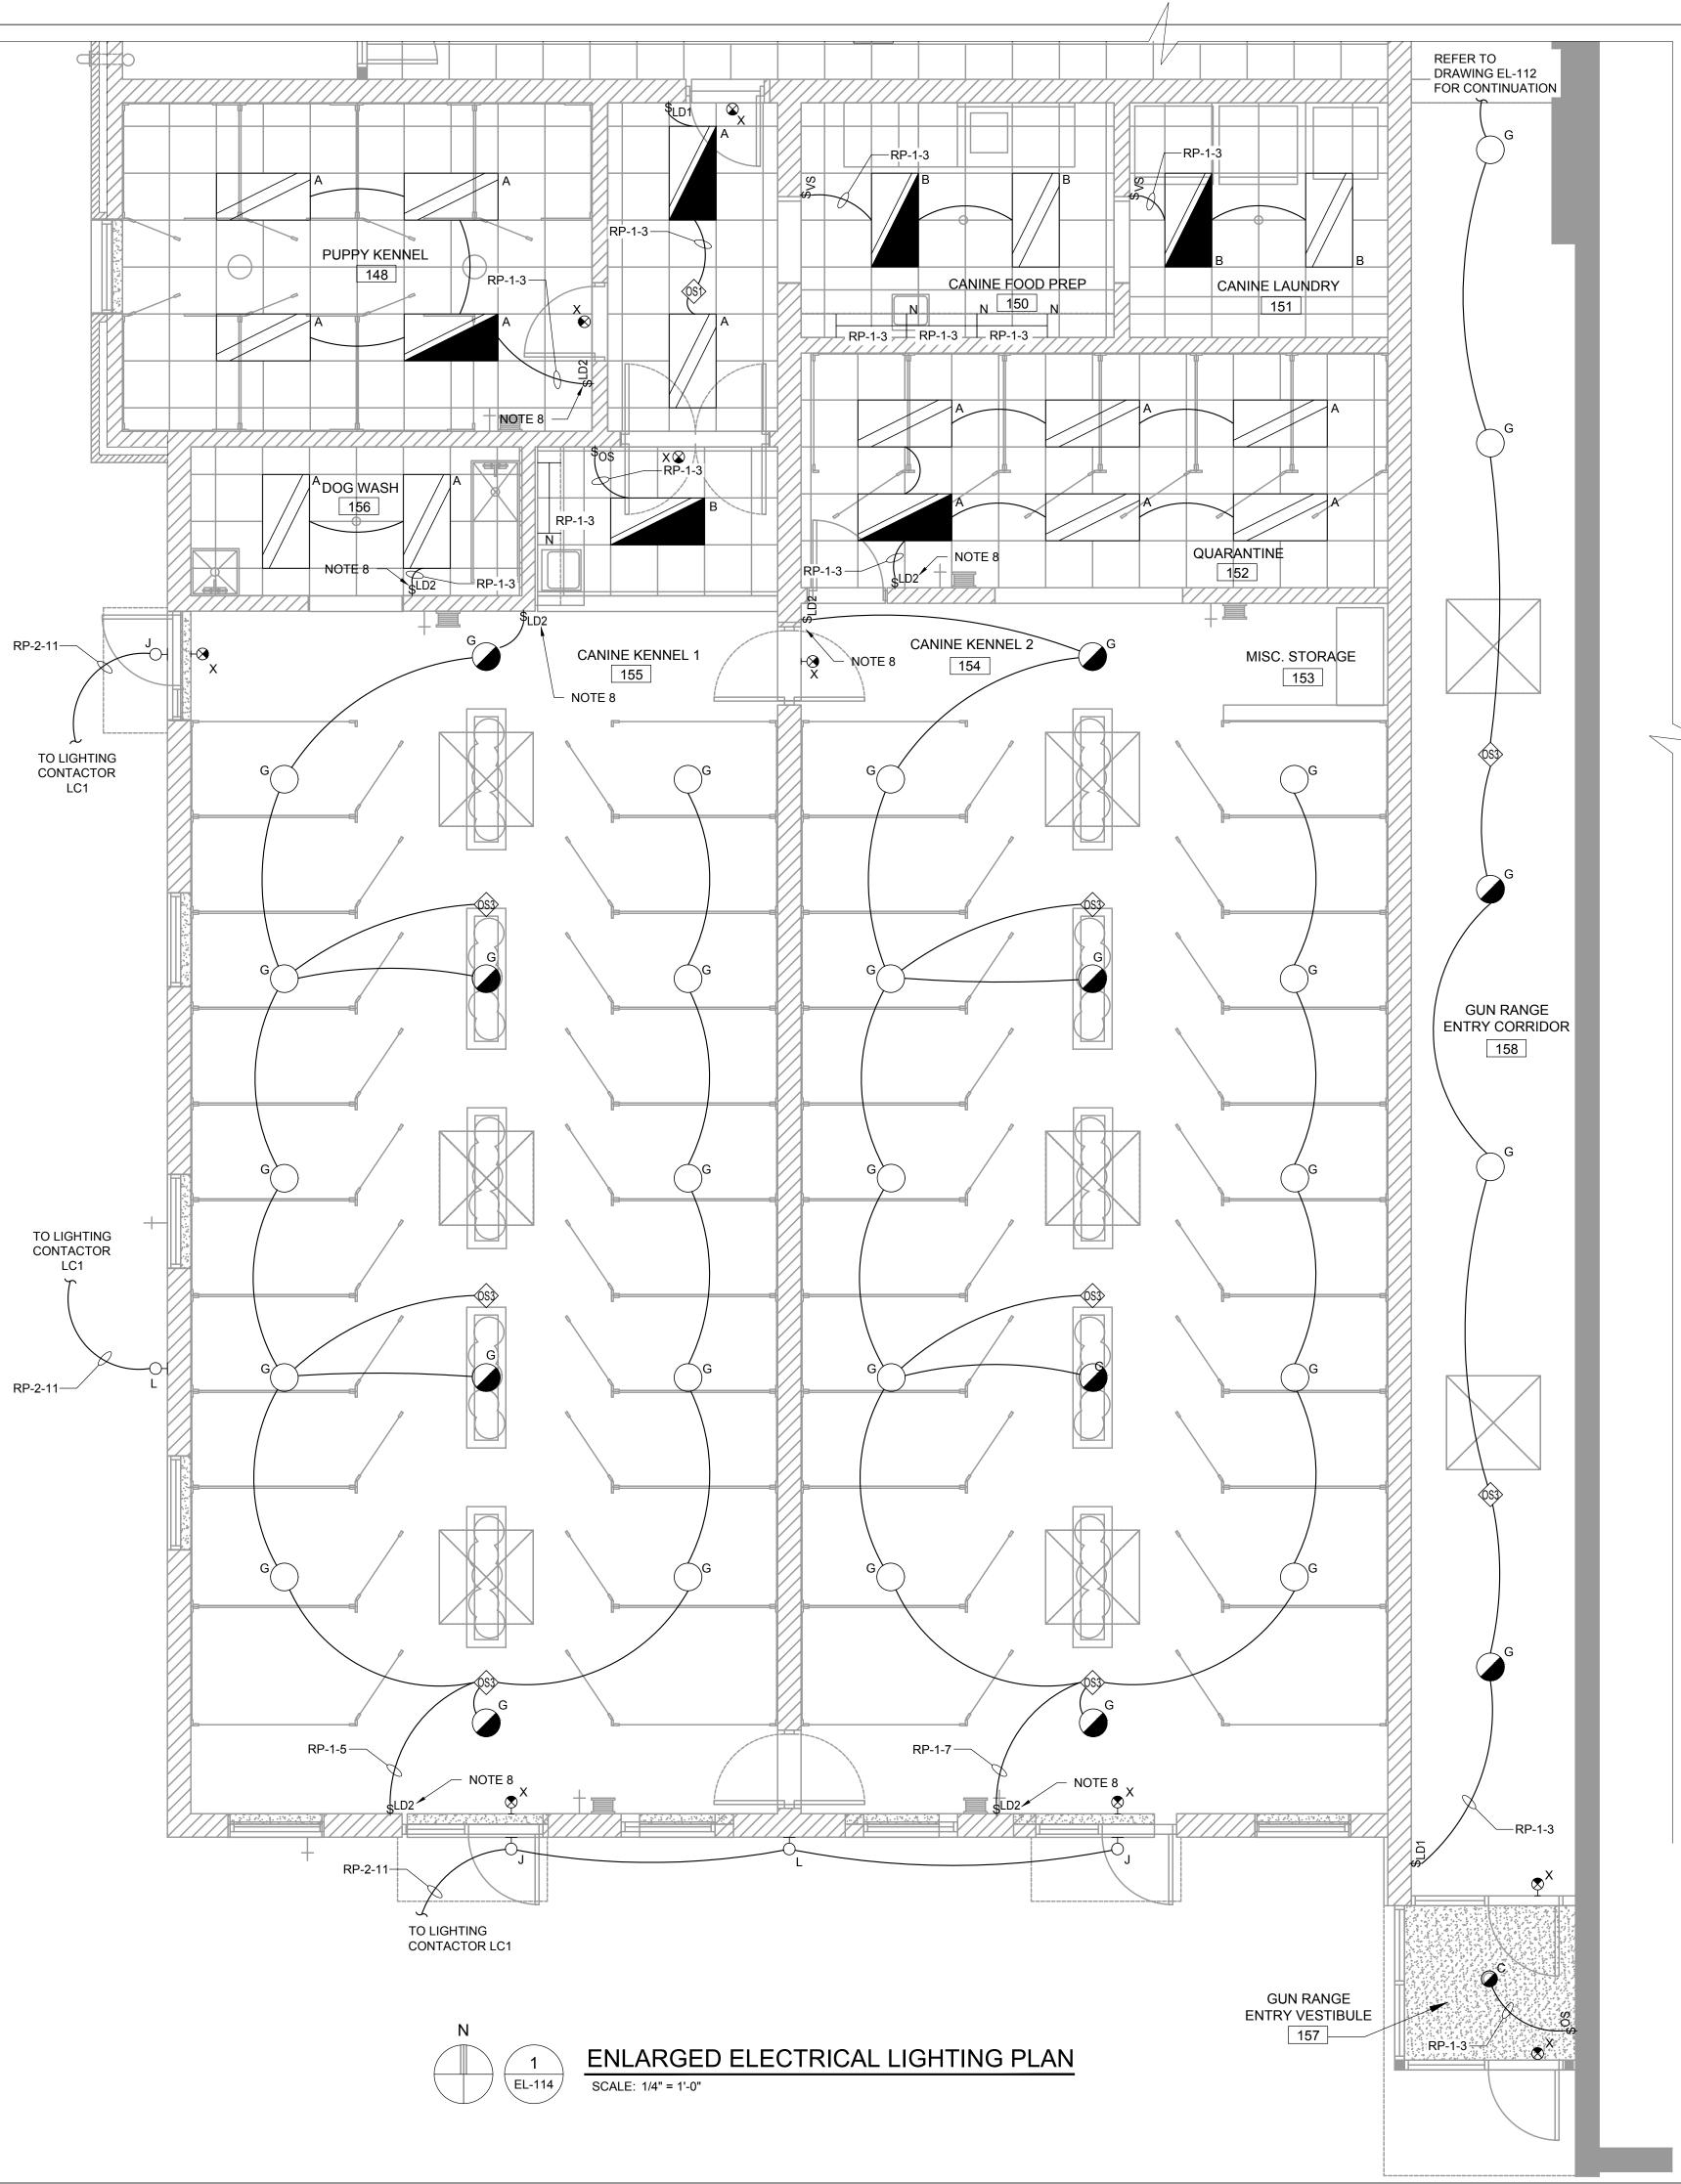NOTES

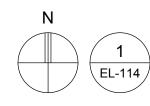- 1. FURNISH AND INSTALL WALL MOUNTED OCCUPANCY SENSOR, SENSOR SWITCH MODEL WSX PDT WH OR EQUIVALENT.
- 2. FURNISH AND INSTALL WALL MOUNTED DIMMING VACANCY SENSOR, ACUITY "SENSOR SWITCH" MODEL WSX PDT D VA WH OR EQUIVALENT.
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- 6. FURNISH AND INSTALL CEILING MOUNTED OCCUPANCY SENSOR WITH DAYLIGHTING CONTROL, NLIGHT MODEL NCM PDT 10 ADCX AR RJB OR EQUIVALENT.
- 7. FURNISH AND INSTALL WALL MOUNTED OCCUPANCY SENSOR, SENSOR SWITCH MODEL WSX PDT WH LT OR EQUIVALENT.
- 8. LIGHT FIXTURE LOCATED IN SPACE THAT IS WET LOCATION LISTED. FURNISH AND INSTALL LIGHT SWITCH WITH WEATHERPROOF COVER OR ENCLOSURE.

SYMBOLS

- \$_{OS} WALL MOUNTED OCCUPANCY SENSOR REFER TO NOTE 1
- \$_{VS} WALL MOUNTED VACANCY SENSOR REFER TO NOTE 2
- \$ SINGLE POLE SWITCH
- \$_{I D1} WALL MOUNTED ON/OFF SWITCH REFER TO NOTE 3
- (S) CEILING MOUNTED OCCUPANCY SENSOR REFER TO NOTE 4
- $_{\rm ID2}$ Wall mounted on/off switch with dimming Refer to notes
- (\$) CEILING MOUNTED OCCUPANCY SENSOR REFER TO NOTE 6
- (\$) CEILING MOUNTED OCCUPANCY SENSOR WITH PHOTOCELL **REFER TO NOTE 7**



22712.A

Project Number:

Sheet Number: EL-114

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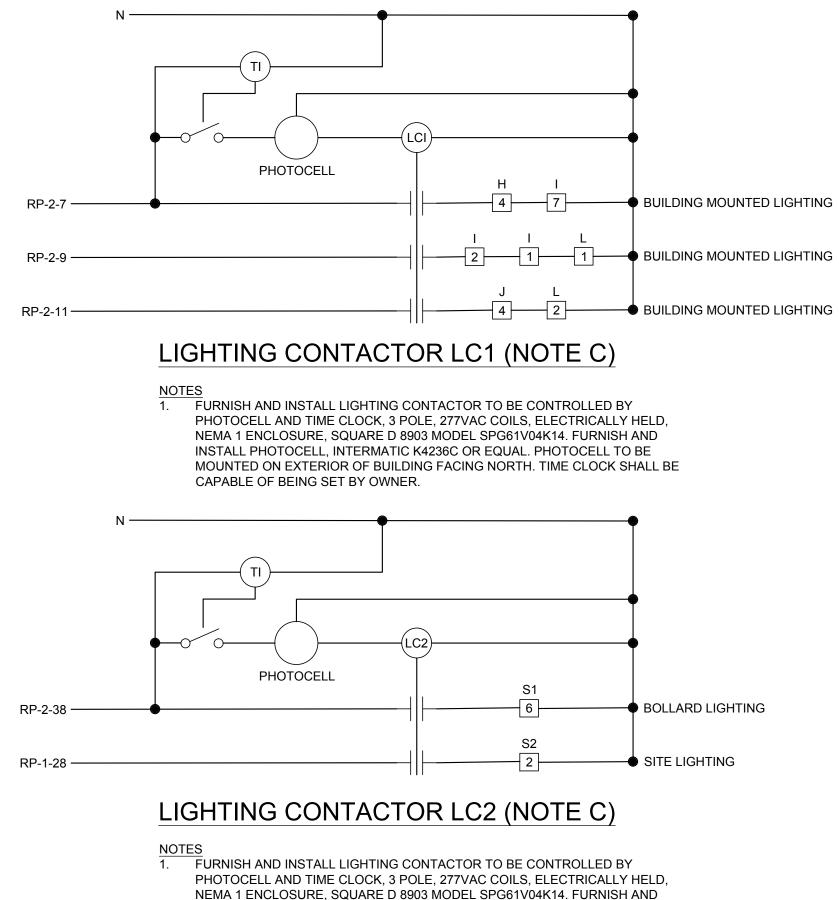
Project:

Animal Shelter Remodel & Expansion

Taylor, MI 48180

			FIXIU	RE SCH		
SYMBOL	TYPE	SIZE AND MOUNTING	VOLTAGE, (INPUT WATTAGE)	LAMPS AND LUMENS	MANUFACTURER / CATALOG NUMBER	REMARKS
	A	2' X 4' (NOMINAL) RECESSED TROFFER	120V (24.1W)	4000K WHITE LIGHT EMITTING DIODES - 3,269 LUMENS (NOMINAL)	LITHONIA "STACK" SERIES - STAK 2X4 3000 LM 80CRI 40K COL MIN10 ZT MVOLT	NOTE 8
	В	2' X 4' (NOMINAL) RECESSED TROFFER	120V (33.2W)	4000K WHITE LIGHT EMITTING DIODES - 4,255 LUMENS (NOMINAL)	LITHONIA "STACK" SERIES - STAK 2X4 4000 LM 80CRI 40K COL MIN10 ZT MVOLT	NOTE 8
0	С	6" DIA (NOMINAL) DOWNLIGHT	120V (10.44W)	4000K WHITE LIGHT EMITTING DIODES - 952 LUMENS (NOMINAL)	LITHONIA "LDN6" SERIES - LDN6 40/10 LO6AR LSS TRW MVOLT GZ10	NOTE 9
0	D	6" DIA (NOMINAL) SHOWER DOWNLIGHT	120V (14.7W)	4000K WHITE LIGHT EMITTING DIODES - 980 LUMENS (NOMINAL)	GOTHAM "EVO SHOWER" SERIES - EVO6SH 40/15 DFR SMO MVOLT EZ1	-
	E	2' X 2' (NOMINAL) RECESSED TROFFER	120V (33.3W)	4000K WHITE LIGHT EMITTING DIODES - 4,255 LUMENS (NOMINAL)	LITHONIA "STACK" SERIES - STAK 2X2 4000LM 80CRI 40K COL MIN10 ZT	NOTE 8
\bigcirc	F	36" DIA (NOMINAL) PENDANT	120V (28.4W)	4000K WHITE LIGHT EMITTING DIODES - 2,779 LUMENS (NOMINAL)	EUREKA "ATOLL-4850" - 4850-60 D LED 40 90 120V DV RDP RCA BLKE	NOTE 4
\bigcirc	G	19" DIA (NOMINAL) ROUND LOWBAY	120V (43W)	4000K WHITE LIGHT EMITTING DIODES - 6,253 LUMENS (NOMINAL)	LITHONIA "VCVL" SERIES - VCVL LED V4 P3 80CRI T5M MVOLT AC6 DBLXD	NOTES 1,10
<u>Р</u>	н	WALL SCONCE	120V (60W)	4000K WHITE LIGHT EMITTING DIODES - 6,610 LUMENS (NOMINAL)	METEOR "LANCE 6" SERIES - LA6 60 408 UNV NOD 40 40 BLK NO OUT	NOTE 2
0	I	4" DIA (NOMINAL) SURFACE MOUNTED DOWNLIGHT WET LOCATION	120V (10.58W)	4000K WHITE LIGHT EMITTING DIODES - 1045 LUMENS (NOMINAL)	LITHONIA "LDN4CYL" SERIES - LDN4CYL 40/10 L04 AR LSS MVOLT GZ10 FCM WL DBL	-
Q	J	EXTERIOR MANDOOR WALLPACK	120V (15W)	4000K WHITE LIGHT EMITTING DIODES - 1,978 LUMENS (NOMINAL)	LITHONIA "WDGE" LED - WDGE 1 LED 40K 8CRI VF MVOLT SRM E4WH DBLXD	NOTE 3
\bigcirc	к	60" DIA (NOMINAL) PENDANT	120V (48.7W)	4000K WHITE LIGHT EMITTING DIODES - 4759 LUMENS (NOMINAL)	EUREKA "ATOLL-4856" - 4850-60 D LED 40 90 120V DV RDP AC RCA BLKE	NOTE 4

	FIXTURE SCHEDULE									
SYMBOL	TYPE	SIZE AND MOUNTING	VOLTAGE, (INPUT WATTAGE)	LAMPS AND LUMENS	MANUFACTURER / CATALOG NUMBER	REMARKS				
Ŷ	L	WALLPACK	120V (88W)	4000K WHITE LIGHT EMITTING DIODES - 12,277 LUMENS (NOMINAL)	LITHONIA "WEDGE" SERIES - WEDGE 3 P4 40K 80CRI RFT MVOLT SRM EI5WH DBLXD	NOTE 5				
	М	1' X 4' (NOMINAL) SURFACE STRIP LIGHT	120V (25.5W)	4000K WHITE LIGHT EMITTING DIODES - 3,000 LUMENS (NOMINAL)	LITHONIA "CLX" SERIES - CLX L48 4000LV SEF RDL MVOLT G21 40K 80CRI WH	_				
	N	UNDERCABINET LIGHTING	120V (16.4W)	3,500K WHITE LIGHT EMITTING DIODES - 1,161 LUMENS (NOMINAL)	LITHONIA "UCES" SERIES - UCES 36IN SWW6 90CRI WH M6	_				
⊗	x	EXIT LIGHT - CEILING OR WALL MOUNT	120V (4.3W)	RED LIGHT EMITTING DIODESS	LITHONIA "LHQM" SERIES - LHQM LED HORO	NOTE 6,7				
0	S1	SITE BOLLARD	120V (5W)	3000K WHITE LIGHT EMITTING DIODES - 457 LUMENS (NOMINAL)	DELTA "WKB" SERIES - WKB L 7 SP 30 FX N XX INC ND-120	NOTE 11				
Ţ	S2	SITE POLE MOUNTED LIGHT FIXTURES	120V (69W)	4000K WHITE LIGHT EMITTING DIODES - 8,988 LUMENS (NOMINAL)	LITHONIA "DSXO" SERIES - DSX0 P3 40K 70CRI TFTM MVOLT SPA DDBXD	NOTE 12				



NEMA 1 ENCLOSURE, SQUARE D 8903 MODEL SPG61V04K14. FURNISH AND INSTALL PHOTOCELL, INTERMATIC K4236C OR EQUAL. PHOTOCELL TO BE MOUNTED ON EXTERIOR OF BUILDING FACING NORTH. TIME CLOCK SHALL BE CAPABLE OF BEING SET BY OWNER.

GENERAL NOTES

A. REFER TO ELECTRICAL SPECIFICATIONS ON DRAWING E-1 FOR ADDITIONAL INFORMATION.

- B. LIGHTING FIXTURE MANUFACTURER AND MODEL SERIES SHOWN IN LIGHTING FIXTURE SCHEDULE AND ON PLAN ARE BASIS OF DESIGN. ALTERNATE MANUFACTURER AND EQUIPMENT LISTED THAT MEETS THE SALIENT CHARACTERISTICS OF THE LIGHTING FIXTURES LISTED ARE ACCEPTABLE. THE ENGINEER RESERVES THE RIGHT FOR THE MANUFACTURER OR MANUFACTURERS REPRESENTATIVE TO PROVIDE PROOF THAT THE SELECTED EQUIPMENT MEETS ALL FUNCTIONS, PLANS, AND SPECIFICATIONS ARE MET OR EXCEEDED. ALL "OR EQUALS" ARE SUBJECT TO APPROVAL BY ARCHITECT-ENGINEER.
- C. EXTERIOR LIGHTING CONTROL DEVICES AND CONTROL SYSTEMS SHALL BE TESTED TO ENSURE THAT CONTROL HARDWARE AND SOFTWARE ARE CALIBRATED., ADJUSTED, PROGRAMMED, AND IN PROPER WORKING CONDITION IN ACCORDANCE WITH THE CONSTRUCTION DOCUMENTS AND MANUFACTURER'S INSTALLATION INSTRUCTIONS PER ASHRAE 90.1 - 2013 SECTION 9.4.3. TESTING OF THIS SYSTEM SHALL BE PERFORMED BY AN APPROVED THIRD-PARTY. DOCUMENTATION CERTIFYING THAT THE INSTALLED LIGHTING CONTROLS MEET OR EXCEED ALL DOCUMENTED PERFORMANCE CRITERIA SHALL BE RECEIVED ONCE COMMISSIONING OF EXTERIOR LIGHTING CONTROL SYSTEM IS COMPLETE.

NOTES

1. REFER TO MOUNTING HEIGHTS ON LIGHTING PLANS FOR ADDITIONAL INFORMATION.

- 2. MOUNT BOTTOM OF FIXTURE 6'-0" ABOVE FINISHED FLOOR.
- 3. MOUNT BOTTOM OF FIXTURE 1'-0" ABOVE MANDOOR FRAME.
- 4. MOUNT BOTTOM OF FIXTURE 10'-0" ABOVE FINISHED FLOOR.
- 5. MOUNT BOTTOM OF FIXTURE 16'-0" ABOVE FINISHED FLOOR.
- 6. FOR WALL MOUNTED FIXTURES, MOUNT BOTTOM OF FIXTURE 8'-0" ABOVE FINISHED FLOOR.
- 7. FIXTURE SHALL MEET NFPA LIFE SAFETY CODE 101 AND BE LISTED UNDER UL924.
- 8. FOR FIXTURES WITH HALF-SHADING ON FLOOR PLAN, FURNISH AND INSTALL FIXTURE WITH E15WLCP BATTERY PACK.
- 9. FOR FIXTURES WITH HALF -SHADING ON FLOOR PLAN, FURNISH AND INSTALL FIXTURE WITH ELSD BATTERY PACK.
- 10. FOR FIXTURES WITH HALF-SHADING ON FLOOR PLAN, FURNISH AND INSTALL FIXTURE WITH E10WH BATTERY PACK.
- 11. VERIFY MOUNTING REQUIREMENTS REQUIRED IN FIELD PRIOR TO ORDERING FIXTURE.
- 12. FURNISH AND INSTALL 15'-0" LIGHT POLE, LITHONIA LIGHTING SSA 15 4C DDBXD, WITH DM19AS MOUNTING. CONTRACTOR SHALL FIELD VERIFY EXISTING LIGHT POLE ANCHOR BOLT ORIENTATION AND COORDINATE WITH NEW LIGHT POLE FOR COMPATIBILITY PRIOR TO PURCHASE OF LIGHT POLE.

LIGHTING CONTROL SEQUENCE OF OPERATION LIGHTING CONTROL SYSTEM HAS BEEN DESIGNED TO MEET SPECIFIC OPERATIONAL REQUIREMENTS AND FUNCTIONALITY AS FOLLOWS:

- DOG ROOM/VISIT 107, DOG ROOM/VISIT 108, DOG ROOM/VISIT 109, OFFICE 113, OFFICE 114, OFFICE 115, OFFICE 116, CAT PLAY/VISIT ROOM 125, CAT PLAY ROOM 126, CAT PLAY ROOM 127, FELINE LAUNDRY 143, CAT HOLD/CAT RECOVERY 136, CAT ISO 133, DOG ISO 134, CAT WASH 129, CANINE LAUNDRY 146, CANINE FOOD PREP 145


 a. CONTROLLED BY: WALL MOUNTED VACANCY SENSOR WITH DIMMING CONTROL NEAR
- DOOR OF EACH ROOM.
- b. CIRCUIT CAPABILITY: SINGLE.c. TIME DELAY: SET FOR 10-MINUTE DELAY
- d. SYSTEM BRANCH: NORMAL AND EMERGENCY
- e. AUTOMATIC SWITCHING MODE: MANUAL ON; MANUAL OR AUTOMATIC OFF.
- MECH/ELEC 110, MECH/ELEC 117, MECHANICAL ROOM 131


 a. CONTROLLED BY: CONVENTIONAL WALL MOUNTED TOGGLE SWITCHES NEAR MAIN ACCESS DOOR(S). AUTOMATIC CONTROLS ARE EXEMPT FOR SAFETY REASONS.
 b. CIRCUIT CAPABILITY: SINGLE.
- c. TIME DELAY: NONE
- d. SYSTEM BRANCH: NORMAL AND EMERGENCY e. AUTOMATIC SWITCHING MODE: NONE
- 3. <u>EMPLOYEE BREAK ROOM 112, INTAKE CHECK IN/GUEST VET 132</u> a. CONTROLLED BY: LOCAL CEILING MOUNTED OCCUPANCY SENSOR(S) WITH LOCAL
- WALL MOUNTED ON/OFF DIMMER SWITCHES AT MAIN ACCESS DOOR(S) OR ENTRANCE FOR MANUAL OVERRIDE OF AUTOMATIC CONTROL.
 b. CIRCUIT CAPABILITY: SINGLE.
- c. TIME DELAY: SET FOR 10-MINUTE DELAY
- d. SYSTEM BRANCH: NORMAL AND EMERGENCYe. AUTOMATIC SWITCHING MODE: MANUAL ON; MANUAL OR AUTOMATIC OFF.
- 4. HALLWAY 111, HALLWAY 118, HALLWAY 119, MEN'S TOILET ROOM 103, WOMEN'S TOILET ROOM 104, EMPLOYEE WOMEN'S TOILET ROOM 121, EMPLOYEE MEN'S TOILET ROOM 122, HALLWAY 124, HALLWAY 120, HALLWAY 137, MISC. STORAGE 130, HALLWAY TO CANINE KENNEL, DELIVERY/PICKUP/STORAGE 138
- a. CONTROLLED BY: LOCAL CEILING MOUNTED OCCUPANCY SENSOR(S) WITH LOCAL WALL MOUNTED ON/OFF SWITCHES AT MAIN ACCESS DOOR(S) OR ENTRANCE FOR MANUAL OVERRIDE OF AUTOMATIC CONTROL.
- b. CIRCUIT CAPABILITY: SINGLE.
- c. TIME DELAY: SET FOR 10-MINUTE DELAY
- d. SYSTEM BRANCH: NORMAL AND EMERGENCYe. AUTOMATIC SWITCHING MODE: AUTOMATIC ON; MANUAL OR AUTOMATIC OFF.
- 5. <u>RECEPTION 102</u>
- a. CONTROLLED BY: FIXTURE TYPE A & C CONTROLLED BY LOCAL CEILING MOUNTED OCCUPANCY SENSOR(S) WITH LOCAL WALL MOUNTED ON/OFF DIMMER SWITCHES AT MAIN ACCESS DOOR(S) OR ENTRANCE FOR MANUAL OVERRIDE OF AUTOMATIC CONTROL.
- b. CIRCUIT CAPABILITY: SINGLE.
- c. TIME DELAY: SET FOR 10-MINUTE DELAYd. SYSTEM BRANCH: NORMAL AND EMERGENCY
- e. AUTOMATIC SWITCHING MODE: MANUAL ON; MANUAL OR AUTOMATIC OFF.
- 6. LOBBY 100, VESTIBULE 101, GUN RANGE ENTRY CORRIDOR 152
- a. CONTROLLED BY: LOCAL CEILING MOUNTED OCCUPANCY SENSOR(S) WITH
- DAYLIGHTING CONTOL AND LOCAL WALL MOUNTED ON/OFF SWITCHES AT MAIN ACCESS DOOR(S) OR ENTRANCE FOR MANUAL OVERRIDE OF AUTOMATIC CONTROL. b. CIRCUIT CAPABILITY: SINGLE.
- c. TIME DELAY: SET FOR 10-MINUTE DELAY
- d. SYSTEM BRANCH: NORMAL AND EMERGENCYe. AUTOMATIC SWITCHING MODE: AUTOMATIC ON; MANUAL OR AUTOMATIC OFF.
- FELINE KENNEL 128, CANINE KENNEL 1 149, CANINE KENNEL 2 148

 CONTROLLED BY: LOCAL CEILING MOUNTED OCCUPANCY SENSOR(S) WITH
- DAYLIGHTING CONTOL AND LOCAL WALL MOUNTED ON/OFF SWITCHES WITH DIMMING AT MAIN ACCESS DOOR(S) OR ENTRANCE FOR MANUAL OVERRIDE OF AUTOMATIC CONTROL.
- b. CIRCUIT CAPABILITY: SINGLE.
- c. TIME DELAY: SET FOR 10-MINUTE DELAYd. SYSTEM BRANCH: NORMAL AND EMERGENCY
- e. AUTOMATIC SWITCHING MODE: MANUAL ON; MANUAL OR AUTOMATIC OFF.
- MULTIPURPOSE STORAGE ROOM 106, SHOWER 123, GUN RANCGE ENTRY VESTIBULE 151

 CONTROLLED BY: WALL MOUNTED OCCUPANCY SENSOR NEAR DOOR OF EACH ROOM.
 CIRCUIT CAPABILITY: SINGLE.
- c. TIME DELAY: SET FOR 10-MINUTE DELAY
- d. SYSTEM BRANCH: NORMAL AND EMERGENCY
- e. AUTOMATIC SWITCHING MODE: AUTOMATIC ON; MANUAL OR AUTOMATIC OFF.
- DOG HOLD 140, DOG RECOVERY 141, DOG WASH 150, PUPPY KENNEL 144, QUARANTINE 147


 CONTROLLED BY: FIXTURE MOUNTED OCCUPANCY SENSOR(S) WITH LOCAL WALL MOUNTED ON/OFF DIMMER SWITCHES AT MAIN ACCESS DOOR(S) OR ENTRANCE FOR MANUAL OVERRIDE OF AUTOMATIC CONTROL.
- b. CIRCUIT CAPABILITY: SINGLE.
- c. TIME DELAY: SET FOR 10-MINUTE DELAYd. SYSTEM BRANCH: NORMAL AND EMERGENCY
- e. AUTOMATIC SWITCHING MODE: MANUAL ON; MANUAL OR AUTOMATIC OFF.

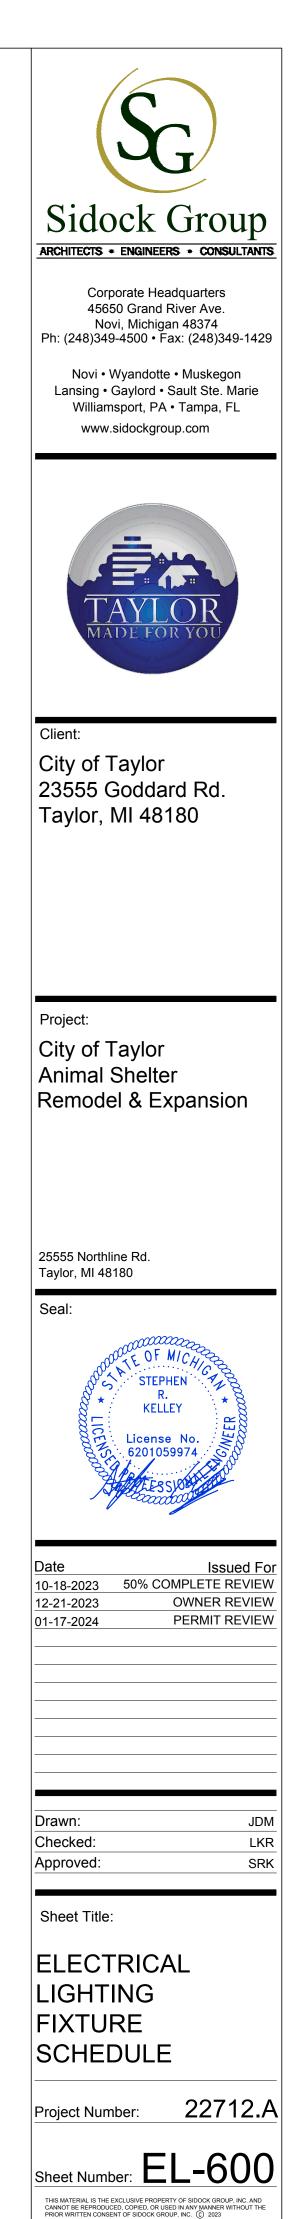

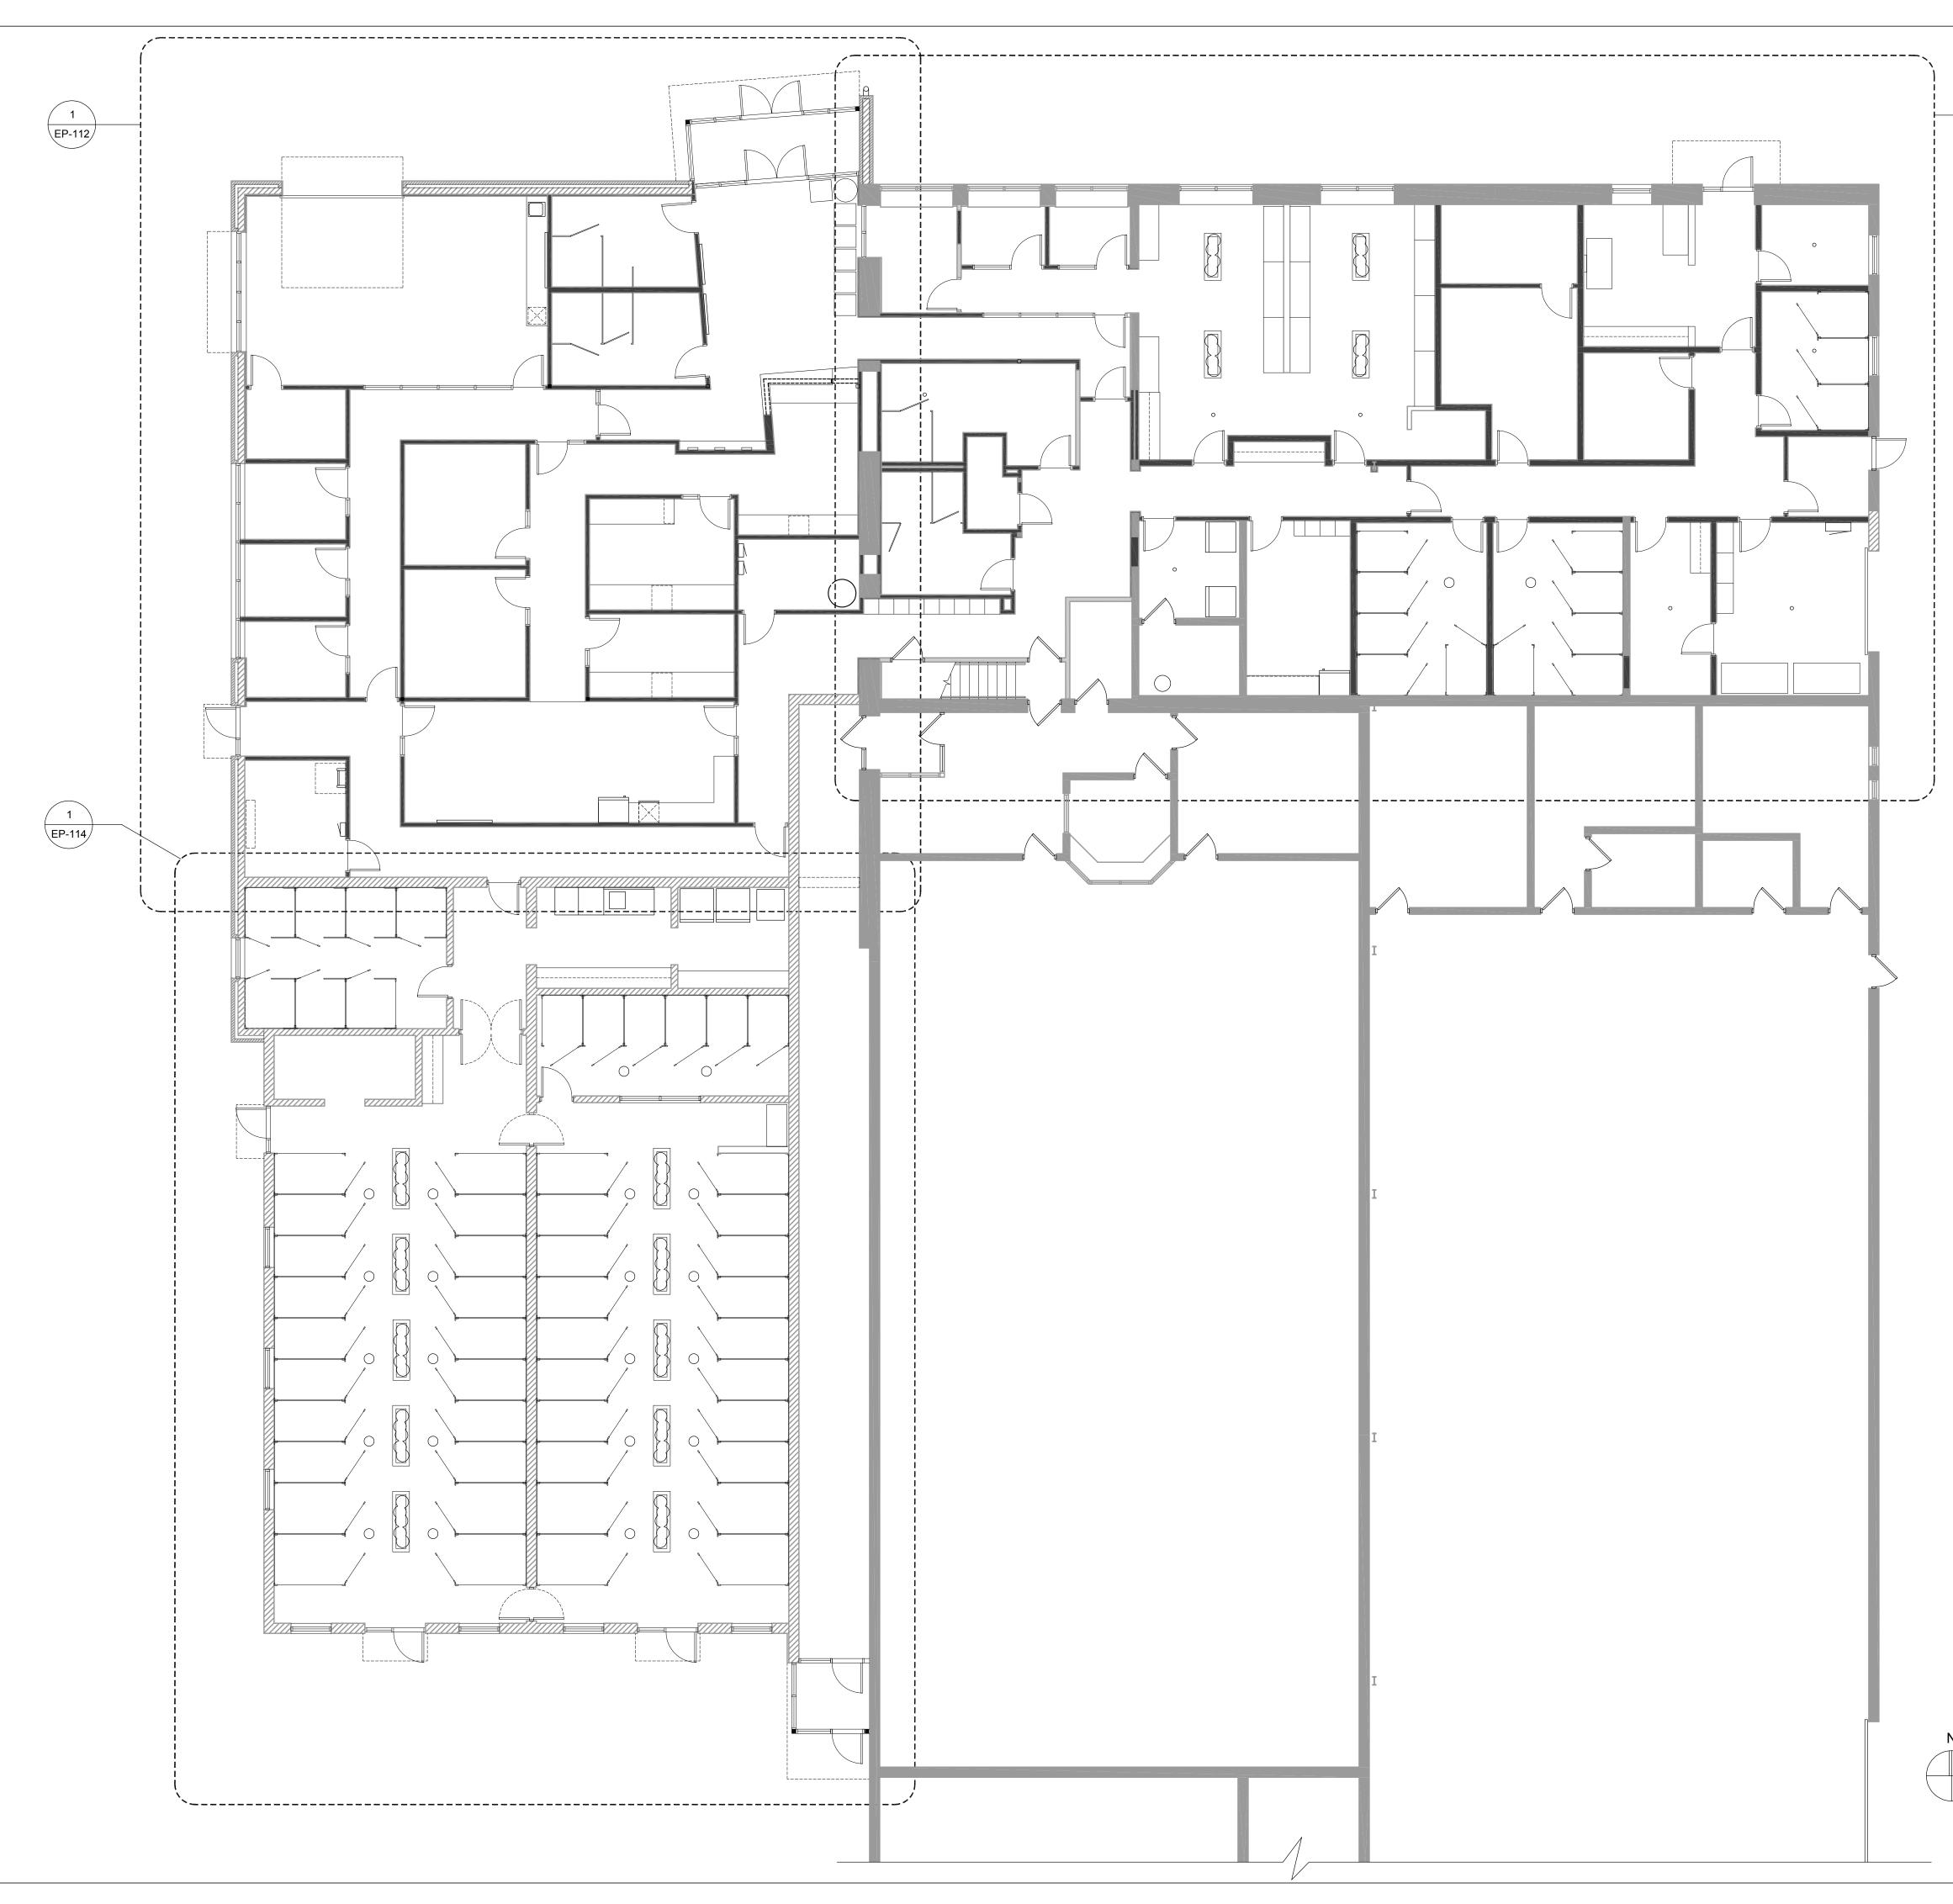



GENERAL NOTES A. REFER TO ELECTRICAL SPECIFICATIONS FOR ADDITIONAL INFORMATION.

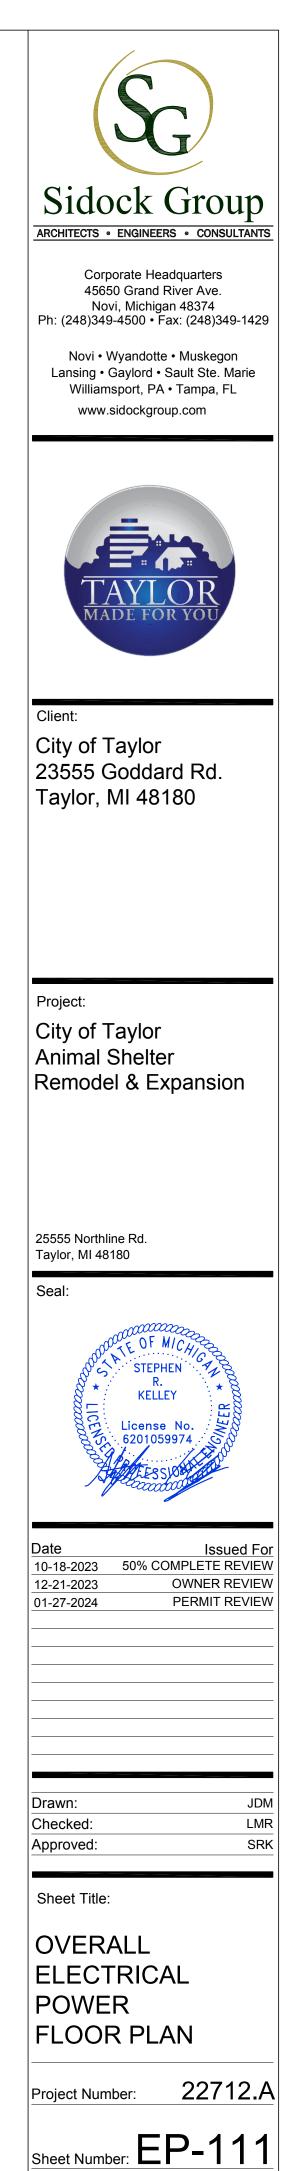

•		
	(1 EP-111	
		/

OVERALL ELECTRICAL POWER FLOOR PLAN SCALE: 1/8" = 1'-0"

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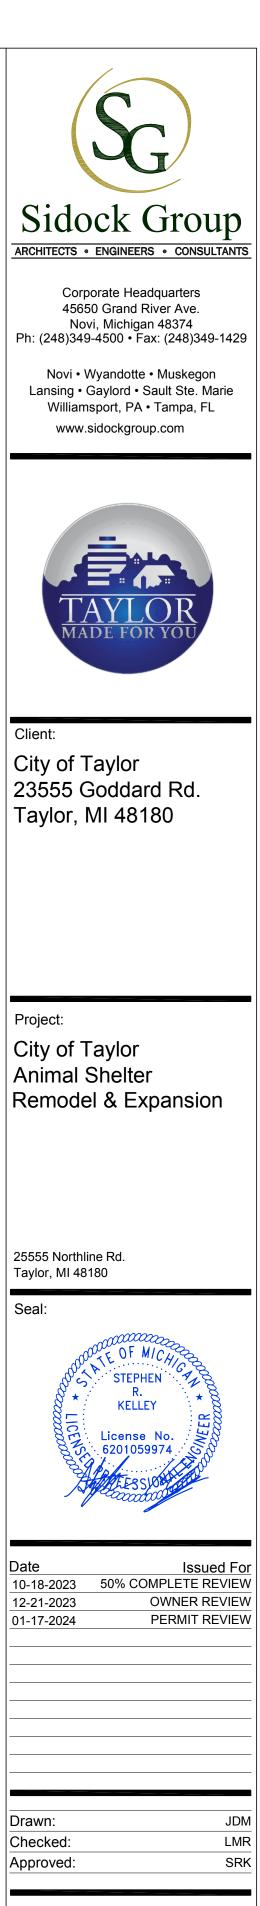
- A. REFER TO ELECTRICAL SPECIFICATIONS FOR ADDITIONAL INFORMATION.
- B. DRAWINGS ARE DIAGRAMMATIC ONLY AND INDICATE GENERAL ARRANGEMENT OF ELECTRICAL WORK. LOCATIONS ARE APPROXIMATE AND SUBJECT TO MINOR MODIFICATIONS BY THE OWNER/ENGINEER.
- C. USE #12 CONDUCTORS FOR 20A CIRCUIT HOME RUNS IF BRANCH CIRCUIT RUN IS LESS THAN 100 FEET FOR 120 VOLT. USE #10 CONDUCTORS IF BRANCH CIRCUIT RUN EXCEEDS 100 FEET FOR 120 VOLT.
- D. ALL POWER WIRING FOR MECHANICAL EQUIPMENT SHALL BE FURNISHED AND INSTALLED BY ELECTRICAL CONTRACTOR. MECHANICAL CONTRACTOR IS RESPONSIBLE FOR ALL CONTROL AND INTERLOCKING WIRING.
- E. REFER TO PARTIAL ONE-LINE DIAGRAM ON DRAWING EP-600 FOR ADDITIONAL INFORMATION.
- F. REFER TO PANEL SCHEDULE ON DRAWING EP-601 FOR ADDITIONAL INFORMATION.

NOTES

1. TYPICAL VOICE/DATA, WALL PHONES, AND DATA OUTLETS SHALL BE 4" X 4" X 2 3/4" BOX WITH SINGLE GANG MOD RING AND 1" CONDUIT WITH PULL STRING TO OPEN SPACE ABOVE NEAREST CEILING (NORMALLY IN SAME ROOM). VOICE/DATA CABLING AND TERMINATIONS SHALL BE FURNISHED AND INSTALLED BY OWNER'S IT CONTRACTOR.

SYMBOLS

- Q
 20A GFCI DUPLEX RECEPTACLE
- ₽ 20A GFCI OVERCOUNTER DUPLEX RECEPTACLE
- WP^{II} 20A GFCI WEATHERPROOF DUPLEX RECEPTACLE♥ SPECIAL USE RECEPTACLE
- VOICE / DATA OUTLET REFER TO NOTE 1
- W WALL MOUNT PHONE OUTLET REFER TO NOTE 1
- ▽ DATA OUTLET REFER TO NOTE 1




Sheet Title:

ENLARGED ELECTRICAL POWER FLOOR PLAN

Project Number: 22712.A

Sheet Number: EP-112

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- A. REFER TO ELECTRICAL SPECIFICATIONS FOR ADDITIONAL INFORMATION.
- B. DRAWINGS ARE DIAGRAMMATIC ONLY AND INDICATE GENERAL ARRANGEMENT OF ELECTRICAL WORK. LOCATIONS ARE APPROXIMATE AND SUBJECT TO MINOR MODIFICATIONS BY THE OWNER/ENGINEER.
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- D. ALL POWER WIRING FOR MECHANICAL EQUIPMENT SHALL BE FURNISHED AND INSTALLED BY ELECTRICAL CONTRACTOR. MECHANICAL CONTRACTOR IS RESPONSIBLE FOR ALL CONTROL AND INTERLOCKING WIRING.
- E. REFER TO PARTIAL ONE-LINE DIAGRAM ON DRAWING EP-600 FOR ADDITIONAL INFORMATION.
- F. REFER TO PANEL SCHEDULE ON DRAWING EP-601 FOR ADDITIONAL INFORMATION.
- 77777 SHADING INDICATES AREAS OF EXISTING G. DEVICES, EQUIPMENT, AND FEEDERS THAT ARE ∠ TO REMAIN UNLESS OTHERWISE NOTED. AREAS FEATURING NO SHADING INDICATE WORK TO BE FURNISHED AND INSTALLED UNDER THIS CONTRACT.

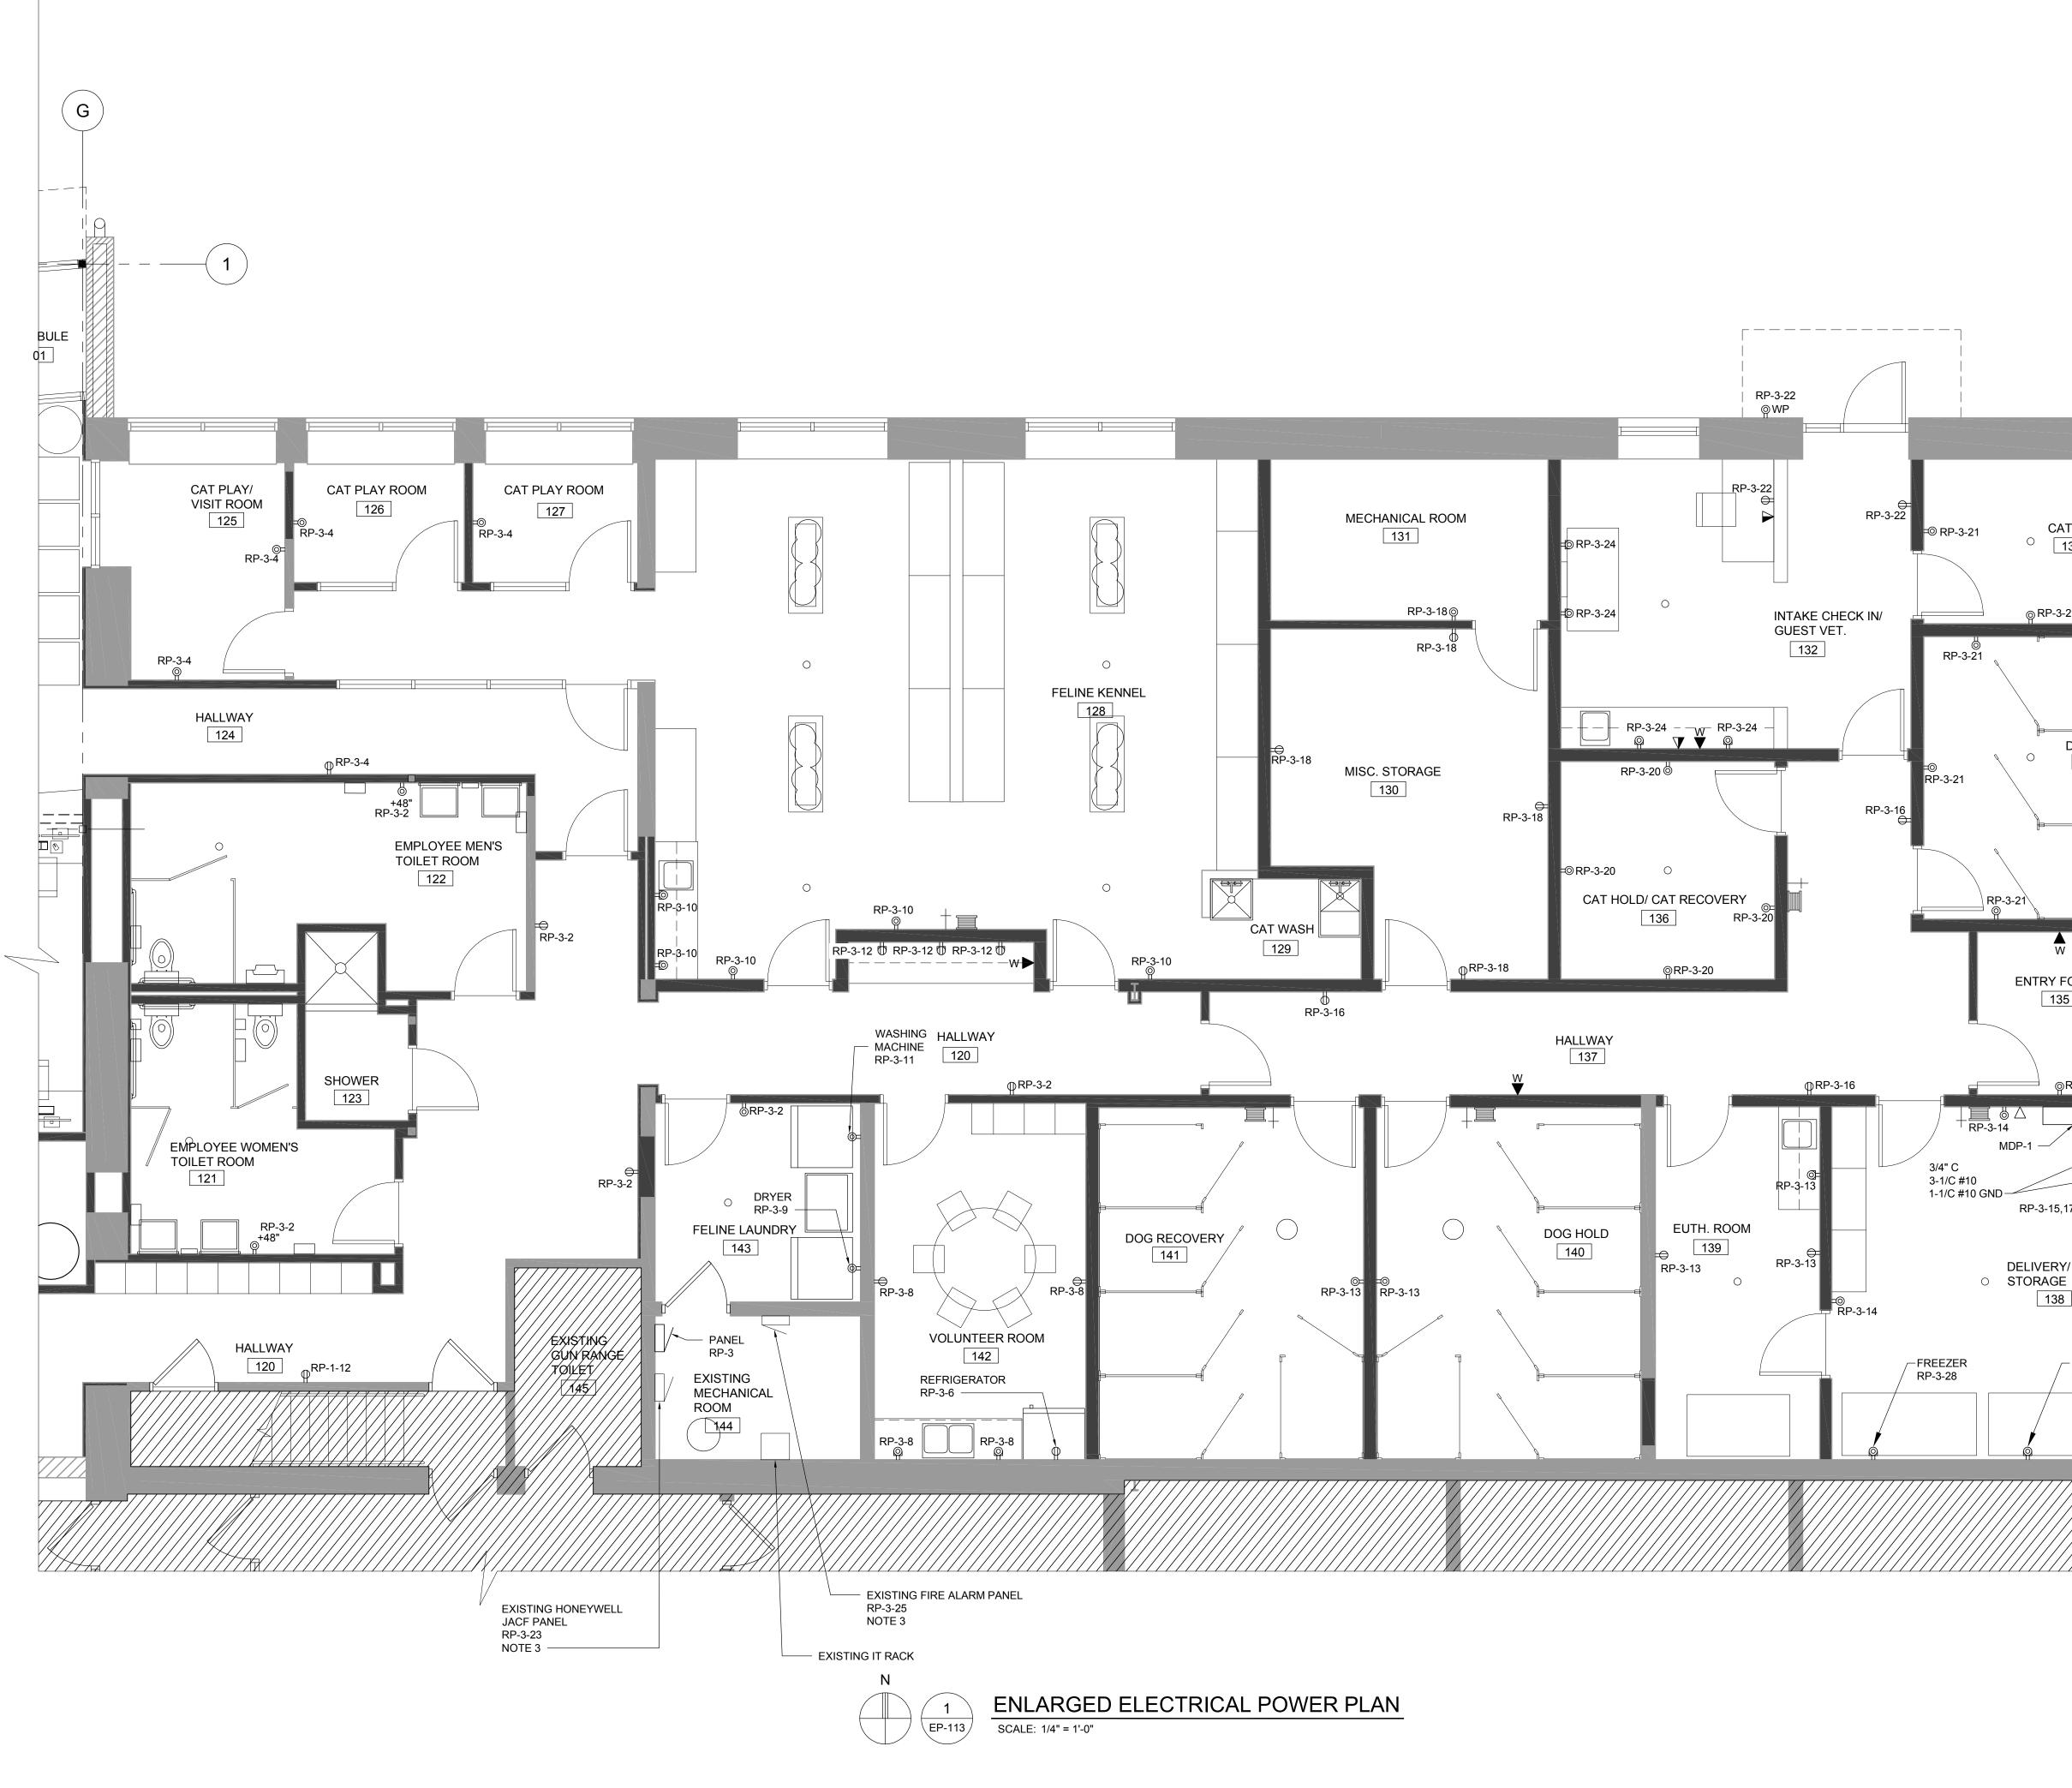NOTES

CAT ISO

DOG ISO

134

O 133

⊚ RP-3-21

RP-3-2

MDP-1

ENTRY FOYER 135

RP-3-15,17,19

DELIVERY/ PICK UP/

-FREEZER

RP-3-30

138

⊚RP-3-16


=⊚RP-3-16 WP


←OVERHEAD DOOR NOTE 2


- 1. TYPICAL VOICE/DATA AND WALL PHONE OUTLETS SHALL BE 4" X 4" X 2 3/4" BOX WITH SINGLE GANG MUD RING AND 1 " CONDUIT WITH PULL STRING TO OPEN SPACE ABOVE NEAREST CEILING (NORMALLY IN SAME ROOM). VOICE / DATA CABLING AND TERMINATIONS SHALL BE FURNISHED AND INSTALLED BY OWNERS IT CONTRACTOR.
- 2. OVERHEAD DOOR BASIS OF DESIGN: 3HP @ 208V, 3PH. OVERHEAD DOOR MOTOR SHALL INCLUDE CONTROLLER AND CONTROL PUSH BUTTONS. CONTRACTOR SHALL FURNISH AND INSTALL A 30A DISCONNECT SWITCH (FUSED OR NON-FUSED PER OVERHEAD DOOR MANUFACTURER REQUIREMENTS) ADJACENT TO OVERHEAD DOOR CONTROLLER. FURNISH AND INSTALL CONDUIT AND WIRING TO LINE SIDE OF OVERHEAD DOOR CONTROLLER. COORDINATE ALL WORK WITH OVERHEAD DOOR INSTALLER.
- 3. RE-FEED EXISTING PANEL TO NEW PANEL RP-3 WITH 2-1/C #12, 1 #12 GND IN 3/4" CONDUIT.

SYMBOLS

- P 20A GFCI OVERCOUNTER DUPLEX RECEPTACLE
- © 20A GFCI WEATHERPROOF DUPLEX RECEPTACLE
- VOICE / DATA OUTLET REFER TO NOTE 1
- WALL MOUNT PHONE OUTLET REFER TO NOTE 1

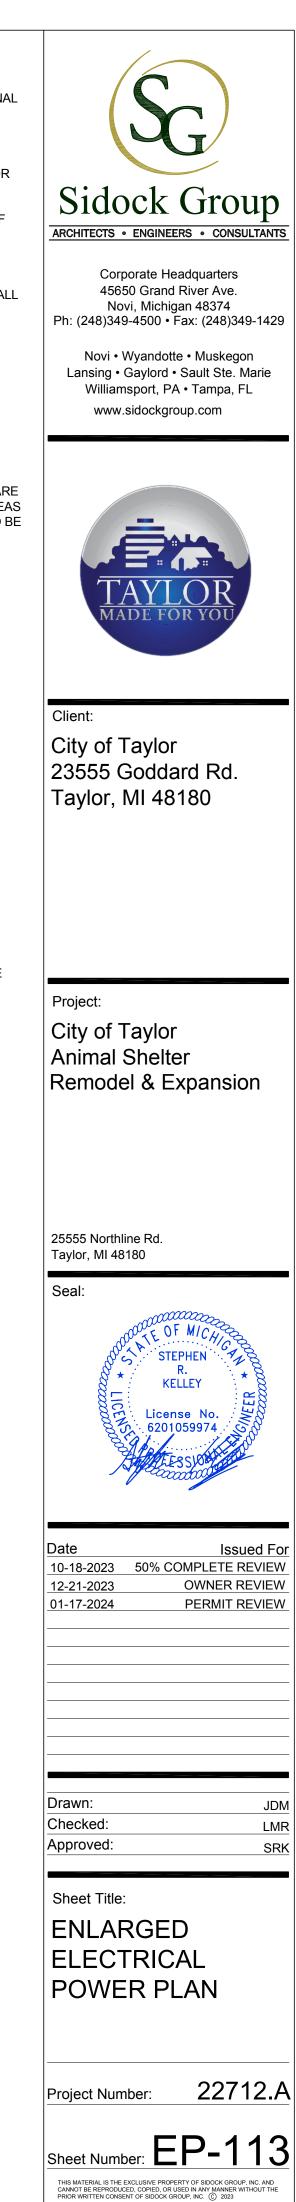

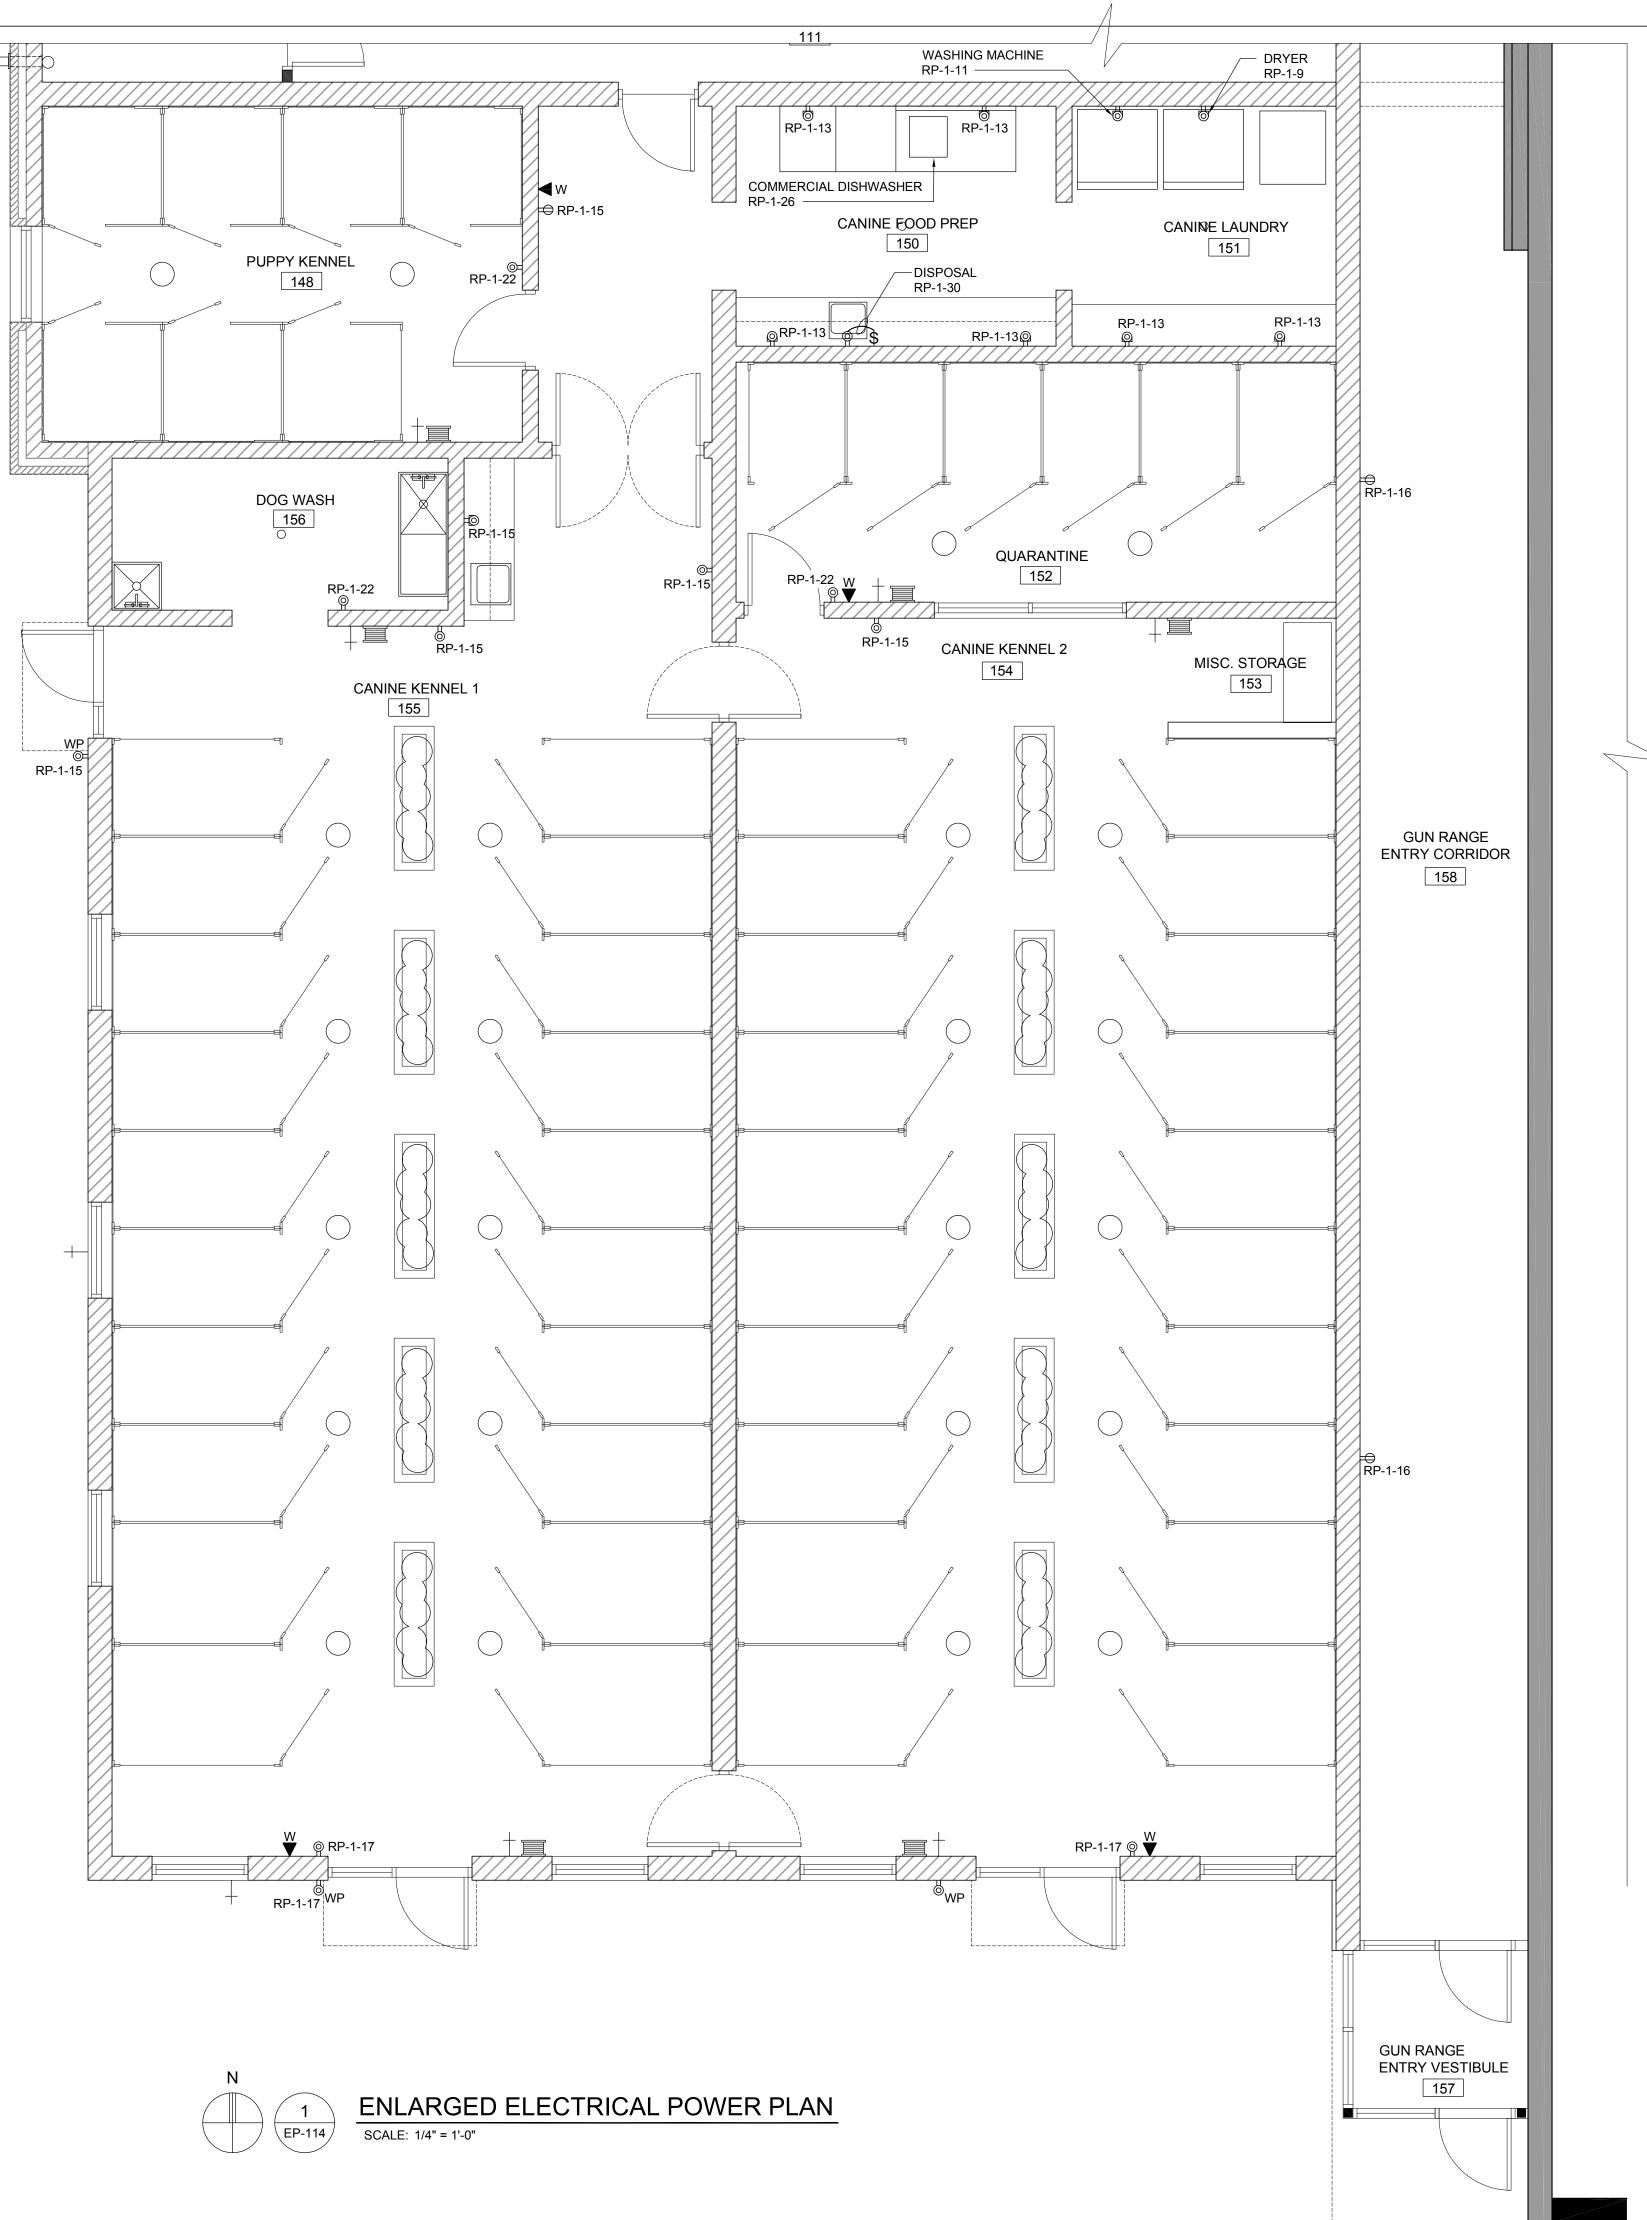


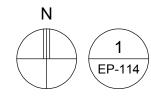

- A. REFER TO ELECTRICAL SPECIFICATIONS FOR ADDITIONAL INFORMATION.
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- D. ALL POWER WIRING FOR MECHANICAL EQUIPMENT SHALL BE FURNISHED AND INSTALLED BY ELECTRICAL CONTRACTOR. MECHANICAL CONTRACTOR IS RESPONSIBLE FOR ALL CONTROL AND INTERLOCKING WIRING.
- E. REFER TO PARTIAL ONE-LINE DIAGRAM ON DRAWING EP-600 FOR ADDITIONAL INFORMATION.
- F. REFER TO PANEL SCHEDULE ON ON DRAWING EP-601 FOR ADDITIONAL INFORMATION.

NOTES

1. TYPICAL WALL PHONE OUTLETS SHALL BE 4" X 4" X 2 3/4" BOX WITH SINGLE GANG MUD RING AND 1" CONDUIT WITH PULL STRING TO OPEN SPACE ABOVE NEAREST CEILING (NORMALLY IN SAME ROOM). VOICE/DATA CABLING AND TERMINATIONS SHALL BE FURNISHED AND INSTALLED BY OWNER'S IT CONTRACTOR.

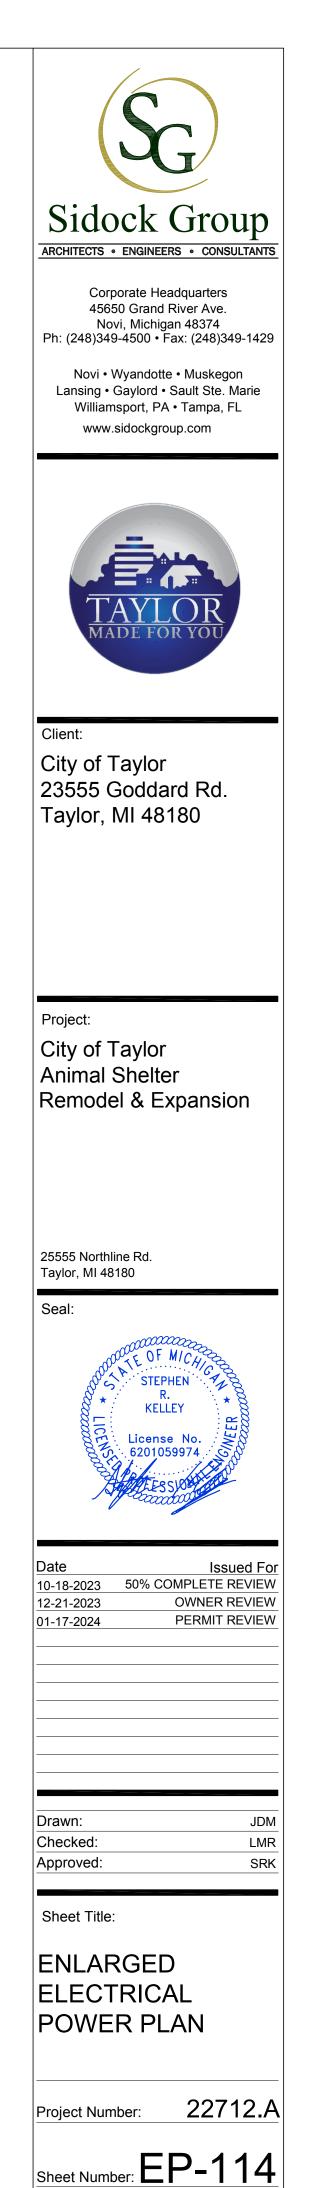


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SYMBOLS

- Φ 20A DUPLEX RECEPTACLE
- P 20A GFCI OVERCOUNTER DUPLEX RECEPTACLE

WP 20A GFCI WEATHERPROOF DUPLEX RECEPTACLE


WALL MOUNT PHONE OUTLET - REFER TO NOTE 1

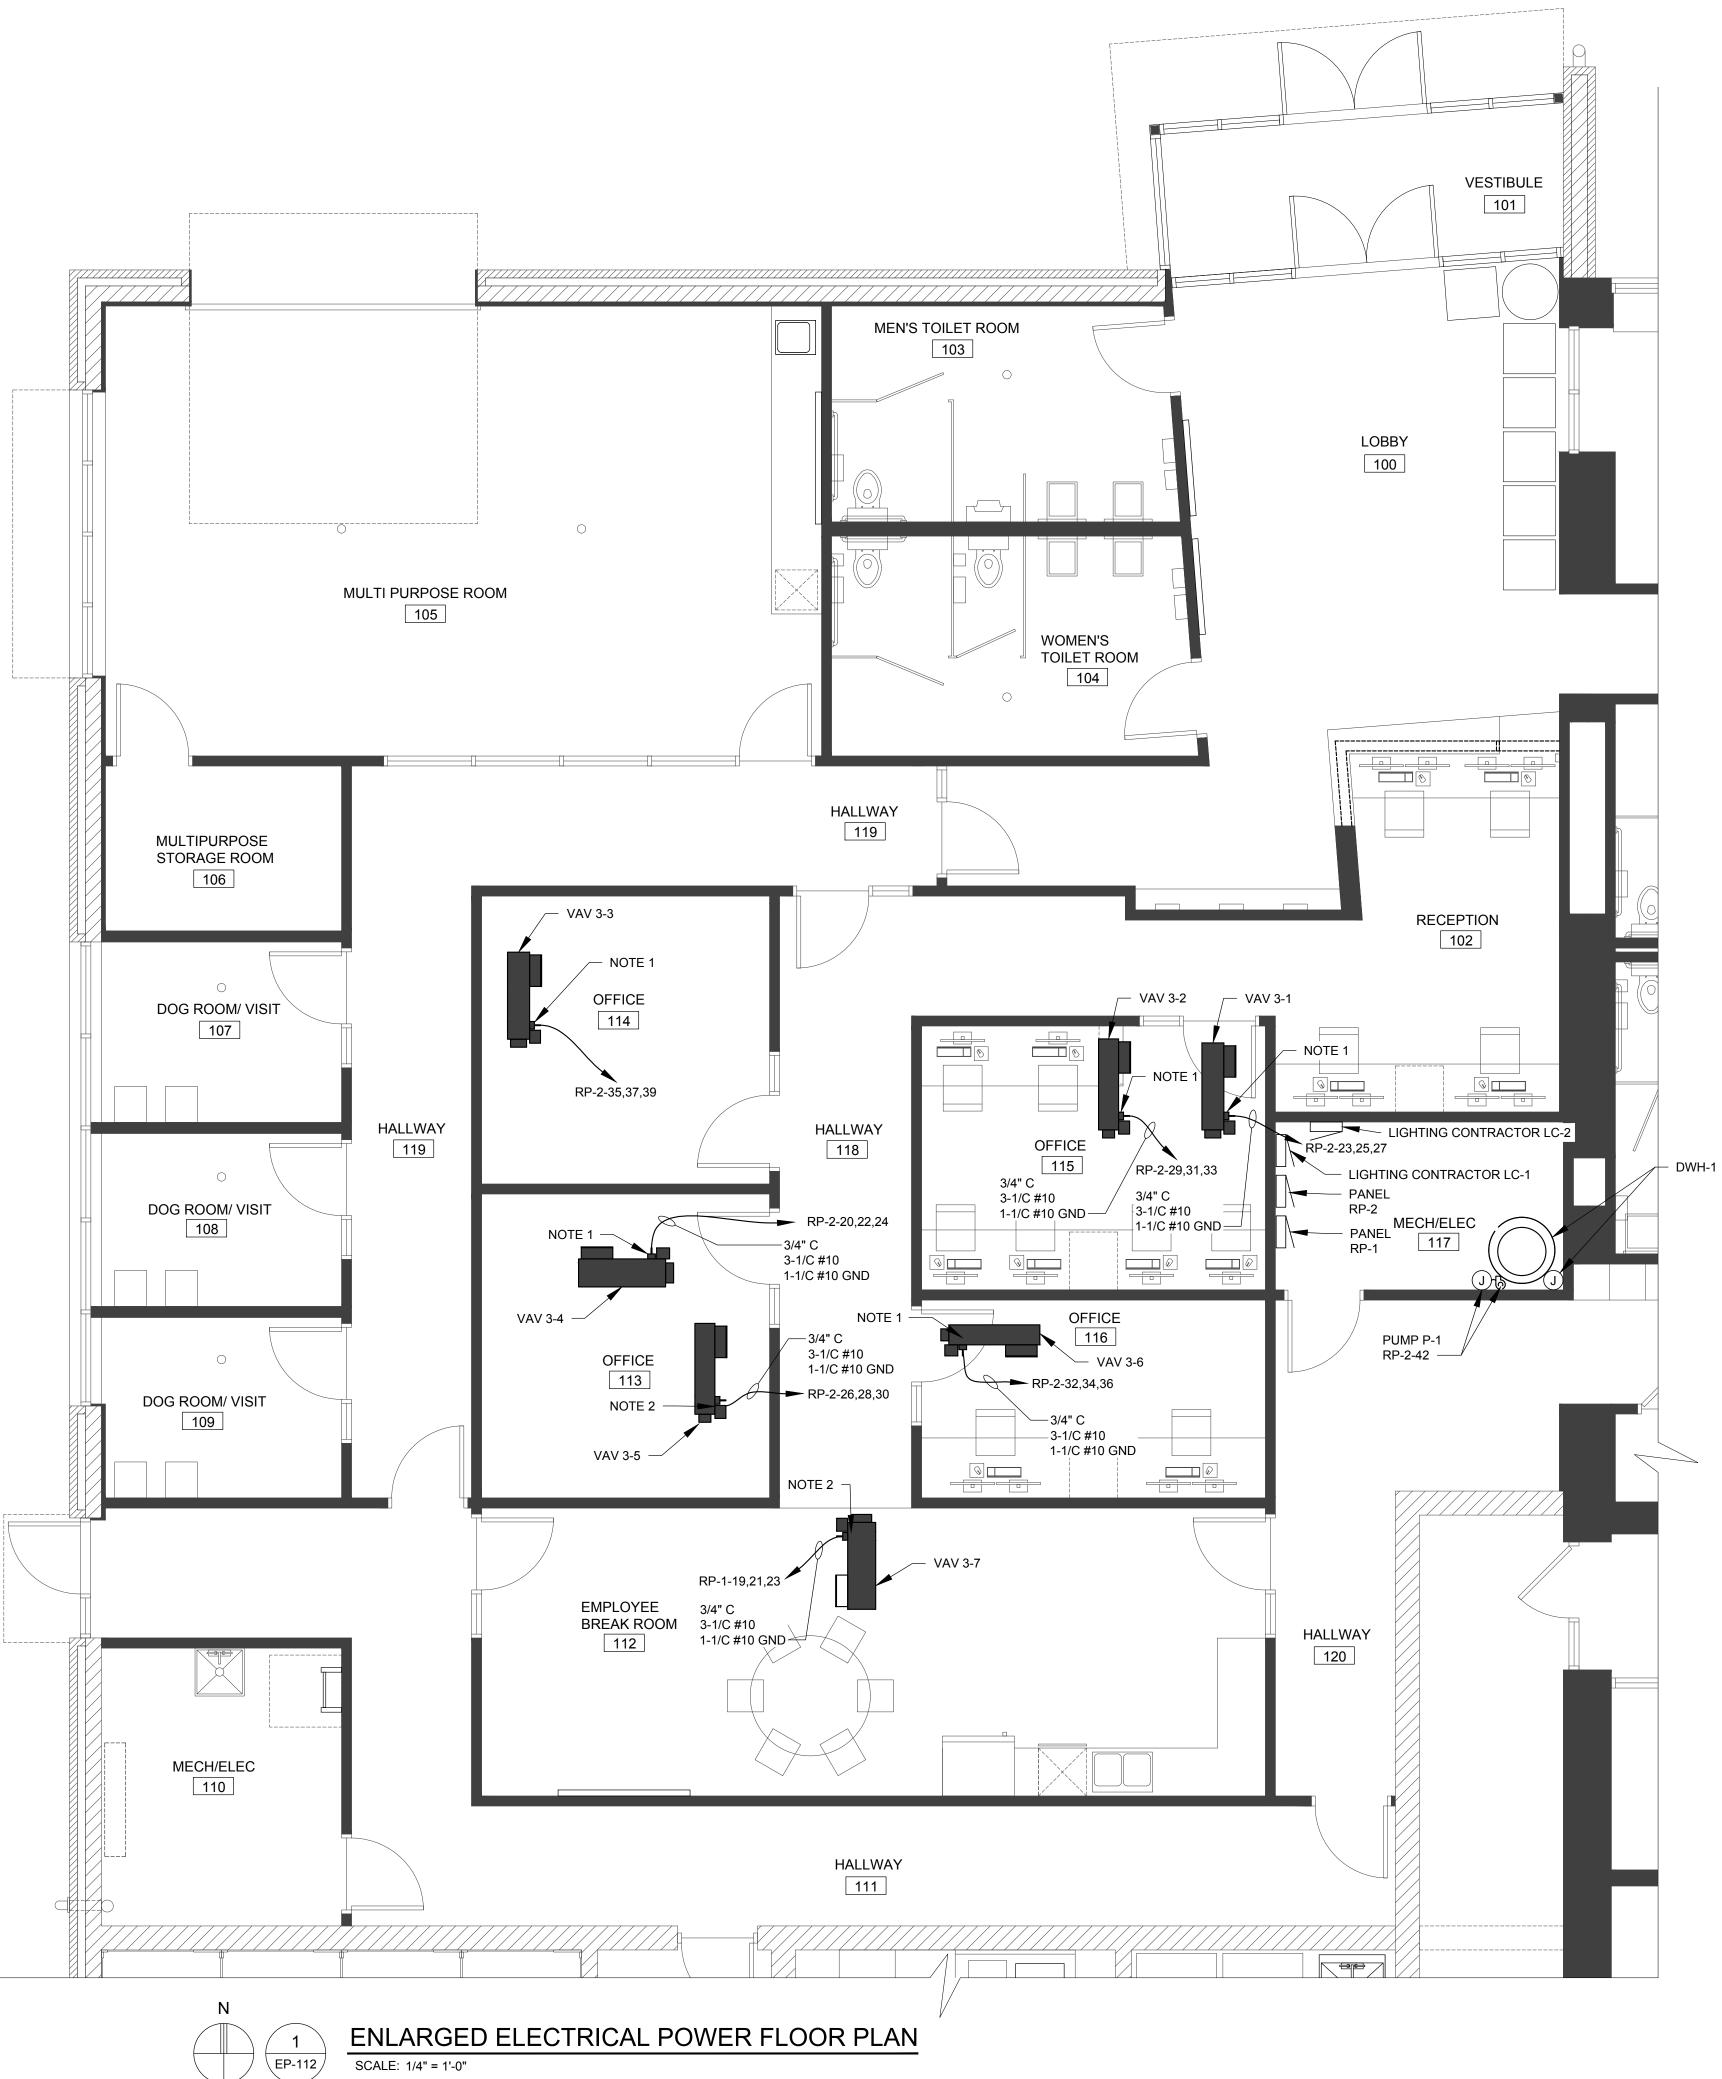

- A. REFER TO ELECTRICAL SPECIFICATIONS FOR ADDITIONAL INFORMATION.
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- E. REFER TO PARTIAL ONE-LINE DIAGRAM ON DRAWING EP-600 FOR ADDITIONAL INFORMATION.
- F. REFER TO PANEL SCHEDULE ON DRAWING EP-601 FOR ADDITIONAL INFORMATION.

NOTES

1. DISCONNECT SWITCH SUPPLIED WITH UNIT.

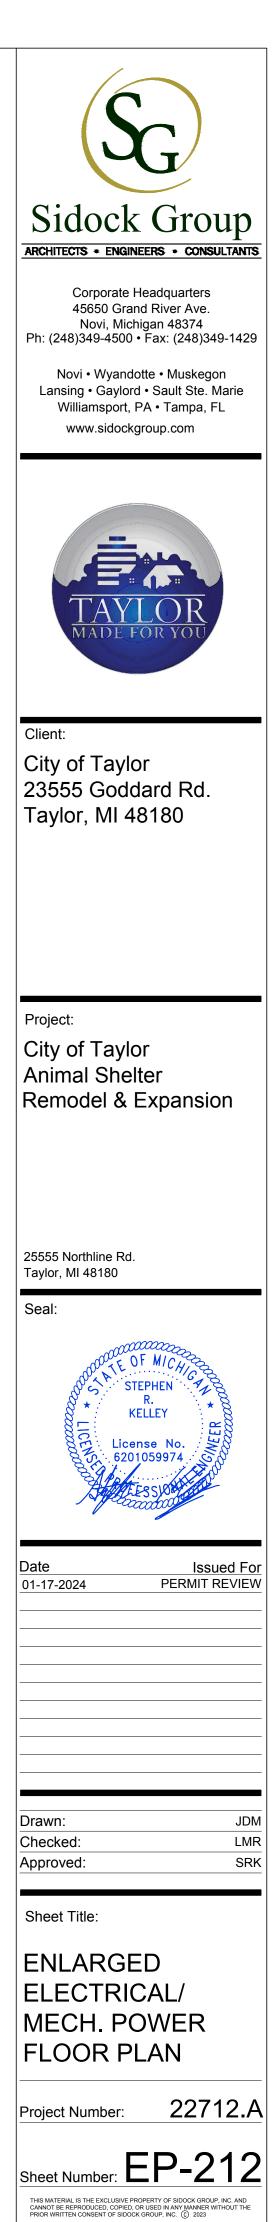




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- E. REFER TO PARTIAL ONE-LINE DIAGRAM ON DRAWING EP-600 FOR ADDITIONAL INFORMATION.
- F. REFER TO PANEL SCHEDULE ON DRAWING EP-601 FOR ADDITIONAL INFORMATION.
- G. **[7777]** SHADING INDICATES AREAS OF EXISTING DEVICES, EQUIPMENT, AND FEEDERS THAT ARE TO REMAIN UNLESS OTHERWISE NOTED. AREAS FEATURING NO SHADING INDICATE WORK TO BE FURNISHED AND INSTALLED UNDER THIS CONTRACT.




- 1. DISCONNECT SWITCH SUPPLIED WITH UNIT.
- 2. FURNISH AND INSTALL A SQUARE D CLASS 2510 TYPE KG1A MOTOR RATED MANUAL SWITCH WITH A NEMA 12 ENCLOSURE FOR UNIT. COORDINATE LOCATION WITH MECHANICAL CONTRACTOR.

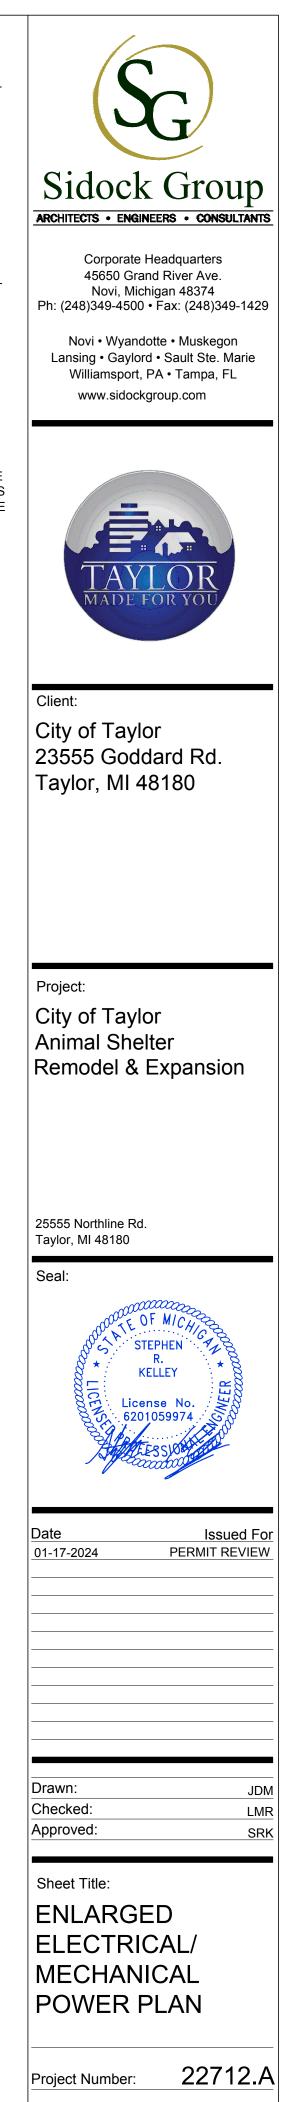

Sheet Number: EP-213

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- E. REFER TO PARTIAL ONE-LINE DIAGRAM ON THIS DRAWING FOR ADDITIONAL INFORMATION.
- F. REFER TO PANEL SCHEDULE ON THIS DRAWING FOR ADDITIONAL INFORMATION.

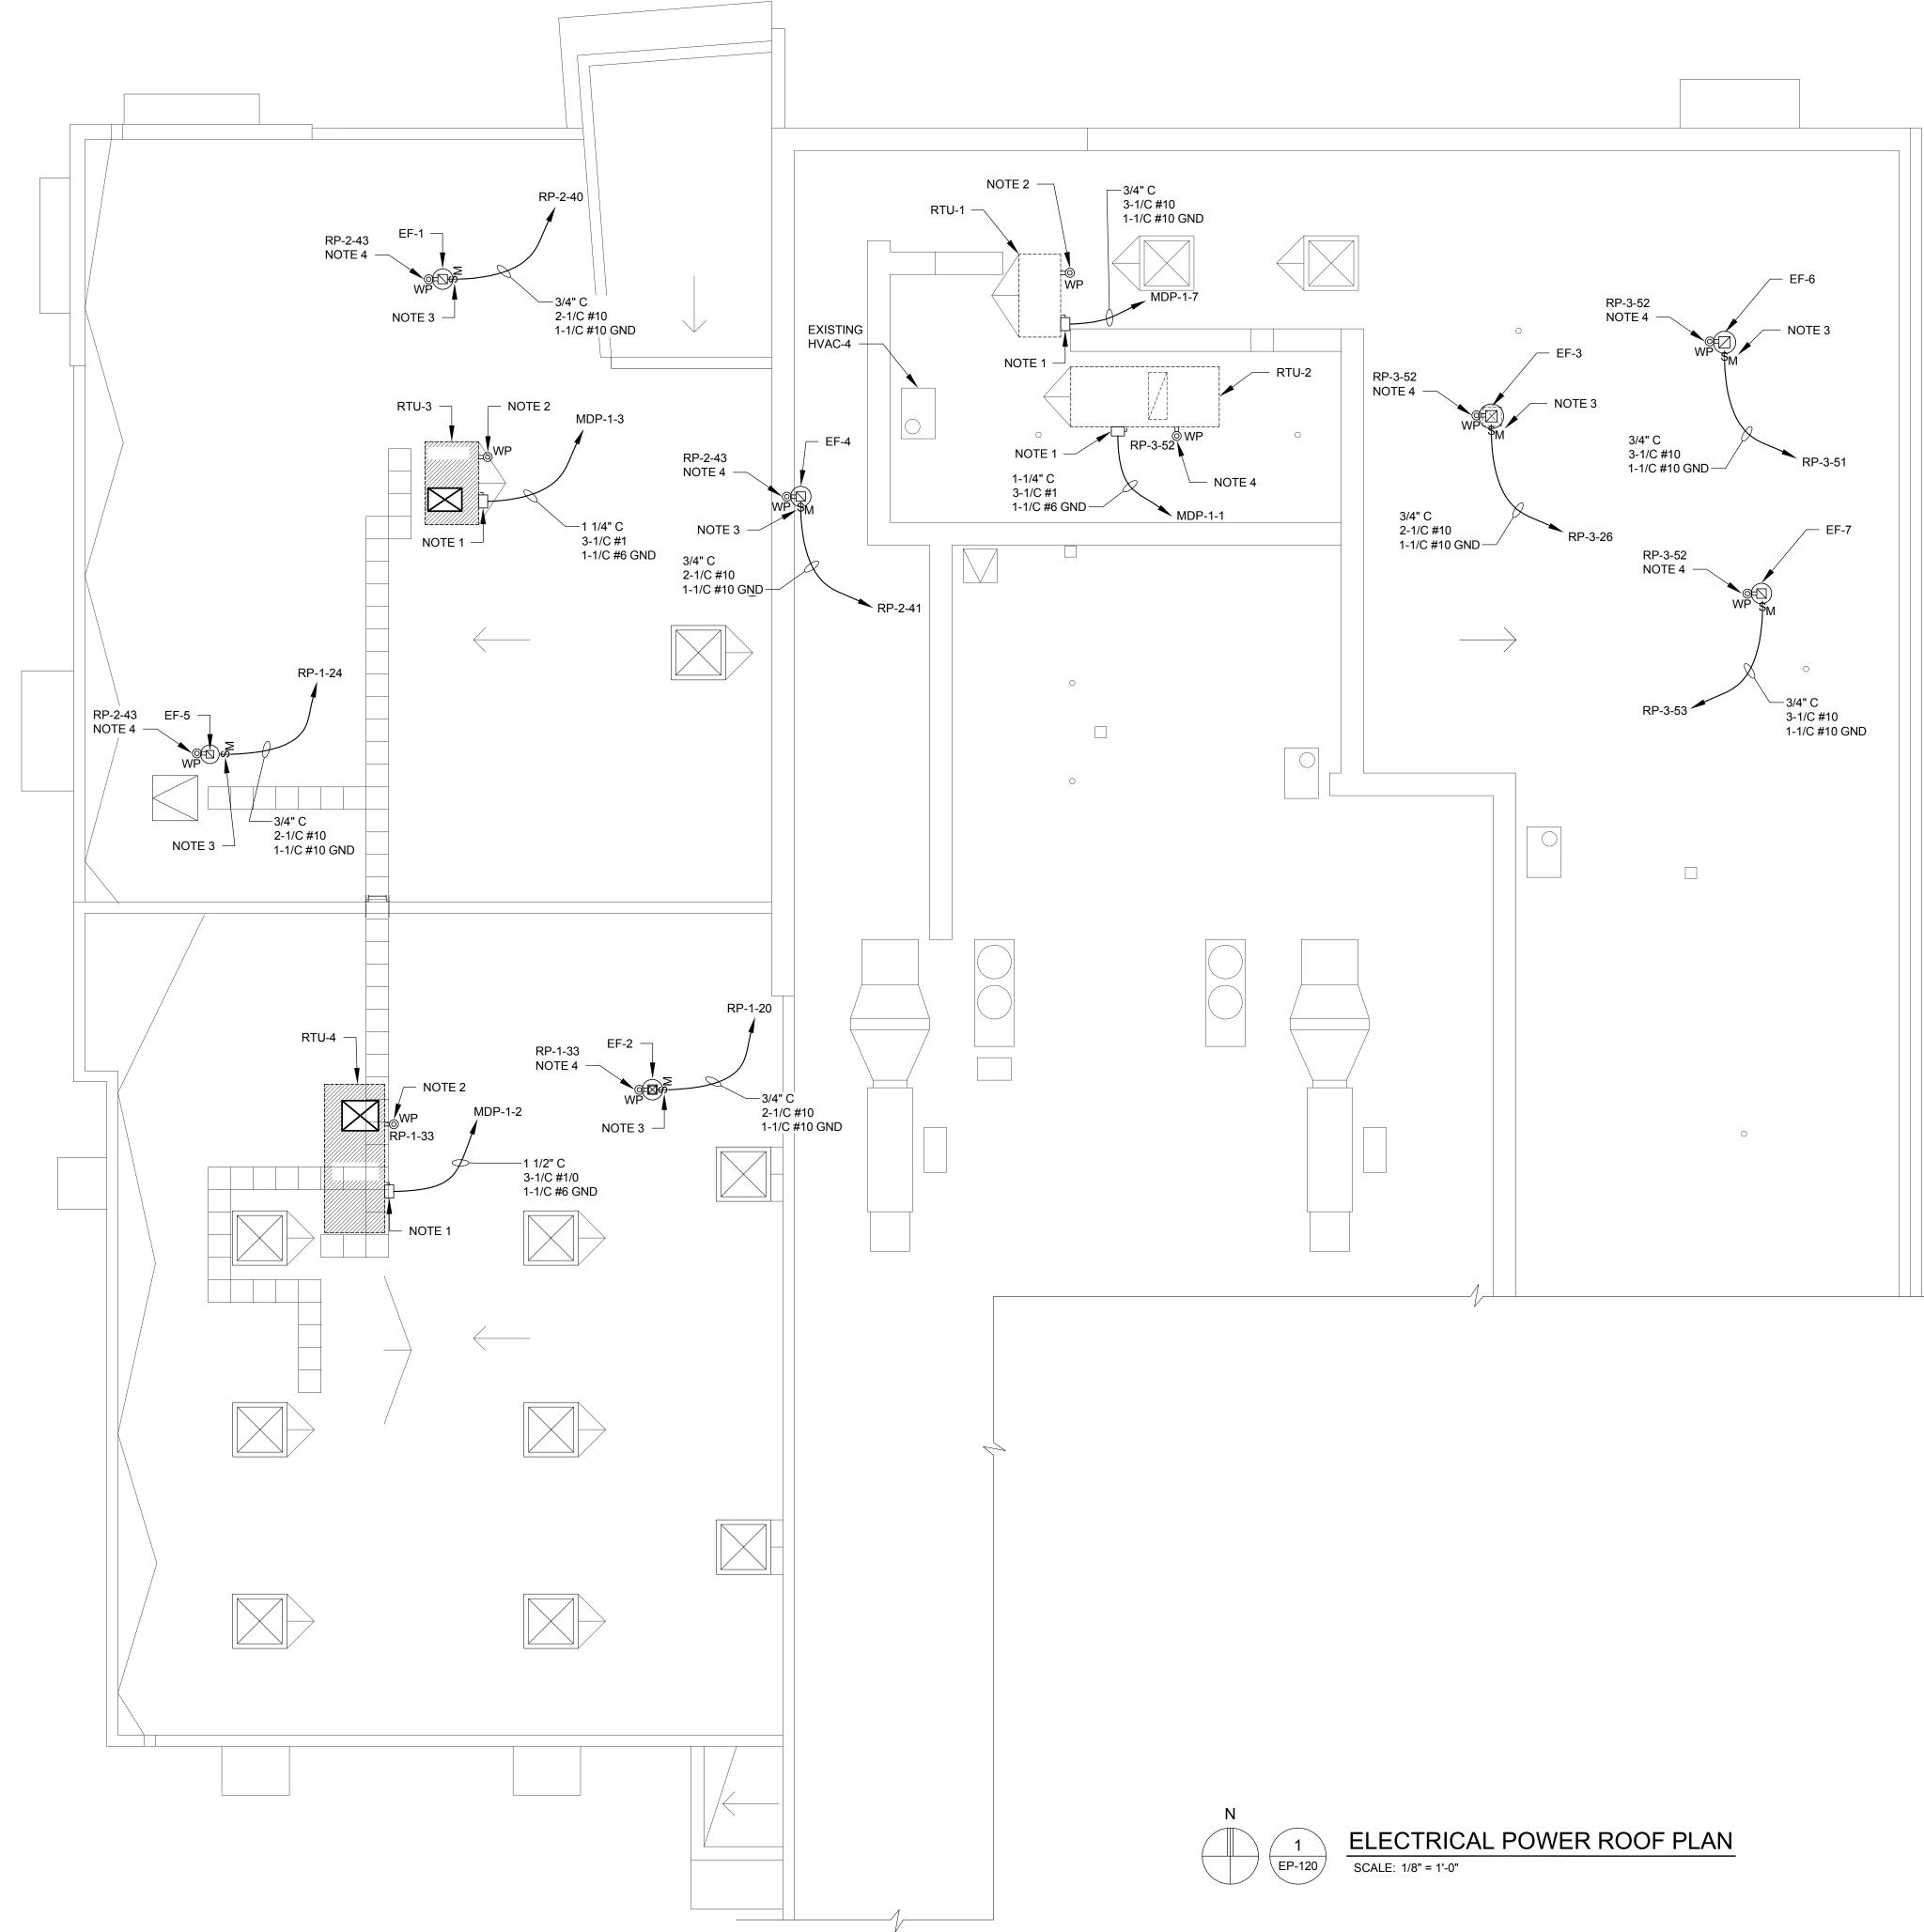NOTES

- 1. NON-FUSED DISCONNECT SWITCH SUPPLIED WITH UNIT.
- 2. 120V MAINTENANCE RECEPTACLE PROVIDED AND FED FROM UNIT.
- 3. MOTOR RATED TOGGLE DISCONNECT SWITCH SUPPLIED WITH UNIT.
- 4. FURNISH AND INSTALL A 20A, 1P, 115V CONVENIENCE OUTLET FOR UNIT PER NEC 210.63.

SYMBOLS

- \$M MOTOR RATED TOGGLE SWITCH
- DISCONNECT SWITCH
- **PWP** 20A GFCI WEATHERPROOF RECEPTACLE





Client:

City of Taylor 23555 Goddard Rd. Taylor, MI 48180

Project:

City of Taylor Animal Shelter Remodel & Expansion

25555 Northline Rd. Taylor, MI 48180

Seal:



Issued For Date 10-18-2023 50% COMPLETE REVIEW 12-21-2023 01-17-2024 OWNER REVIEW PERMIT REVIEW

Drawn:	JDM
Checked:	LMR
Approved:	SRK


Sheet Title:

ELECTRICAL POWER ROOF PLAN


Project Number: 22712.A



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INSTALLATION ELECTRICAL ONE-LINE DIAGRAM SCALE: NTS

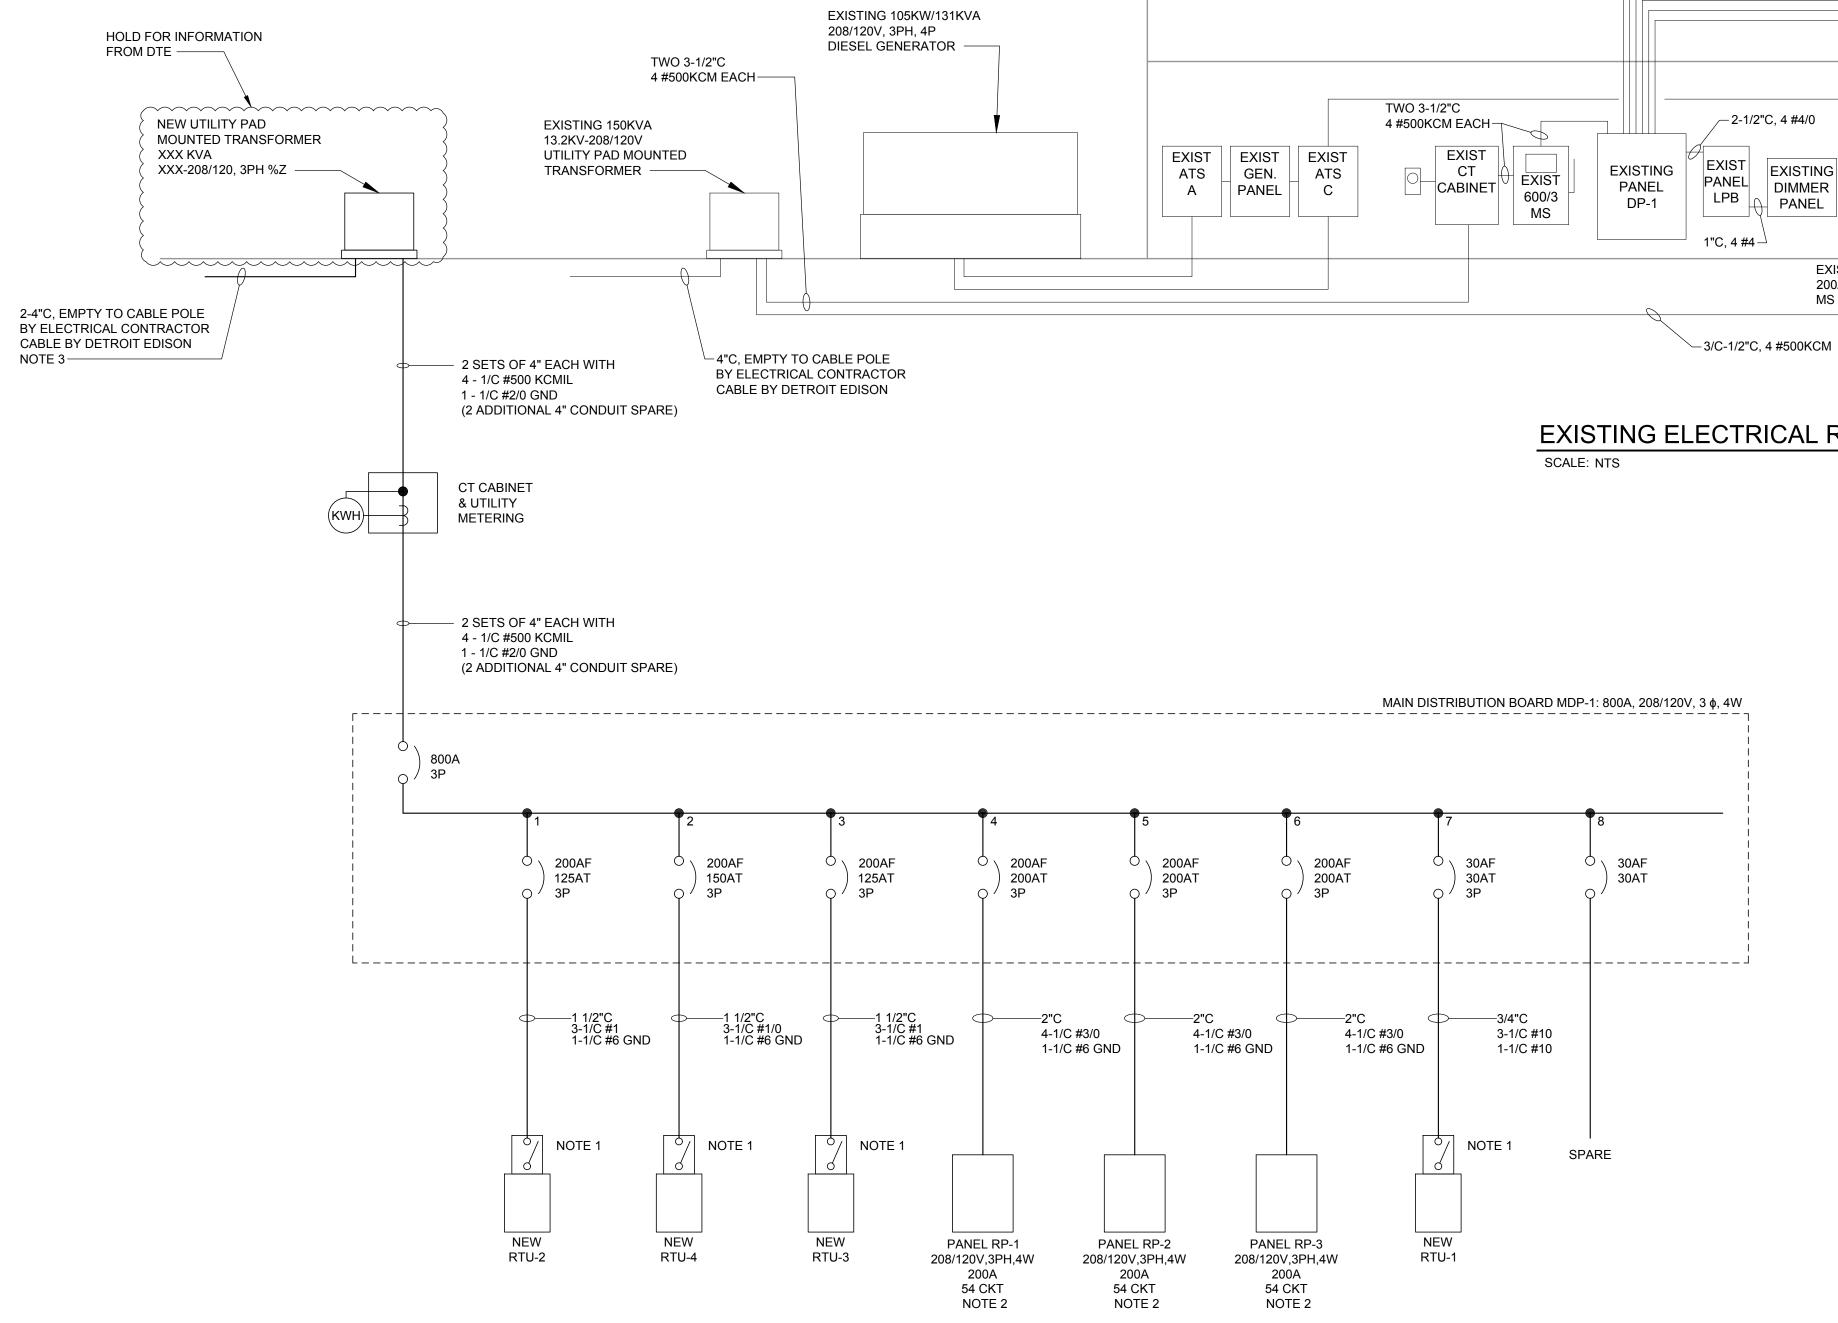

EXISTING ELECTRICAL RISER DIAGRAM

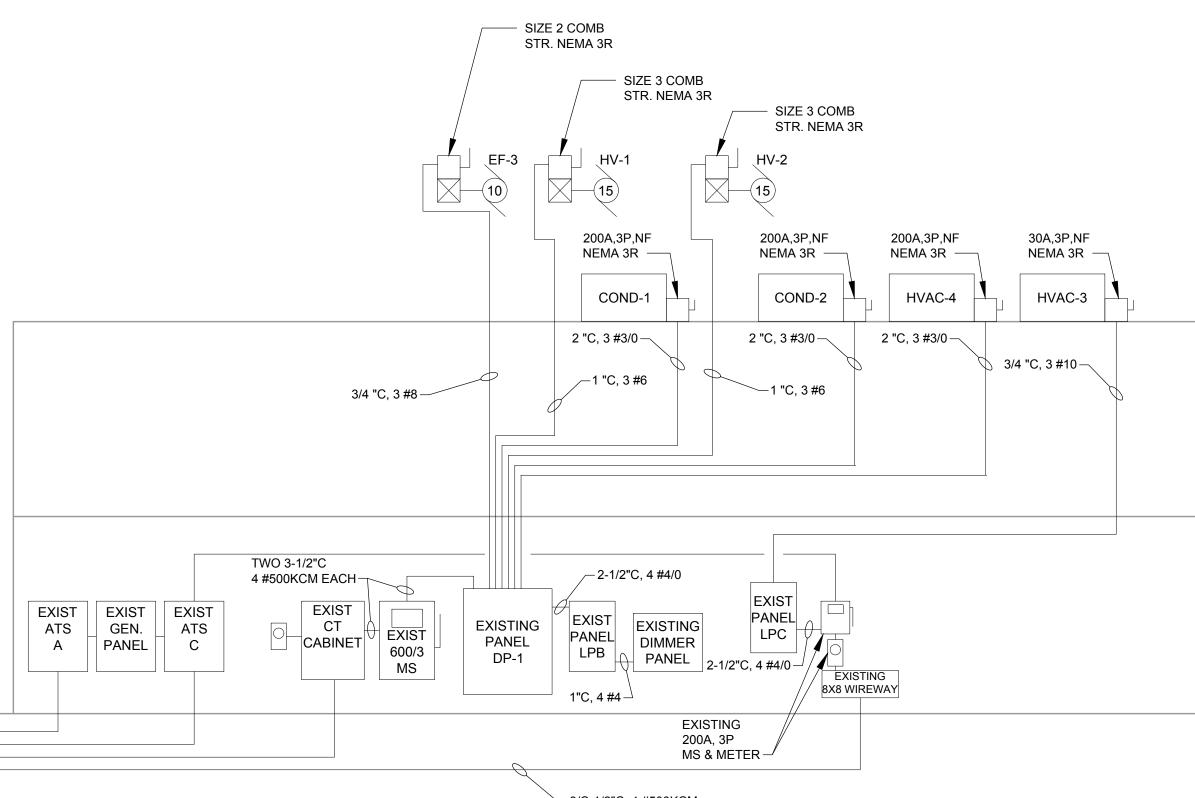

GENERAL NOTES:

- A. REFER TO ELECTRICAL SPECIFICATIONS FOR ADDITIONAL INFORMATION.
- B. REFER TO ELECTRICAL GROUNDING DETAILS ON SHEET EP-601 FOR ADDITIONAL INFORMATION.
- C. REFER TO PANEL SCHEDULES ON DRAWING EP-602 FOR ADDITIONAL INFORMATION.

NOTES:

- 1. NEMA 3R DISCONNECT SWITCH SUPPLIED WITH UNIT.
- 2. FURNISH AND INSTALL A 200A MCB, 208/120V, 3PH, 4W PANELBOARD, SQUARE D INTERIOR NQ454L2C WITH BOX (NEMA 1) CAT #MH50 AND NC50S FRONT; PK27GTACU EQUIPMENT GROUND BAR AND NQN2CU NEUTRAL BAR OR EQUIVALENT BY EATON.
- 3. CONTRACTOR SHALL COORDINATE WITH LOCAL ELECTRICAL SERVICE UTILITY PROVIDER FOR EXACT LOCATION OF POINT OF SERVICE TIE IN.

2ND FLOOR

ROOF

1ST FLOOR

Ē IADE FOR Y Client:

City of Taylor 23555 Goddard Rd. Taylor, MI 48180

Project:

City of Taylor Animal Shelter Remodel & Expansion

25555 Northlii Taylor, MI 48′	
Seal:	COF MICAN STEPHEN R. KELLEY License No. 6201059974 SOUTHERS WITH SOUTHERS
Date 10-18-2023 12-21-2023 01-17-2024	Issued For 50% COMPLETE REVIEW OWNER REVIEW PERMIT REVIEW
Drawn: Checked: Approved:	JDM LMR SRK
Sheet Title:	RICAL

ELECIKICAL ONE-LINE DIAGRAM


Project Number: 22712.A

Sheet Number: EP-600


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TELECOMMUNICATIONS MAIN GROUNDING BUSBAR, SEE NOTES 2, 3 —



MAIN ELECTRICAL SERVICE ENTRANCE GROUND BUSBAR DETAIL SCALE: N.T.S.

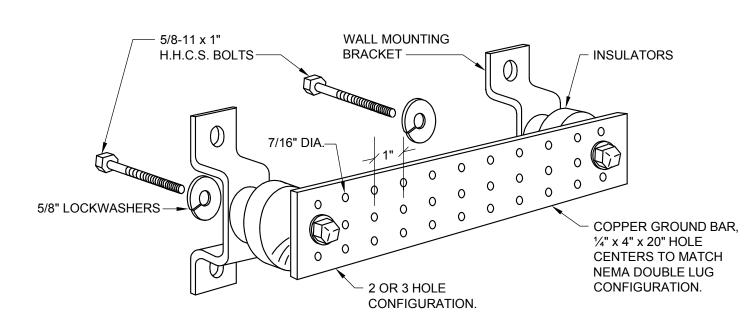

ELECTRICAL SERVICE GROUNDING DETAIL WITH GROUNDING BUSBARS

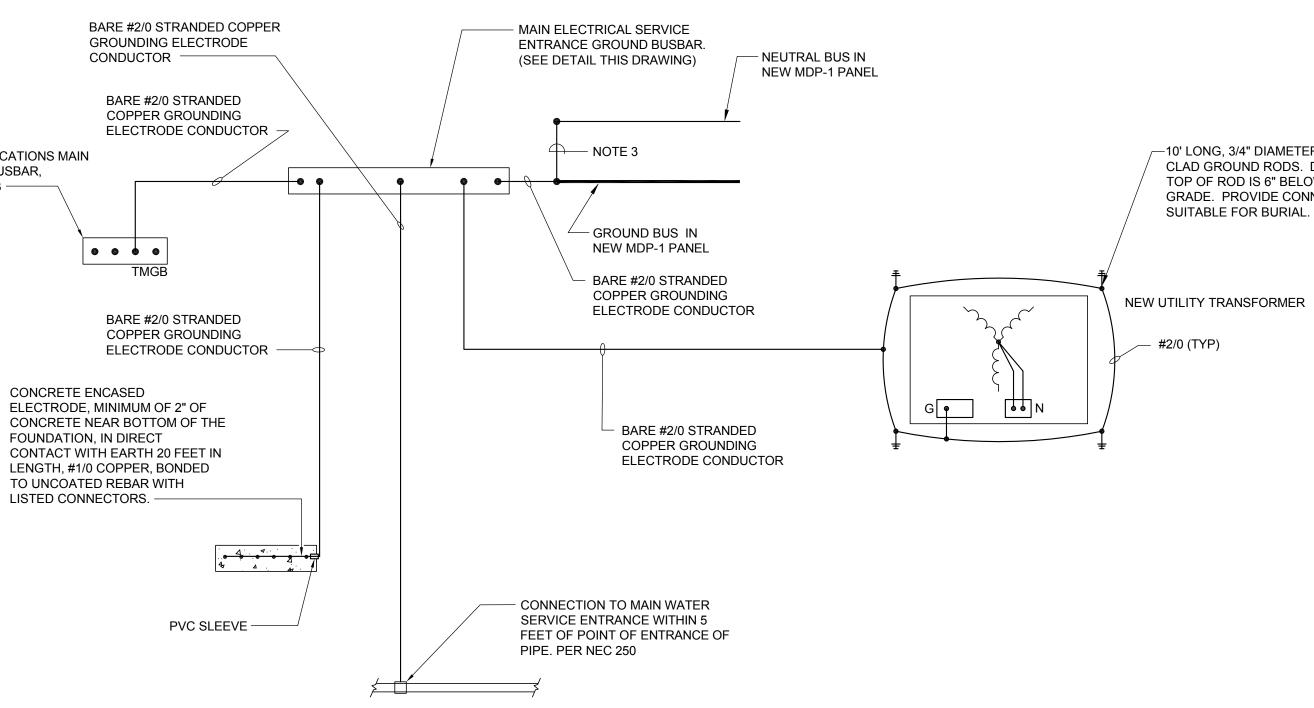SCALE: N.T.S.

NOTES:

- 1. TEST BUILDING GROUNDING SYSTEM IN ACCORDANCE WITH NETA STANDARDS.
- 2. PROVIDE GROUNDING OF TELECOMMUNICATIONS EQUIPMENT TO TELECOMMUNICATION GROUND BUSBAR (TMGB) PER TELECOMMUNICATION VENDORS DIRECTION.
- 3. TELECOMMUNICATIONS MAIN GROUNDING BUSBAR (TMGB).
- 4. ESTABLISH THE NEUTRAL TO GROUND CONNECTION INSIDE MDP-1

GENERAL NOTES:

INFORMATION.

- A. REFER TO ELECTRICAL SPECIFICATIONS FOR ADDITIONAL INFORMATION.
- B. REFER TO ONE-LINE DIAGRAM ON DRAWING EP-600 FOR ADDITIONAL
- C. ELECTRICAL CONTRACTOR SHALL FURNISH AND INSTALL ALL GROUNDING AND BONDING AS REQUIRED PER THE NATIONAL ELECTRIC CODE (N.E.C.) ARTICLE 250.

-10' LONG, 3/4" DIAMETER COPPER CLAD GROUND RODS. DRIVE SO TOP OF ROD IS 6" BELOW FINISHED GRADE. PROVIDE CONNECTION SUITABLE FOR BURIAL. (TYP. FOR 4)

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Ph: (24	Corporate 45650 Gra Novi, Mic 18)349-4500	and Rive	r Ave. 3374	142
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Taylor,	MI 48180			
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Date 12-21-2 01-17-2			Issue /NER RE RMIT RE	VIE
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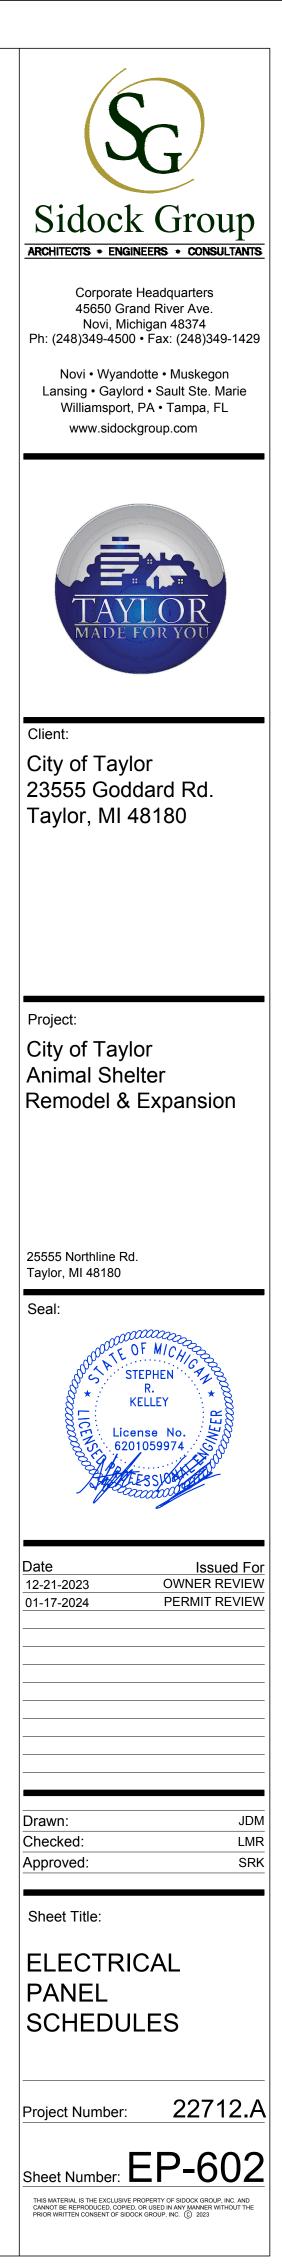
PANEL DESIGNATION: PANEL MDP-1 PANEL LOCATION: REFER TO PLAN DRAWINGS FED FROM: REFER TO ONE-LINE DIAGRAM FEEDER SIZE: REFER TO ONE-LINE DIAGRAM								SING: DBUS: TING:	800A BR 800A STANDA SURFAC 100%	RD		P-P VOLTAGE: 208 P-N VOLTAGE: 120 PHASE: 3 WIRE: 4								
Remarks	Light Load	RECEPT LOAD	CONT LOAD	nonC LOAD	IN TER. USE		OC PROT FRAME	ССТ	ØØ AB	ø с	OC PROT FRAME	OC PROT TRIP	IN TER. USE	nonC LOAD	CONT LOAD	RECEPT LOAD	LIGHT LOAD	Remarks		
RTU-2				13931 13931 13931		125A	200A	1	X X	2 X	200A	150A		15612 15612 15612				RTU-4		
RTU-3				13931 13931 13931		125A	200A	3	X X	4 X	200A	200A	1840 4400 5340	1400 0 25	2084 2084 2084	3060 3060 1620	1082 954 602	PANEL RP-1		
PANEL RP-2	827 605 538	3060 3240 2700	8543 8543 8543	0 37 30	500 500 550	200A	200A	5	X X	6 X	200A	200A	3421 4661	13086 11286 0	500 1000	4860 2160 0	603 500 0	PANEL RP-3		
RTU-1				2642 2642 2642		30A	30A	7	X X	8 X	30A	30A						SPARE		
	CONNECTED LOAD														DEMAN			I		
LOAD DESCRIPTION	ØA	ØB	ØC	TOTAL	1				FACT	OR				ØA	ØB	ØC	TOTAL	1		
LIGHTING LOAD (VOLT-AMPS)	2512	2059	1140	5710					1.00	-				2512	2059	1140	5710			
180VA RECEPTACLE LOAD (VOLT-AMPS)	10980 AMOU	8460 NT OVER	4320 10kVA	23760 13760						10kVA) 0kVA)				4621 3179	3561 2450	1818 1251	10000 6880	RECEPTACLE DEMAND FACTOR PER ARTICLE 220.44 OF THE NATION AL ELECTRICAL CODE.		
CONTINUOUS LOAD (VOLT-AMPS)	11127	11627	10627	33381	1				1.2					13909	14534	13284	41726	1		
NON-CONTINUOUS LOAD (VOLT-AMPS)	60602	57439	46171	164212] [1.00					60602	57439	46171	164212			
	5761	9561	5890	21212		1.00								5761	9561	5890	21212	UDANEL MOD 1		
	90.98	89.15	68.15	248.27	-						RECEPT			90.58	89.60	69.55	249.74	"PANEL MDP-1"		
TOTAL AMPACITY (AMPS) MINIMUM FEEDER SIZING (AMPS)	757.6 808.8	742.3 788.4	567.5 600.9	689.1 732.8			(<=10kV < P				ER LOAD 5.2>			754.3 798.1	746.1 788.1	579.2 613.0	693.2 733.1			

PANEL LOCATION: FED FROM:	PANEL RP-1 REFER TO PLAN DRAWINGS REFER TO ONE-LINE DIAGRAM REFER TO ONE-LINE DIAGRAM	MAIN: 200A BREAKER Bussing: 225A Ground Bus: Standard Mounting: Surface Neutral: 100%	P-P VOLTAGE: 2 P-N VOLTAGE: 1 PHASE: 3 WIRE: 4	20		REFER TO P						P-P VOLTAGE: P-N VOLTAGE: PHASE: WIRE: 2	120 3
Remarks	LIGHT RECEPT CONT nonC LOAD LOAD LOAD LOAD	INTER. OC CCT Ø Ø Ø CCT OC INTER. USE PROT A B C PROT USE	. nonC CONT RECEPT LIGHT LOAD LOAD LOAD LOAD	R emarks	Remarks	LIGHT RE	CEPT CONT nor OAD LOAD LOA	AD USE PROT		CCT OC IN PROT U	ITER. nonC CON USE LOAD LOA	IT RECEPT LIGHT D LOAD LOAD	Remarks
LIGHTING (110,111,112,120)	480	20A 1 X 2 20A	800	REFRIGERATOR (112)	LIGHTING (121,122,123,124,125,126,127,128)	493		20A	1 X			1080	RECEPTACLES (120,121,122,123,143)
LIGHTING (148,149,150,151,152,155,156)	816	20A 3 X 4 20A 1800		DISHWASHER (112)	LIGHTING (128,129,120,143,142,141)	603		20A	3 X	4 20A		900	RECEPTACLES (124,125,126,127)
LIGHTING (155)	602	20A 5 X 6 20A 1000		MICROWAVE (112)	LIGHTING (137,138,139,140)	500		20A		6 20A	800		REFRIGERATOR (142)
LIGHTING (154)	602	20A 7 X 8 20A	720	RECEPTACLES (112)	LIGHTING (130,131,132,133,134,135,136)	539		20A	7 X			720	RECEPTACLES (142)
DRYER (151)		2100 20A 9 X 10 20A	540	RECEPTACLES (112)	DRYER(143)			2100 20A		10 20A		900	RECEPTACLES (128)
WASHING MACHINE (151)		1500 20A 11 X 12 20A	900	RECEPTACLES (111,120)	WASHING MACHINE (143)			1500 20A		12 20A		540	RECEPTACLES (120)
RECEPTACLES (150,151)	1080	20A 13 X 14 20A	720	RECEPTACLE (110,111, EXTERIOR)	RECEPTACLES (139,140,141)		900	20A	13 X			360	RECEPTACLES (138)
RECEPTACLES (154,155,EXTERIOR)	1080	20A 15 X 16 20A	540	RECEPTACLES (158)				1321		16 20A		900	RECEPTACLES (135,137,EXTERIOR)
RECEPTACLES (154,155,EXTERIOR)	720	20A 17 X 18 20A 500		WALL TV (112)	overhead door (138)			1321 30A		18 20A		900	RECEPTACLES (130,131)
	2084	19 X 20 20A	25	EXHAUST FAN EF-2				1321		20 20A		720	RECEPTACLES (136)
VAV 3-7	2084	30A 21 X 22 20A	540	RECEPTACLES (148,152,156)	RECEPTACLES (133,134)		900	20A	21 X	22 20A		540	RECEPTACLES (132, EXTERIOR)
	2084	23 X 24 20A	25	EXHAUST FAN EF-5	EXISTING HONEYWELL JACF		500	20A		24 20A		720	RECEPTACLES (132)
TABLET RECEPTS (100)	540	20A 25 X 26 20A 1840		COMMERCIAL DISHWASHER (145)	EXISTING FACP		500	20A	25 X	26 20A	62		EXHUAST FAN EF-3
TELEVISION (114)		500 20A 27 X 28 20A	138	SITE LIGHTING	EXISTING HVAC #1		160	54 25A	27 X	28 20A	500)	FREEZER (138)
TELEVISION (115)		500 20A 29 X 30 25A 1840		DISPOSAL (150)			160	54		30 20A	500)	FREEZER (138)
DWH-1 (117)	575	20A 31 X 32 20A		SPARE	EXISTING HVAC #2		260	00 40A	31 X	32	2084		
ROOF TOP UNIT RECEPTACLES	360	20A 33 X 34 20A		SPARE			260			34 25A	2084		VAV 2-3
SPARE		20A 35 X 36 20A		SPARE	DWH-1 (144)			1840 20A	35 X		2084		
SPARE		20A 37 X 38 20A		SPARE	PUMP P-2			50 20A	37 X		1458		
SPARE		20A 39 X 40 20A		SPARE			104			40 15A	1458		VAV 2-4
SPARE		20A 41 X 42 20A		SPARE	VAV 2-1		104	15A	41 X		1458		
SPARE		20A 43 X 44 20A		SPARE			104	42	43 X		1458		
SPARE		20A 45 X 46 20A		SPARE			208		45 X		1458		VAV 2-5
SPARE		20A 47 X 48 20A		SPARE	VAV 2-2		208	34 25A	47 X		1458		
SPARE		20A 49 X 50 20A		SPARE			208		49 X		444		GUH-1
SPARE		20A 51 X 52 20A		SPARE	EF-6		69	6 20A	51 X			720	ROOF TOP UNIT RECEPTACLES
SPARE		20A 53 X 54 20A		SPARE	EF-7		69	6 20A	53 X	54 20A			SPARE
	CONNECTED LOAD	DEMAND	DEMAND LOAD			СО	NNECTED LOAD		DEMAND		DEM	AND LOAD	
	ØA ØB ØC TOTAL	FACTOR	ØA ØB ØC TOTAL		LOAD DESCRIPTION		ØB ØC TOT		FACTOR			ØC TOTAL	
LIGHTING LOAD (VOLT-AMPS)	DA DD DC FORM 1082 954 602 2638	1.00	DA DD DC FORM 1082 954 602 2638		LIGHTING LOAD (VOLT-AMPS)		603 500 213		1.00			3 500 2135	
180VA RECEPTACLE LOAD (VOLT-AMPS)	3060 3060 1620 7740	1.00 (FIRST 10kVA)		ECEPTACLE DEMAND FACTOR PER ARTICLE	180VA RECEPTACLE LOAD (VOLT-AMPS)		4860 2160 108		1.00 (FIRST 10k	VA)	3500 450		RECEPTACLE DEMAND FACTOR PER ARTICLE
	AMOUNT OVER 10kVA 0	0.50 (> 10kVA)		20.44 OF THE NATIONAL ELECTRICAL CODE.			OVER 10kVA 80		0.50 (> 10kV/	A)	140 180		220.44 OF THE NATIONAL ELECTRICAL CODE.
CONTINUOUS LOAD (VOLT-AMPS)	2084 2084 2084 6252	1.25	2605 2605 2605 7815		CONTINUOUS LOAD (VOLT-AMPS)		500 1000 200	00	1.25		625 625		
NON-CONTINUOUS LOAD (VOLT-AMPS)	1400 0 25 1425	1.00	1400 0 25 1425		NON-CONTINUOUS LOAD (VOLT-AMPS)		3086 11286 356		1.00			36 11286 35604	
INTERMITTENT USE LOAD (VOLT-AMPS)	1400 0 23 1423 1840 4400 5340 11580	1.00	1400 0 2.0 142.0 1840 4400 5340 11580		INTERMITTENT USE LOAD (VOLT-AMPS)		3421 4661 94		1.00			1 4661 9453	
TOTAL LOAD (kVA)	9.47 10.50 9.67 29.64	125% OF LIGHT, CONT AND RECEPT	9.99 11.02 10.19 31.20	"DANEL DD 1"	TOTAL LOAD (kVA)		22.47 19.61 59.		of light, cont A	AND RECEPT		12 19.78 60.09	"PANEL RP-3"
TOTAL AMPACITY (AMPS)	78.8 87.4 80.5 82.3	(<=10kVA) LOAD PLUS OTHER LOAD	83.2 91.8 84.9 86.6	"PANEL RP-1"	TOTAL AMPACITY (AMPS)		187.1 163.3 160		VA) LOAD PLUS			.6 164.7 166.8	
	91.8 100.1 89.5 93.8	<pre>< PER NEC ARTICLE 215.2></pre>	97.2 105.5 94.9 99.2		MINIMUM FEEDER SIZING (AMPS)		199.5 170.9 170		PER NEC ARTICLE			.6 172.5 177.0	

				A IN .	200		EAKER			208							
PANEL DESIGNATION: PANEL RP-2 PANEL LOCATION: REFER TO PLAN DRAWINGS											LAKEK					OLTAGE	
							BUSS								P-N V	OLTAGE:	
	A: REFER TO						OUND									PHASE:	
FEEDER SIZ	E: REFER IC	J ONE-LII	NE DIAGE	KAM			MOUNT NEUT				E					WIRE:	4
Remarks	LIGHT LOAD	RECEPT LOAD	CONT LOAD	nonC LOAD	IN TER. USE	OC PROT		ØØ AB	Ø C	сст	OC PROT	INTER. USE	nonC LOAD	CONT LOAD	RECEPT LOAD	LIGHT LOAD	Remarks
LIGHTING (102,113,114,115,116,117)	482					20A				2	20A				720		RECEPTACLES (106,107,108,109)
LIGHTING (105,106,107,108,109,119)	480					20A	3	X		4	20A				720		RECEPTACLES (119)
LIGHTING (100,101,103,104)	302					20A	5		Х	6	20A				720		RECEPTACLES (114)
EXTERIOR LIGHTING	314					20A	7)	(8	20A				720		RECEPTACLES (113)
EXTERIOR LIGHTING	124					20A	9	X		10	20A				720		RECEPTACLES (116)
EXTERIOR LIGHTING	236					20A	11		X	12	20A				900		Receptacles (115,117)
RECEPTACLES (118)		540				20A	13)	(14	20A				540		RECEPTACLES (115)
RECEPTACLES (102)		900				20A	15	X		16	20A				900		RECEPTACLES (105)
TELEVISION (105)					500	20A	17		Х	18	20A				1080		RECEPTACLES (100,101,103,104,EXTERIOR)
TELEVISION (100)					500	20A	19 >	(20				2084			
TELEVISION (100)					500	20A	21	X		22	20A			2084			VAV 3-4
			1458				23		X	24	1			2084			
VAV 3-1			1458			15A	25)	(26				1042			
			1458			1	27	X	-	28	15A			1042			VAV 3-5
			1042				29			30				1042			-
VAV 3-2			1042			15A	31)	(32				1042			
			1042			-	33	X		34	15A			1042			VAV 3-6
			1875				35			36				1042			-
VAV 3-3			1875			20A	37)	(38	20A					30	SITE BOLLARD LIGHTING
			1875				39	X	-	40	20A		37				EXHUAST FAN EF-1
EXHAUST FAN EF-4				30		20A	41		x	42	20A	50					PUMP P-1
ROOF TOP UNIT RECEPTACLES		540				20A	43)	(44	20A						SPARE
SPARE						20A	45	X		46	20A						SPARE
SPARE	-					20A	47		x	48	20A						SPARE
SPARE	-					20A	49)	(50	20A						SPARE
SPARE						20A	51	X		52	20A						SPARE
SPARE						20A	53		x		20A						SPARE
						20/1					2071				ļ		
		CONNEC						EMA							ID LOAD		1
	ØA	ØB	ØC	TOTAL			F	ACTO					ØA	ØB	ØC	TOTAL	
IGHTING LOAD (VOLT-AMPS)	827	605	538	1969			1.00	1.00					827	605	538	1969	
180VA RECEPTACLE LOAD (VOLT-AMPS)	3060	3240	2700	9000			1.00 (1						3060	3240	2700	9000	RECEPTACLE DEMAND FACTOR PER ARTICLE
		INT OVER		0			0.50) (> 1(A)			0	0	0	0	220.44 OF THE NATIONAL ELECTRICAL CODE.
CONTINUOUS LOAD (VOLT-AMPS)	8543	8543	8543	25629				1.25					10679	10679	10679	32036	1
NON-CONTINUOUS LOAD (VOLT-AMPS)	0	37	30	67				1.00					0	37	30	67	1
NTERMITTENT USE LOAD (VOLT-AMPS)	500	500	550	1550				1.00					500	500	550	1550	
IOTAL LOAD (kVA)	12.93	12.92	12.36	38.21			of light						15.07	15.06	14.50	44.62	"PANEL RP-2"
TOTAL AMPACITY (AMPS)	107.7	107.6	102.9	106.1							RLOAD		125.4	125.4	120.7	123.9	
MINIMUM FEEDER SIZING (AMPS)	133.5	133.4	127.5	131.5		< F	PER NEC	ARTI	CLE	E 215	2>		155.8	155.6	149.7	153.7	

LECTRICAL CODE.	
RP-1"	

- A. REFER TO ELECTRICAL SPECIFICATIONS FOR ADDITIONAL INFORMATION.
- B. REFER TO ONE-LINE DIAGRAM ON DRAWING EP-600 FOR ADDITIONAL INFORMATION.



1,122,123,143) 25,126,127)	
R (142) (142)	
(128) (120)	
(138) 37,EXTERIOR)	
30,131) (136)	
EXTERIOR) (132)	
EF-3 38) 38)	
00]	
CEPTACLES	
TOR PER ARTICLE	
ECTRICAL CODE.	